

			GENERAL E	QUIPMENT & F	IXTURE SC	HEDUL	E			
SYM.	COND.	QTY.	DESCRIPTION	MANUFACTURER	MODEL	BTU	GAS	ELEC.	COMMI	ENTS
1	Е	2	HAND-SINK	EAGLE					STAINLESS STEEL	NSF COMPLIANT
2	Е	1	3 SINK COMPARTMENT	EAGLE					STAINLESS STEEL	NSF COMPLIANT
3	Е	1	PREP-SINK	EAGLE					STAINLESS STEEL	NSF COMPLIANT
4	Е	1	MOP-SINK	EAGLE					STAINLESS STEEL	NSF COMPLIANT
5	Е	4	OVERSHELF	BY OWNER					STAINLESS STEEL	NSF COMPLIANT
6	Е	1	MOP-RACK AND CHEMICAL SHELF	EAGLE					STAINLESS STEEL	NSF COMPLIANT
7	Е	1	WORK TABLE						STAINLESS STEEL	NSF COMPLIANT
8	Е	1	WATER HEATER (TANKLESS)	TAKAGI	T-H3 MODEL	160.000				NSF COMPLIANT
9	Е	1	AIR CURTAIN					120		NSF COMPLIANT
10	Е	1	LOCKER	BY OWNER						
11	Е	1	METAL SHELF (5 SHELF STACKS)	BY OWNER					STAINLESS STEEL	NSF COMPLIANT
12	Е	1	FREEZER	AVANTCO				120		NSF COMPLIANT
13	Е	1	12' HOOD	CAPTIVE AIR				20	STAINLESS STEEL	NSF COMPLIANT
14	Е	1	WORK TABLE	EAGLE					STAINLESS STEEL	NSF COMPLIANT
15	Е	1	REFRIGERATOR	AVANTCO				120		NSF COMPLIANT
16	Е	1	SANDWICH TABLE	AVANTCO				120		NSF COMPLIANT
17	Е	1	GREASE INTERCEPTOR	ASHLAND	4800					
18	Е	1	WARMER FOOD	TABCO				120		NSF COMPLIANT
19	Е	1	FIRE EXTINGUISHER	BY OWNER						
20	Е	1	ICE MACHINE - SODA DISPENSER	DRODIGY				120		NSF COMPLIANT
21	Е	1	ELECTRIC FRY WARMER	AVANTCO	FFDS-1		3/4"	120		NSF COMPLIANT
22	Е	1	CHARBROILER	CPG	CBL24	80.000	3/4"			NSF COMPLIANT
23	Е	1	DEEP FRYER	AVANTCO		60.000	3/4"			NSF COMPLIANT
24	Е	1	6 BURNERRANGE	CPG	351536	100.000	1"			NSF COMPLIANT
25	Е	1	GAS CONVEYOR OVEN	LINCOLN		80.000	1"			NSF COMPLIANT
26	Е	2	FLOOR SINK	BY OWNER						NSF COMPLIANT
27	Е	1	FLOOR DRAIN	BY OWNER						NSF COMPLIANT
28	N	1	PASTRY WORK TABLE						STAINLESS STEEL	NSF COMPLIANT
29	Е	1	WARD SPLASH	BY OWNER					STAINLESS STEEL	NSF COMPLIANT
30	Е	2	VERTICAL BROILER	AXIS		34.000		120		NSF COMPLIANT
31	Е	1	COOKSTAND REFRIGERATOR	AVANTCO				120		NSF COMPLIANT
32	Е	1	MIXER 60 QT	EURODIB	M60A			208		NSF COMPLIANT



RESTAURANT EXPANSION & TENANT IMPROVEMENT

NOTE: ALL EXISTING KITCHEN EQUIPMENT TO REMAIN.

168-170 W WILLOW ST, POMONA, CA 91768

Issue For Description:

3RD PC
CORRECTION

Date: 01/31/2024

ISSUED FOR 3RD PC CORRECTION 01/31/2024

Principal In Charge:
Project Manager:

Drawn By:
PO
Project Number

Project Number

Designer's Signatur

GOLNARGES M.
SABET

C-33474

OB-31-202

RENNERAL


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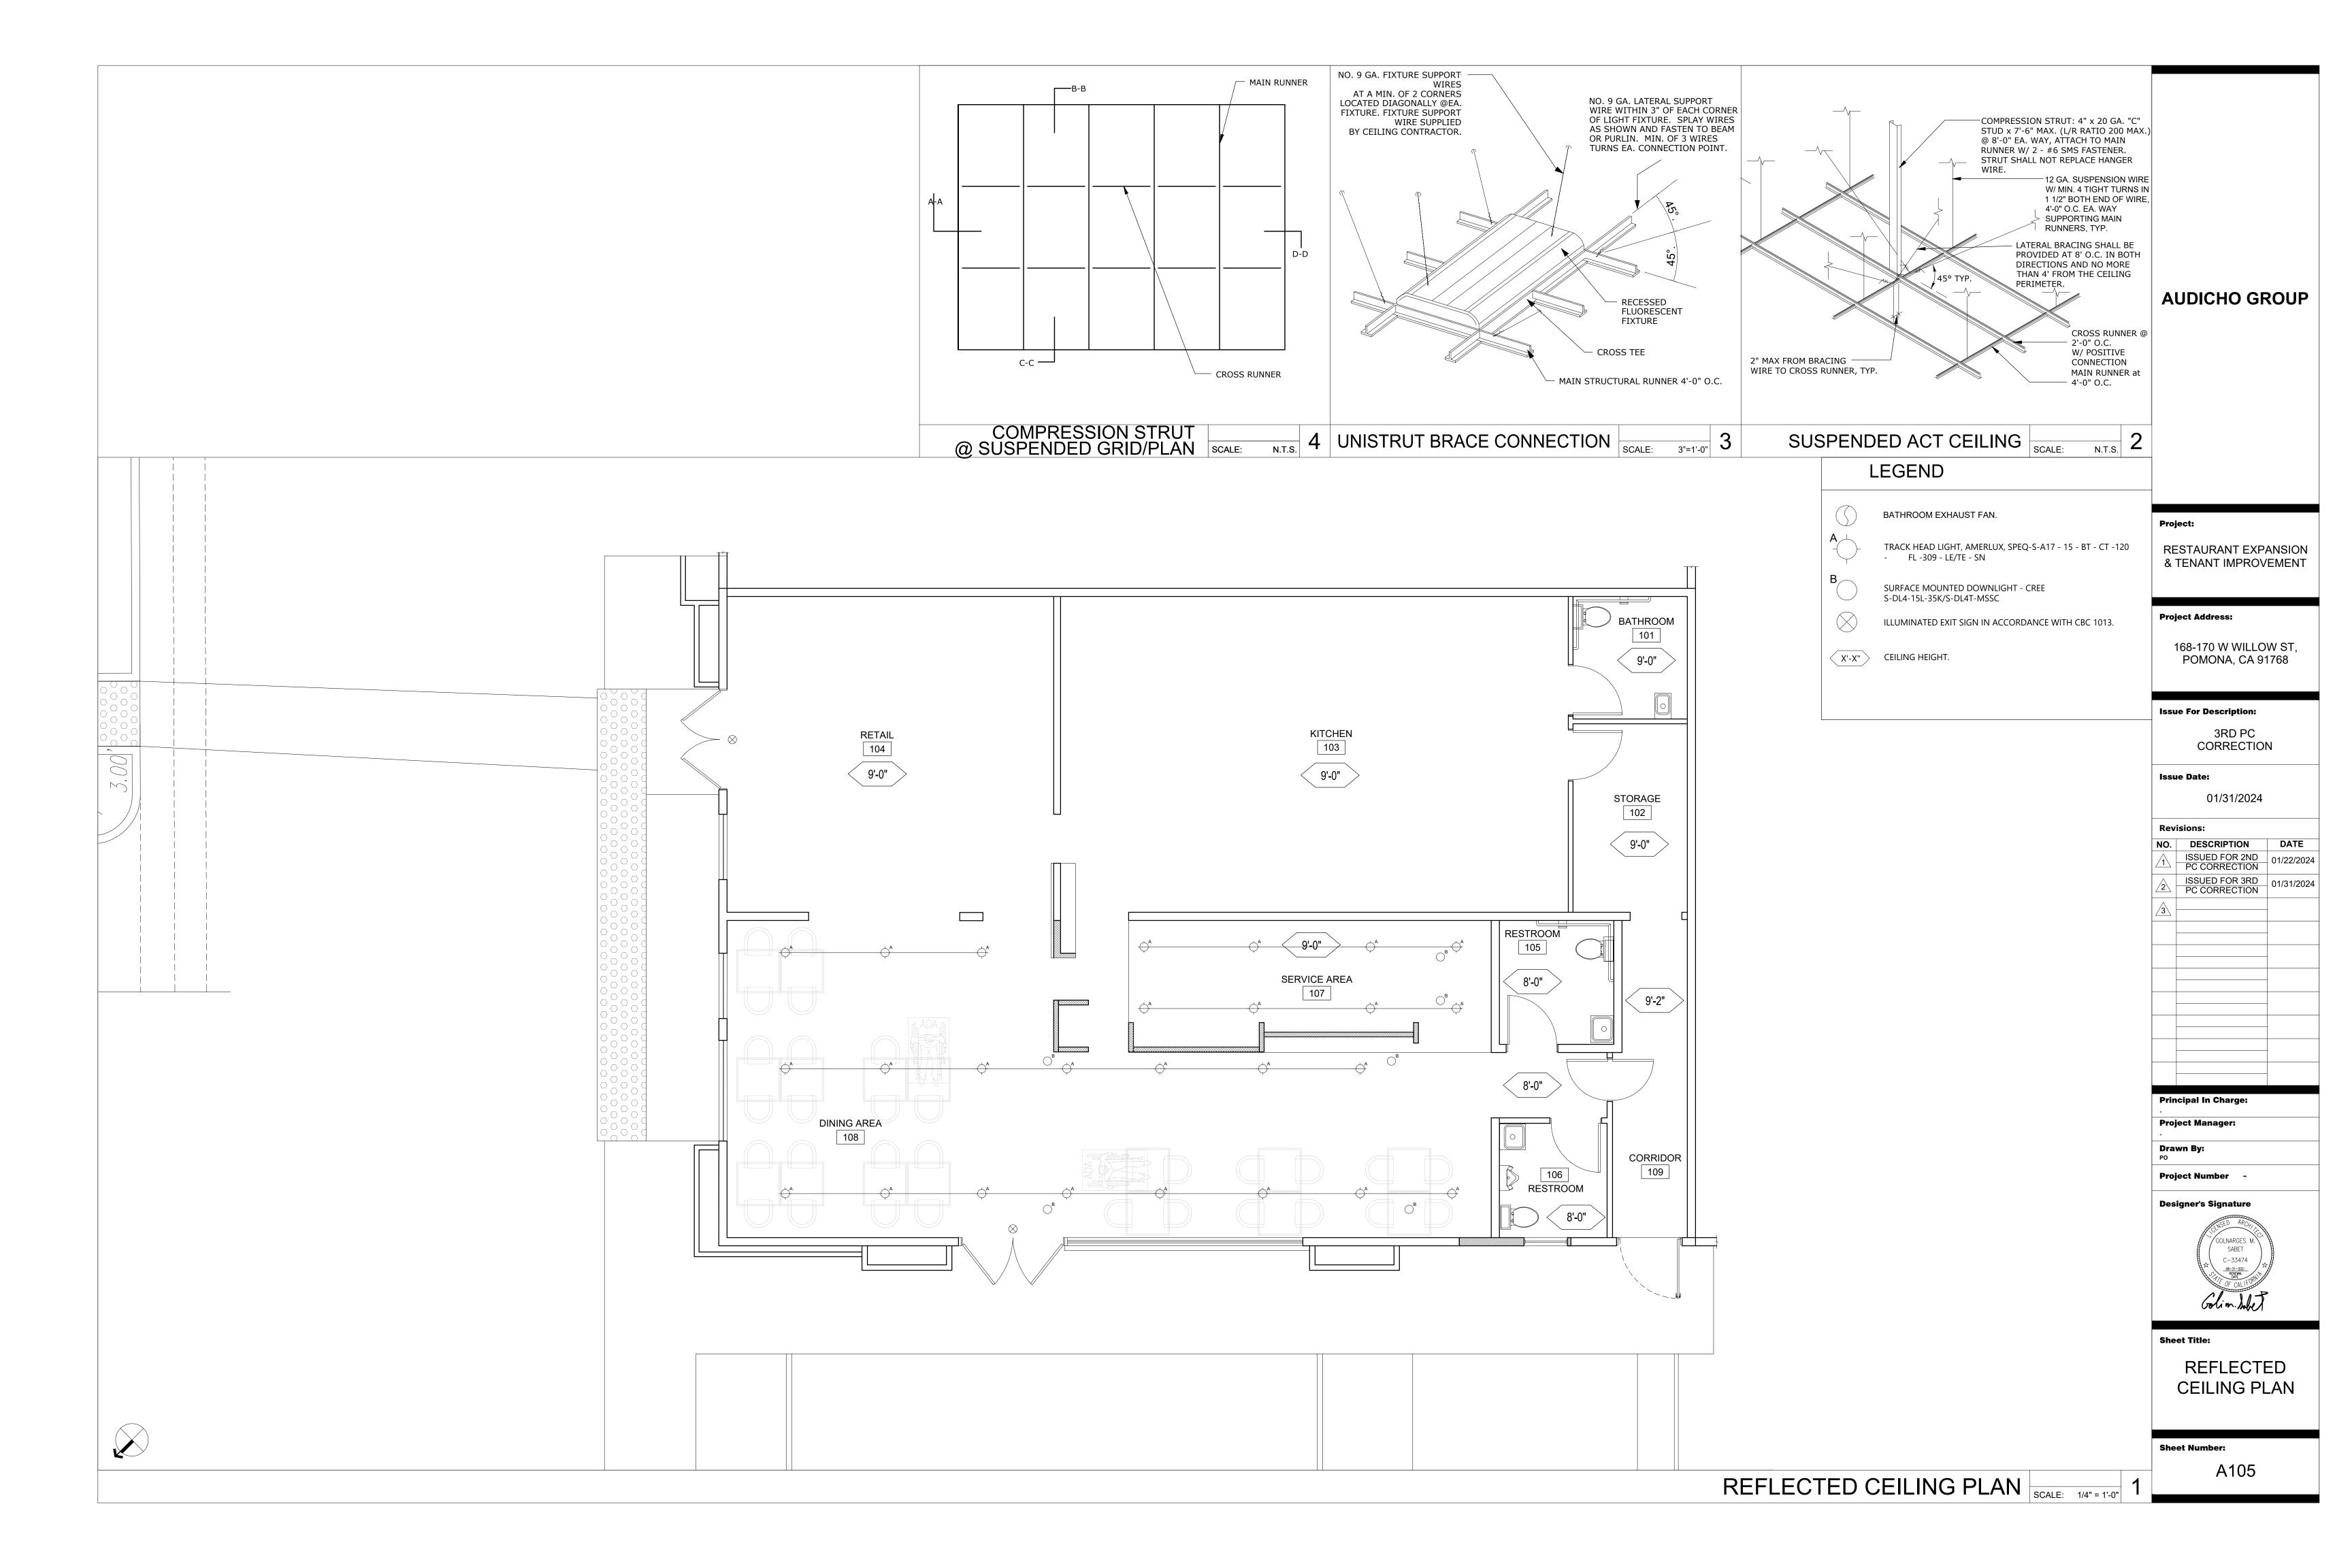
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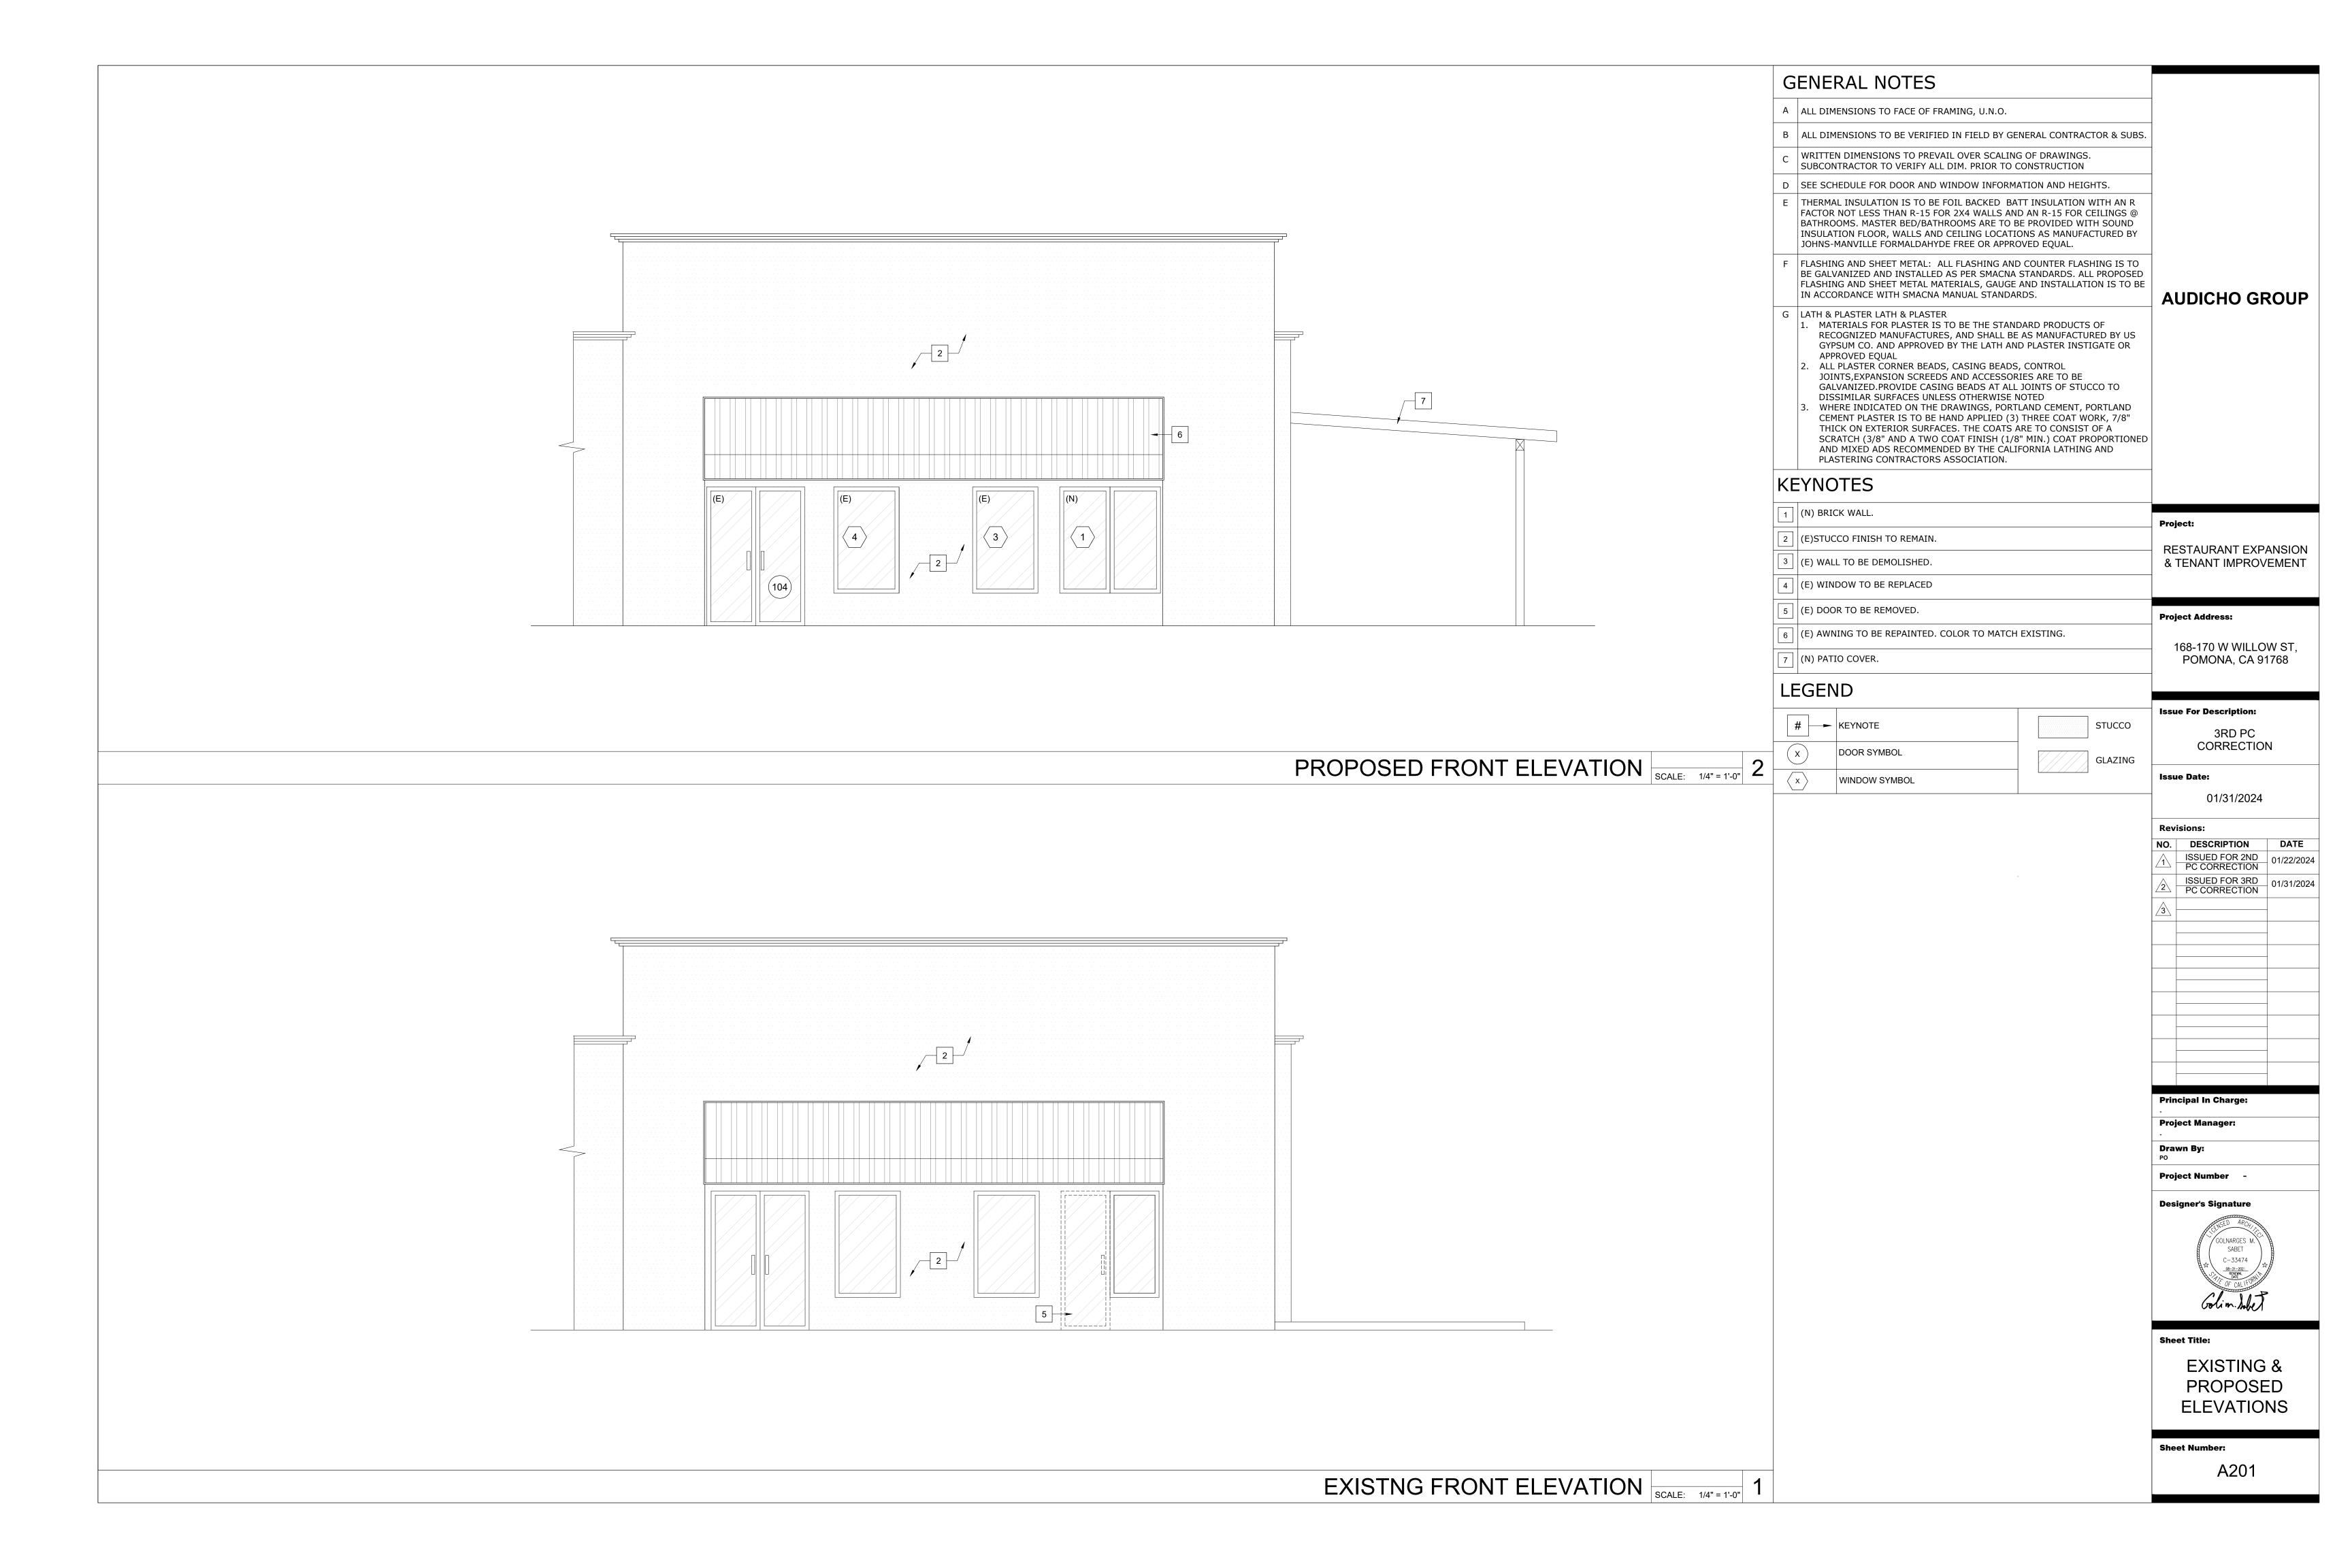
FURNITURE & EQUIPMENT PLAN


Sheet Number:

FURNITURE & EQUIPMENT PLAN SCALE: 1/4" = 1'-0" 1





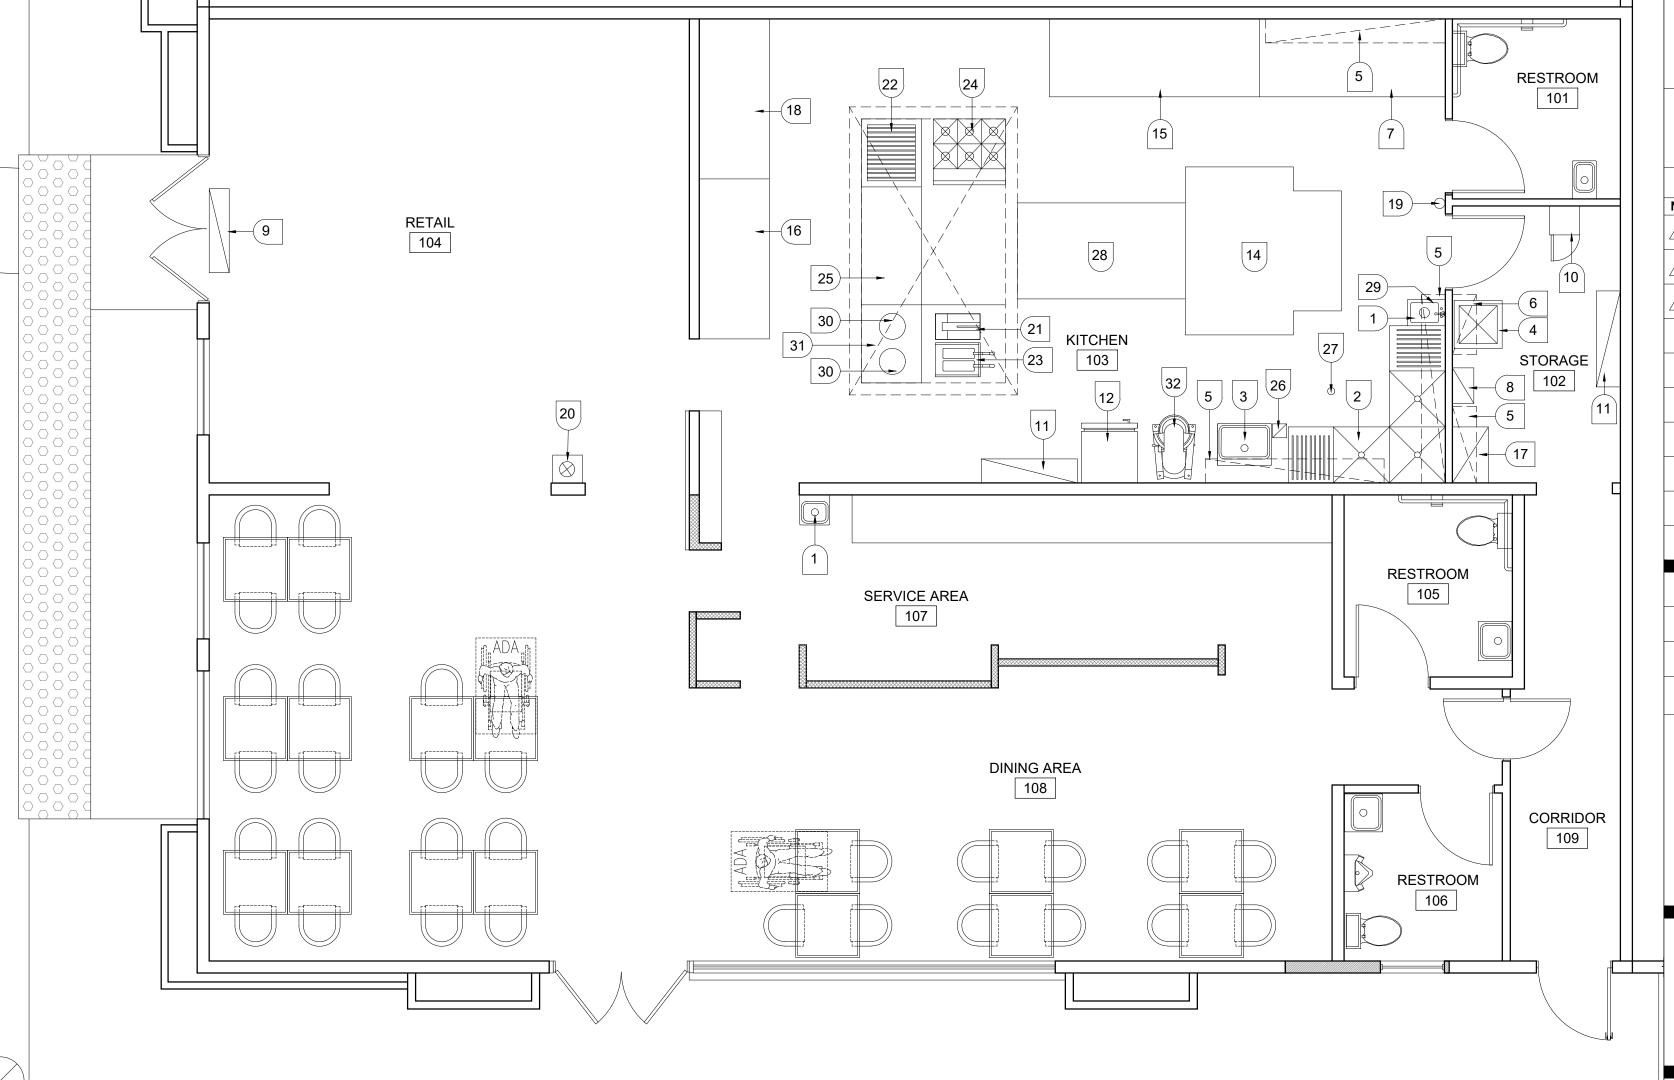

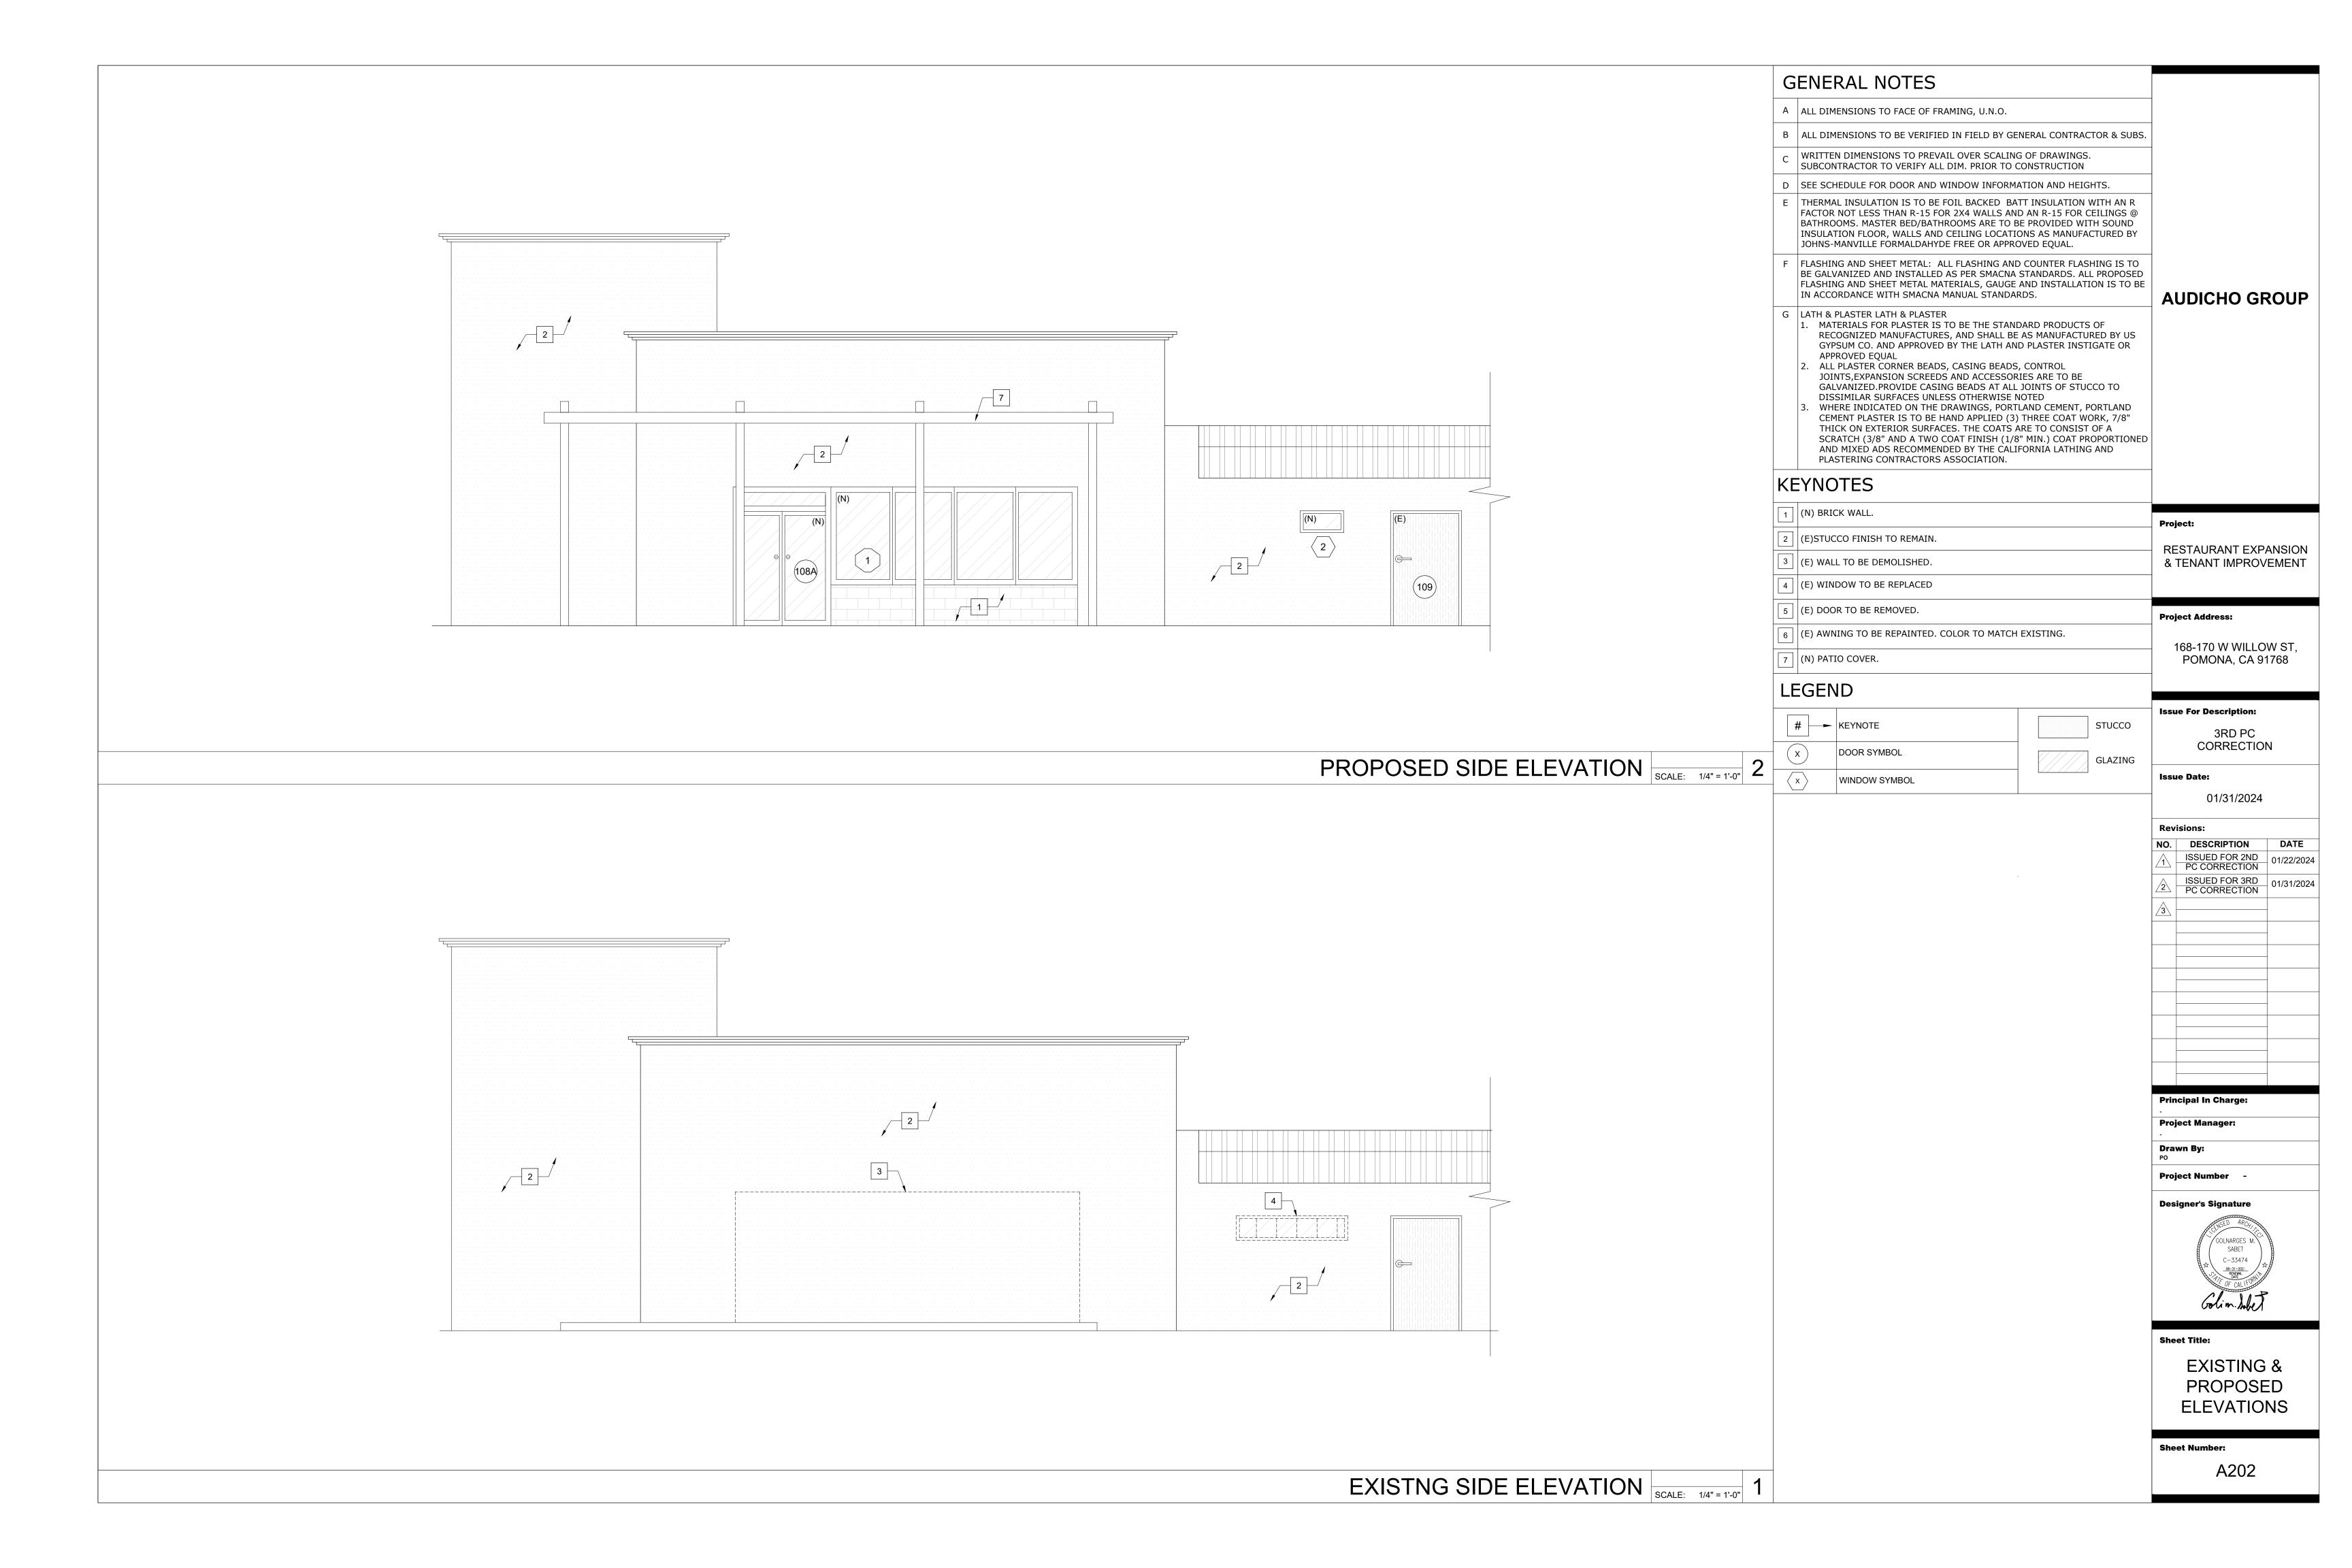

				DOOR S	CHEDULE						WI	NDOW	SCHEDULE			STOREFF	RONT S	SCHEDULE		
DOOR STATUS	DOOR TYPE	WIDTH	DOOF		MATERIALS	HARDWARE SET	REMARKS	WINDOW STATU	S WINDOW TYPE		WINDOW SIZ	E SILL HEIGHT	MATERIAL	REMARKS	NUM. WIDTH HEIG	GHT SILL HEIGHT 1	THICK.	MATERIALS	REMARKS	
101 (E)	SWING DOOR	3'-0"	6'-	" 1 ³ / ₄ "	WOOD	2		1 (N)	FIXED	6'-0"	6'-6"	2'-0"	ALUMINUM FRAME W/ GLASS PANEL		1 21'-1" 6'-	-0" 2'-6"	2'-0" AL	UMINUM FRAME W/ GLASS PANEL	PROVIDE TEMPERED GLASS	
102 (E)	SWING DOOR	3'-0"	6'-	1 ³ / ₄ "	WOOD	3		2 (N)	FIXED	2'-8"	1'-5"	5'-8"	ALUMINUM FRAME W/ GLASS PANEL							
104 (E)	EXTERIOR SWING DOOR	6'-0"	8'-	" 1"	ALUMINUM FRAME W/ GLASS PANE	L 1		3 (E)	FIXED	4'-0"	6'-6"	2'-0"	ALUMINUM FRAME W/ GLASS PANEL							
105 (E)	INTERIOR SWING DOOR	3'-0"	6'-	" 1 ³ / ₄ "	WOOD	2	PROVIDE TEMPERED GLASS.	4 (E)	FIXED	4'-0"	6'-6"	2'-0"	ALUMINUM FRAME W/ GLASS PANEL							
106 (E)	INTERIOR SWING DOOR	3'-0"	6'-	1 3 "	WOOD	2														
108A (N)	EXTERIOR SWING DOOR	6'-8"	7'- W/ TRAN	0	ALUMINUM FRAME W/ GLASS PANE	L 1	PROVIDE TEMPERED GLASS.													AUDICHO GROUP
108B (E)	INTERIOR DOUBLE SWING D	OOR 2'-8"	2'-	' 0.063"	STAINLESS STEEL	5	ELIASON® DSP-3 TRAFFIC DOOR. BODY: 16 GAUGE STAINLESS STEEL WITH DELTA VERTICAL EDGES FINISH:16 GAUGE STAINLESS STEEL (BOTH S HINGE: ELIASON EASY SWING® HINGE SYS	IDES)												
109 (E)	EXTERIOR SWING DOOR	3'-0"	6'-	" 1 ³ / ₄ "	WOOD	4														
HARDW	ARE SCHEDUL			OOR NC	TES		V	VINDOW NOTES					SAFETY	LAZING NOTI	ES					
SET NO.1 (ENTRY • TOP PIVOT	GLASS DOOR) W/CONCEALED CLOSER		1.	UNDERCUTTING S	HALL BE DONE AT JOB SÌTE SPÉCIFICALI	LY FOR EACH DO	RFACES OF FINISHED FLOOR THRESHOLD. ALL DR OPENING AND FLOOR FINISH. CONTRACTOR 2.	SEE CONSTRUCTION PLAN AND ELE	WATERPROOFING.				DESIGNATION, THE					IRERS DESIGNATION SPECIFYING WHALL BE CONSIDERED SPECIFIC HAZ		_ <u>=</u>
BOTTOM P VERTICAL FLOOR STO	PULL HANDLES		2.	U.O.N., ALL DOOR RECEIVE ONE ANI	OONE HALF PAIRS OF BUTTS, 8'-0" AND H	GES, HAGER OR A		INCLUDE ADDITIONAL STRUCTURAL PROVIDE SEALANT TO MATCH FRAM INCLUDE WEEP HOLES INSIDE FRAM	E COLOR, TYP.											
SET NO. 2 (TOILE HINGES LEVER HAN FLOOR STO	NDLED LOCKSET W/OCCUPANCY LO		MS 3. 4. 5. 6. 7. 8.	(INCLUDING THRE OPENINGS. INSTALL DOME ST ALL RATED DOOR ALL DOORS SEAL: SHOP DRAWINGS ALL EXISTING 3'-0 NEW AS REQUIRE VERIFY CONDITIO	SHOLDS, ASTRAGALS, COORDINATORS, OP RISERS WHERE REQUIRED BY INDICAS SHALL HAVE GASKETS AND THRESHOLD AT FIRE RATED CONDITION MUST COMIFROM DOOR SUB-CONTRACTOR SHALL I DOORS AND FRAMES ARE TO BE RE-USD. N OF EXISTING DOORS PRIOR TO PRICIN	CLOSERS, ETC.) ATED FLOOR FINIS DS PER CODE REPLY TO THE CURF NDICATES STYLE ED, U.O.N. VERIFY	EQUIREMENTS. RENT CBC STANDARD AND ANY LOCAL CODES. 8. 9.	PROVIDE SHOP DRAWINGS & WINDO G.C. SHALL FIELD VERIFY ALL LOCA ORDERING MATERIAL. ALL PAINTED SURFACES SHALL BE (SEE GENERAL NOTES FOR MORE IN	TIONS & VERIFY W.A.I				A. SWING DOORS B. FIXED AND SLI C. STORM DOOR D. UNFRAMED SV E. DOORS AND E F. FIXED OR OPE OF THE DOOR	IDING PANELS OF SLIDING DO S. WINGING DOORS. ENCLOSURES FOR HOT TUBES ERABLE PANELS ADJACENT TO IN A CLOSED POSITION AND		AM ROOMS, BATHTUBS ST EXPOSED EDGE OF DSED POSITION AND W	S, AND SHOWE			Project: RESTAURANT EXPANSION & TENANT IMPROVEMENT
HINGESLEVER HANFLOOR STO			9.	SEE DOOR SCHEE	ORS ARE TO BE CLEANED, REPAIRED ANI OULE FOR REFERENCE OF NEW OR EXIST VARE, ALL DOORS ARE NEW UNLESS OTH	TING RELOCATED HERWISE NOTED.							G. FIXED OR OPE INSTALLATION	١).	DESCRIBED IN ITEMS E AND F	, WHICH MEETS ALL OF	F THE FOLLOW	VING CONDITIONS (READ CODE FOR	R EXCEPTION WITH SPECIAL	Project Address:
SET NO. 4 (EXTER			10.	ALL NEW ALUMINI FINISHED: CLEAR		INTEGRATED, W/	FULL FACE, U.O.N. FINISH TO BE FACTORY						;\ EVD00	PED ADEA OF AN INDIVIDUAL F	NAME ODEATED THAN O COLLAR	DE EEET (0.04 MO)				
HINGESLEVER HANFLOOR STO	DLED LOCKSET		11.	CONTRACTOR SH DRILLING OF PATH REQUIRED.	ALL BORE DOORS AND PREP. FRAME FOI HWAY SHALL BE PROVIDED BY A LICENSE	ED CONTRACTOR	DER AS SHOWN ON POWER AND DATA PLAN. PROVIDE ELECTRIC HINGE AND LOCK AS						ii)EXPOSED BO iii) EXPOS iv) ONE OI H. GUARDS AND	OTTOM EDGE LESS THAN 18 IN SED TOP EDGE GREATER THA IR MORE WALKING SURFACES	PANE GREATER THAN 9 SQUAF NCHES (457MM) ABOVE THE FL N 36 INCHES (914 MM) ABOVE WITHIN 36 INCHES (914 MM) F REA OR HEIGHT ABOVE A WAL	LOOR. THE FLOOR. HORIZONTALLY OF THE		HE GLAZING. TRUCTURAL BALUSTER PANELS ANI	ND NONSTRUCTURAL INFILL	168-170 W WILLOW ST, POMONA, CA 91768
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- ANCHOR BOLTS

– STEEL PLATE DIMENSION AS REQUIRED


PARTIAL HEIGHT WALL DETAIL SCALE: 3"=1'-0" 2

Drawn By: Project Number -—2X P.T.D.F. BOTTOM PLATE Designer's Signature NOTE:
REFER TO STRUCTURAL DETAILS FOR BOTTOM
OF WALL AND TOP OF WALL CONNECTIONS Sheet Title:

EXTERIOR 2-HR RATED WALL DETAIL SCALE: 3"=1'-0" 1

ARCHITECTURAL DETAILS

Sheet Number: A401

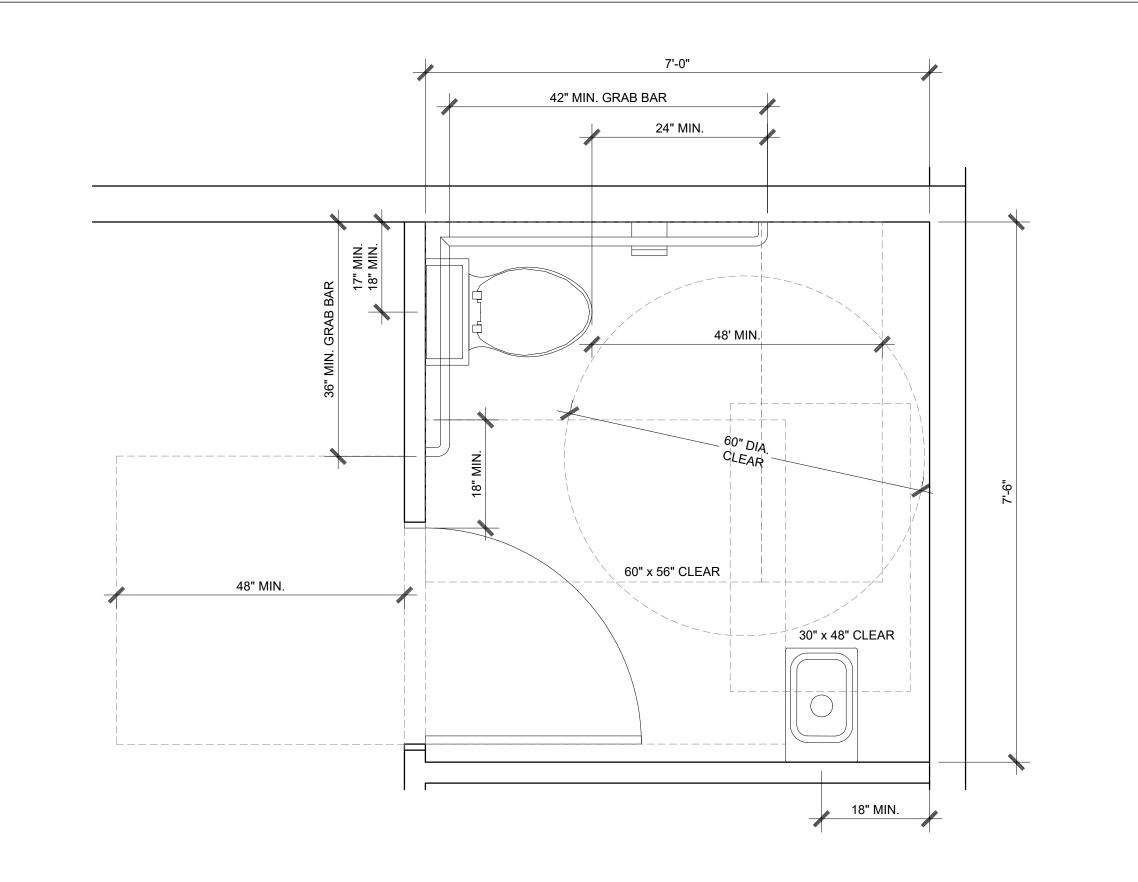

RESTROOM TYP. NOTES

- A. ALL FIXTURES SHALL BE INSTALLED PER ADA REQUIREMTNS AND SPECIFICATIONS.
- B. INSTALL 5/8" WATER RESISTANT GYP. BD. ON INTERIOR SHOWER ROOM WALLS.
- C. ALL WALLS SHALL BE A MINIMUM THICKNESS FOR PLUMBING FIXTURES AND ACCESSORIES PER SPECIFICATIONS.
- D. FLOAT WALL AS REQ'D FOR ALL FINISHED SURFACES TO BE FLUSH.
- E. ALL SPECIFIED TILES TO BE INSTALLED IN FULL SIZES U.O.N.
- F. PLUMBING ENGINEER SHALL VERIFY CLEARANCES REQ'D FOR PLUMBING FIXTURES.
- G. AT ALL PIPING, PROVIDE SWAY BRACING FOR SEISMIC PROTECTION AS REQ'D BY CODE.
- H. PROVIDE ANTI-FRACTURE MEMBRANE BENEATH TILE.
- I. ALIGN GROUT LINES ON WALL TO THE GROUT LINES ON FLOOR.
- J. RESTROOM SIGNS TO BE INSTALLED PER SHEET A009.
- K. THE INSIDE AND OUTSIDE OF THE TOILET COMPARTMENT DOOR SHALL BE EQUIPPED WITH A LOOP OR U-SHAPED HANDLE IMMEDIATELY BELOW THE LATCH. THE LATCH SHALL BE FLIP-OVER STYLE, SLIDING OR OTHER HARDWARE NOT REQUIRING THE USER TO GRASP OR TWIST. (PER CBC 1115B.3.1.4.5).
- . PROVIDE SCHLUTER JOLLY PROFILE AT ALL RESTROOM WALL/ FLOOR TRANSITIONS.
- M. REFER TO SHEET A009 FOR TYP. MOUNTING HEIGHTS.
- N. THE STRUCTURAL STRENGTH OF GRAB BARS, TUB AND SHOWER SEATS, FASTENERS AND MOUNTING DEVICES SHALL MEET THE FOLLOWING SPECIFICATIONS:
- N.A. BENDING STRESS IN A GRAB BAR OR SEAT INDUCED BY MAXIMUM BENDING MOVEMENT FROM THE APPLICATION OF 250 LBS/SF (1112N) SHALL BE NO LESS THAN THE ALLOWABLE STRESS FOR THE MATERIAL OF THE GRAB BAR OR SEAT.
- N.B. SHEAR STRESS INDUCED IN THE GRAB BAR OR SEAT BY THE APPLICATION OF 250 LBS/SF (1112N) SHALL BE LESS THAN THE ALLOWABLE SHEAR STRESS FOR THE MATERIAL OF THE GRAB BAR SEAT AND ITS MOUNTING BRACKET OR OTHER SUPPORT IS CONSIDERED TO BE FULLY RESTRAINED, THEN DIRECT AND TORSIONAL SHEAR STRESSES SHALL NOT EXCEED THE ALLOWABLE SHEAR STRESSES.
- N.C. SHEAR FORCE INDUCED IN FASTENER OR MOUNTING DEVICE FROM THE APPLICATION OF A 250 LB POINT LOAD SHALL BE LESS THAN THE ALLOWABLE LATERAL LOAD OF EITHER THE FASTENER OR MOUNTING DEVICE OR THE SUPPORTING STRUCTURE, WHICH EVER IS THE SMALLER ALLOWABLE LOAD.
- N.D.TENSILE FORCE INDUCED IN A FASTENER BY DIRECT TENSION FORCE OF 250LB POINT LOAD, PLUS THE MAXIMUM MOMENT FROM THE APPLICATION OF A 250 LB POINT LOAD, SHALL BE LASS THAN THE ALLOWABLE WITHDRAWAL LOAD BETWEEN THE FASTENER AND THE SUPPORTING STRUCTURE.
- N.E. GRAB BARS SHALL NOT ROTATE WITHIN THEIR FITTINGS.

AUDICHO GROUP

iect:

RESTAURANT EXPANSION & TENANT IMPROVEMENT

Project Address:

168-170 W WILLOW ST, POMONA, CA 91768

Issue For Description:

3RD PC

CORRECTION

Issue Date:

01/31/2024

Revisions:

NO. DESCRIPTION DATE

| ISSUED FOR 2ND | 01/22/2024 | PC CORRECTION | 01/31/2024 |
| 2 | ISSUED FOR 3RD | PC CORRECTION | 01/31/2024 |


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Project Manage

Drawn By:

Project Number

Designer's Signat

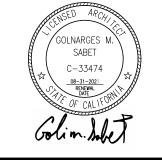

Sheet Title:

ADA RESTROOM ENLARGED PLANS

A501

