CITY OF POMONA PUBLIC WORKS DEPARTMENT / ENGINEERING DIVISION **CONSTRUCTION PLANS FOR** LINCOLN PARK IMPROVEMENTS PROJECT NO. 428-81055



GENERAL NOTES:


- 1. ALL WORK SHALL CONFORM TO THE LATEST EDITION OF STANDARD SPECIFICATIONS FOR PUBLIC WORKS CONSTRUCTION (THE GREENBOOK), STANDARD PLANS FOR PUBLIC WORKS CONSTRUCTION (A.P.W.A. STANDARDS), AND STANDARDS OF THE CITY OF POMONA PUBLIC WORKS DEPARTMENT.
- 2. APPLICATION FOR EXCAVATION AND INSPECTION IN CONNECTION WITH WORK SHOWN ON THIS PLAN MUST BE MADE BY THE CONTRACTOR AT LEAST TWENTY-FOUR (24) HOURS PRIOR TO STARING ANY WORK.
- 3. WORK IN PUBLIC STREETS ONCE BEGUN SHALL BE PROSECUTED WITHOUT DELAY SO AS TO PROVIDE MINIMUM INCONVENIENCE TO ADJACENT PROPERTY OWNERS AND THE TRAVELING PUBLIC.
- 4. TRAFFIC CONTROL SHALL BE MAINTAINED IN ACCORDANCE WITH THE CALIFORNIA MUTCD.
- 5. CONTRACTOR SHALL IMPLEMENT DUST CONTROL MEASURES AT ALL TIMES.
- 6. CONTRACTOR SHALL PROTECT EXISTING IRRIGATION LINES AND SPRINKLER HEADS BEHIND EXISTING CURB. THE CONTRACTOR SHALL REPLACE ANY DAMAGED LINES AND SPRINKLER HEADS AT HIS OWN EXPENSE.
- 7. CONTRACTOR SHALL REPLACE TRAFFIC STRIPES, LEGENDS, LOOP DETECTORS AND MARKINGS DAMAGED DURING THE CONSTRUCTION OF THIS PROJECT. TRAFFIC STRIPES, PAVEMENT LEGENDS, RAISED PAVEMENT MARKERS AND LOOP DETECTORS SHALL BE PER THE 2010 CALIFORNIA MUTCD, CALTRANS STANDARD PLANS AND CALTRANS STANDARD SPECIFICATIONS 84, 85, AND 86, LATEST EDITIONS.
- 8. REFLECTORIZE ALL STRIPES AND LEGENDS. PAVEMENT MARKINGS SHALL BE THERMOPLASTIC AND SHALL MATCH CITY STENCILS, OR CALTRANS STANDARDS.
- 9. TRAFFIC STRIPES AND MARKINGS SHALL BE THERMOPLASTIC.
- 10. STRIPING SHALL BE CAT-TRACKED AND APPROVED BY THE CITY TRAFFIC ENGINEER PRIOR TO FINAL INSTALLATION.
- 11. CONTRACTOR SHALL RE-STRIPE EXISTING STRIPING, MARKING ALL INTERSECTING, AND JOINING STREETS WITHIN 100' OF LIMITS OF PROJECT.
- 12. TYPE DB 2-WAY BLUE REFLECTIVE MARKERS SHALL BE INSTALLED ADJACENT TO EXISTING FIRE HYDRANTS WITHIN THE LIMITS OF CONSTRUCTION PER STATE AND CITY STANDARDS.
- 13. AS BUILTS OF THE COMPLETED PROJECT SHALL BE SUBMITTED FOR APPROVAL OF THE CITY ENGINEER.
- 14. CONTRACTOR SHALL NOTIFY ALL AFFECTED RESIDENCES IN WRITING AT LEAST TOW (2) FULL WORKING DAYS BEFORE ANY START OF CONSTRUCTION AS SPECIFIED.
- 15. CONTRACTOR SHALL CONTACT UNDERGROUND SERVICE ALERT (DIG ALERT) AT 811, TWO (2) FULL WORKING DAYS PRIOR TO START OF WORK. THE CONTRACTOR MUST OBTAIN AND MAINTAIN VALID DIG ALERT REFERENCE NUMBER THROUGH THE LIFE OF THE PROJECT AS NECESSARY FOR CONSTRUCTION
- 16. CONTRACTOR SHALL PROJECT ALL CENTERLINE SURVEY MONUMENT AND CENTERLINE TIES AS SPECIFIED.
- 17. EXISTING STRIPES AND MARKINGS TO BE REMOVED SHALL BE DONE BY WET SANDBLASTING.
- 18. THE LOCATION OF EXISTING UTILITIES IS SHOWN IN AN APPROXIMATE WAY ONLY. THE CONTRACTOR SHALL DETERMINE THE EXACT LOCATION OF ALL EXISTING UTILITIES PRIOR COMMENCING WORK. THE CONTRACTOR SHALL BE FULLY RESPONSIBLE FOR ANY AND ALL DAMAGES, WHICH MIGHT BE OCCASIONED BY THE FAILURE TO EXACTLY LOCATE AND PRESERVE ANY AND ALL UNDERGROUND UTILITIES.
- 19. CONTRACTOR SHALL USE BEST MANAGEMENT PRACTICES (BMP'S) TO CONTROL EROSION AND SEDIMENT AND PRESERVE WATER QUALITY TO THE MAXIMUM EXTENT POSSIBLE.
- 20. THE CITY OF POMONA WILL USE COBBLESTONE AND DECOMPOSED GRANITE (DG) WITHIN THE BULB-OUT AREAS AS AN ALTERNATE LANDSCAPE MATERIAL FOR THE PROJECT IN THE EVENT THAT A RESIDENT DOES NOT REACH AN AGREEMENT WITH THE CITY FOR THEIR REQUESTED LANDSCAPE MATERIAL OR DOES NOT PROVIDE THE NECESSARY RIGHT OF ENTRY.

ABBREVIATIONS & SYMBOLS

¢ ♥ ♥ S ♥ S G V E E E V C T L B F V T L C B	STREET LIGHT FIRE HYDRANT MANHOLE WATER VALVE SIGN TREE SEWER WATER STORM DRAIN GAS GAS VALVE ELECTRIC ELECTRIC PULL BOX ELECTRIC VAULT DETECTOR CHECK TELEPHONE STREET LIGHT STREET LIGHT STREET LIGHT PULL BOX FIRE HYDRANT VENT PIPE TRAFFIC LIGHT TRAFFIC CONTROL PULL BOX	INV. PROP. HORIZ. VERT. EX. EXIST. MH DWG DWY. TEL. ELECT. NO. CONC. STD. € FT. ST. AB AC DEPT.	RETAINING INVERT PROPOSED HORIZONTAL VERTICAL EXISTING EXISTING MANHOLE DRAWING DRIVEWAY TELEPHONE ELECTRICAL NUMBER CONCRETE STANDARD CENTER LINE FEET STREET AGGREGATE BASE ASPHALT CONCRETE DEPARTMENT PROJECT VITRIFIED CLAY PIPE
CB P CF MAX. PT. FS E TC NEC BCR	CURB FACE MAXIMUM POINT FINISH SURFACE FLOW LINE TOP OF CURB NORTHEAST CORNER BEGIN CURB RADIUS HEIGHT		BOTTOM OF PIPE TOP OF PIPE GRADE BRAKE RIGHT OF WAY BACK OF WALK TOP OF GRATE CABLE TV LATERAL JUNCTION STRUCTURE BEGINNING CURVE END OF CURVE ASPHALT RUBBER HOT MIX
RCP TC PSI PCC	Ϋ́Υ,	GG D)	GAP GRADED

SHEET INDEX

1	TITLE SHEET & GENERAL NOTES
2	INDEX MAP, TYPICAL SECTIONS AND QUANTITIES
3	DETAIL PLAN - INTERSECTION OF LINCOLN AVE./COMO DR. & PALOMARES ST.
4	DETAIL PLAN - INTERSECTION OF JEFFERSON AVE./COMO DR. & JEFFERSON AVE.
5	DETAIL PLANS - INTERSECTIONS OF COMO DRJEFFERSON AVEPALOMARES ST.
6	DETAIL PLANS - INTERSECTIONS OF LINCOLN AVE. & PALOMARES ST.
7	CURB RAMP DETAILS
8	CURB RAMP DETAILS
9	SIGNING AND STRIPING PLAN
10	PAVEMENT REHAB, SIDEWALK & CURB REPAIR AND DG PATH HORIZONTAL CONTROL
LI-01	IRRIGATION PLAN
LI-02	SPARE
LI-03	IRRIGATION LEGEND AND NOTES
LI-04	IRRIGATION DETAIL
LP-01	PLANTING REFERENCE PLAN
LP-02	SPARE
LP-03	SPARE
ST-01	SPARE
ST-02	SPARE
ST-03	SPARE

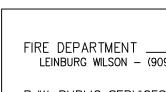



- & DEVELOPMENT DIVISION .




SECTION 4216/4217 OF THE GOVERNMENT CODE REQUIRES A DIGALERT IDENTIFICATION NUMBER BE ISSUED BEFORE A PERMIT TO EXCAVATE' WILL BE VALID. FOR YOUR DIGALERT I.D. NUMBER CALL UNDERGROUND SERVICE ALERT TOLL FREE TWO WORKING DAYS BEFORE YOU DIG.

CAUTION: REMEMBER THAT THE USA CENTER NOTIFIES ONLY THOSE UTILITIES BELONGING TO THE CENTER. THERE COULD Call two working before you dig. BE OTHER UTILITIES PRESENT AT THE WORK SITE. THE CENTER WILL INFORM YOU OF WHOM THEY WILL NOTIFY.

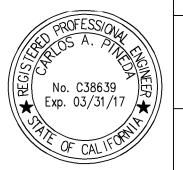

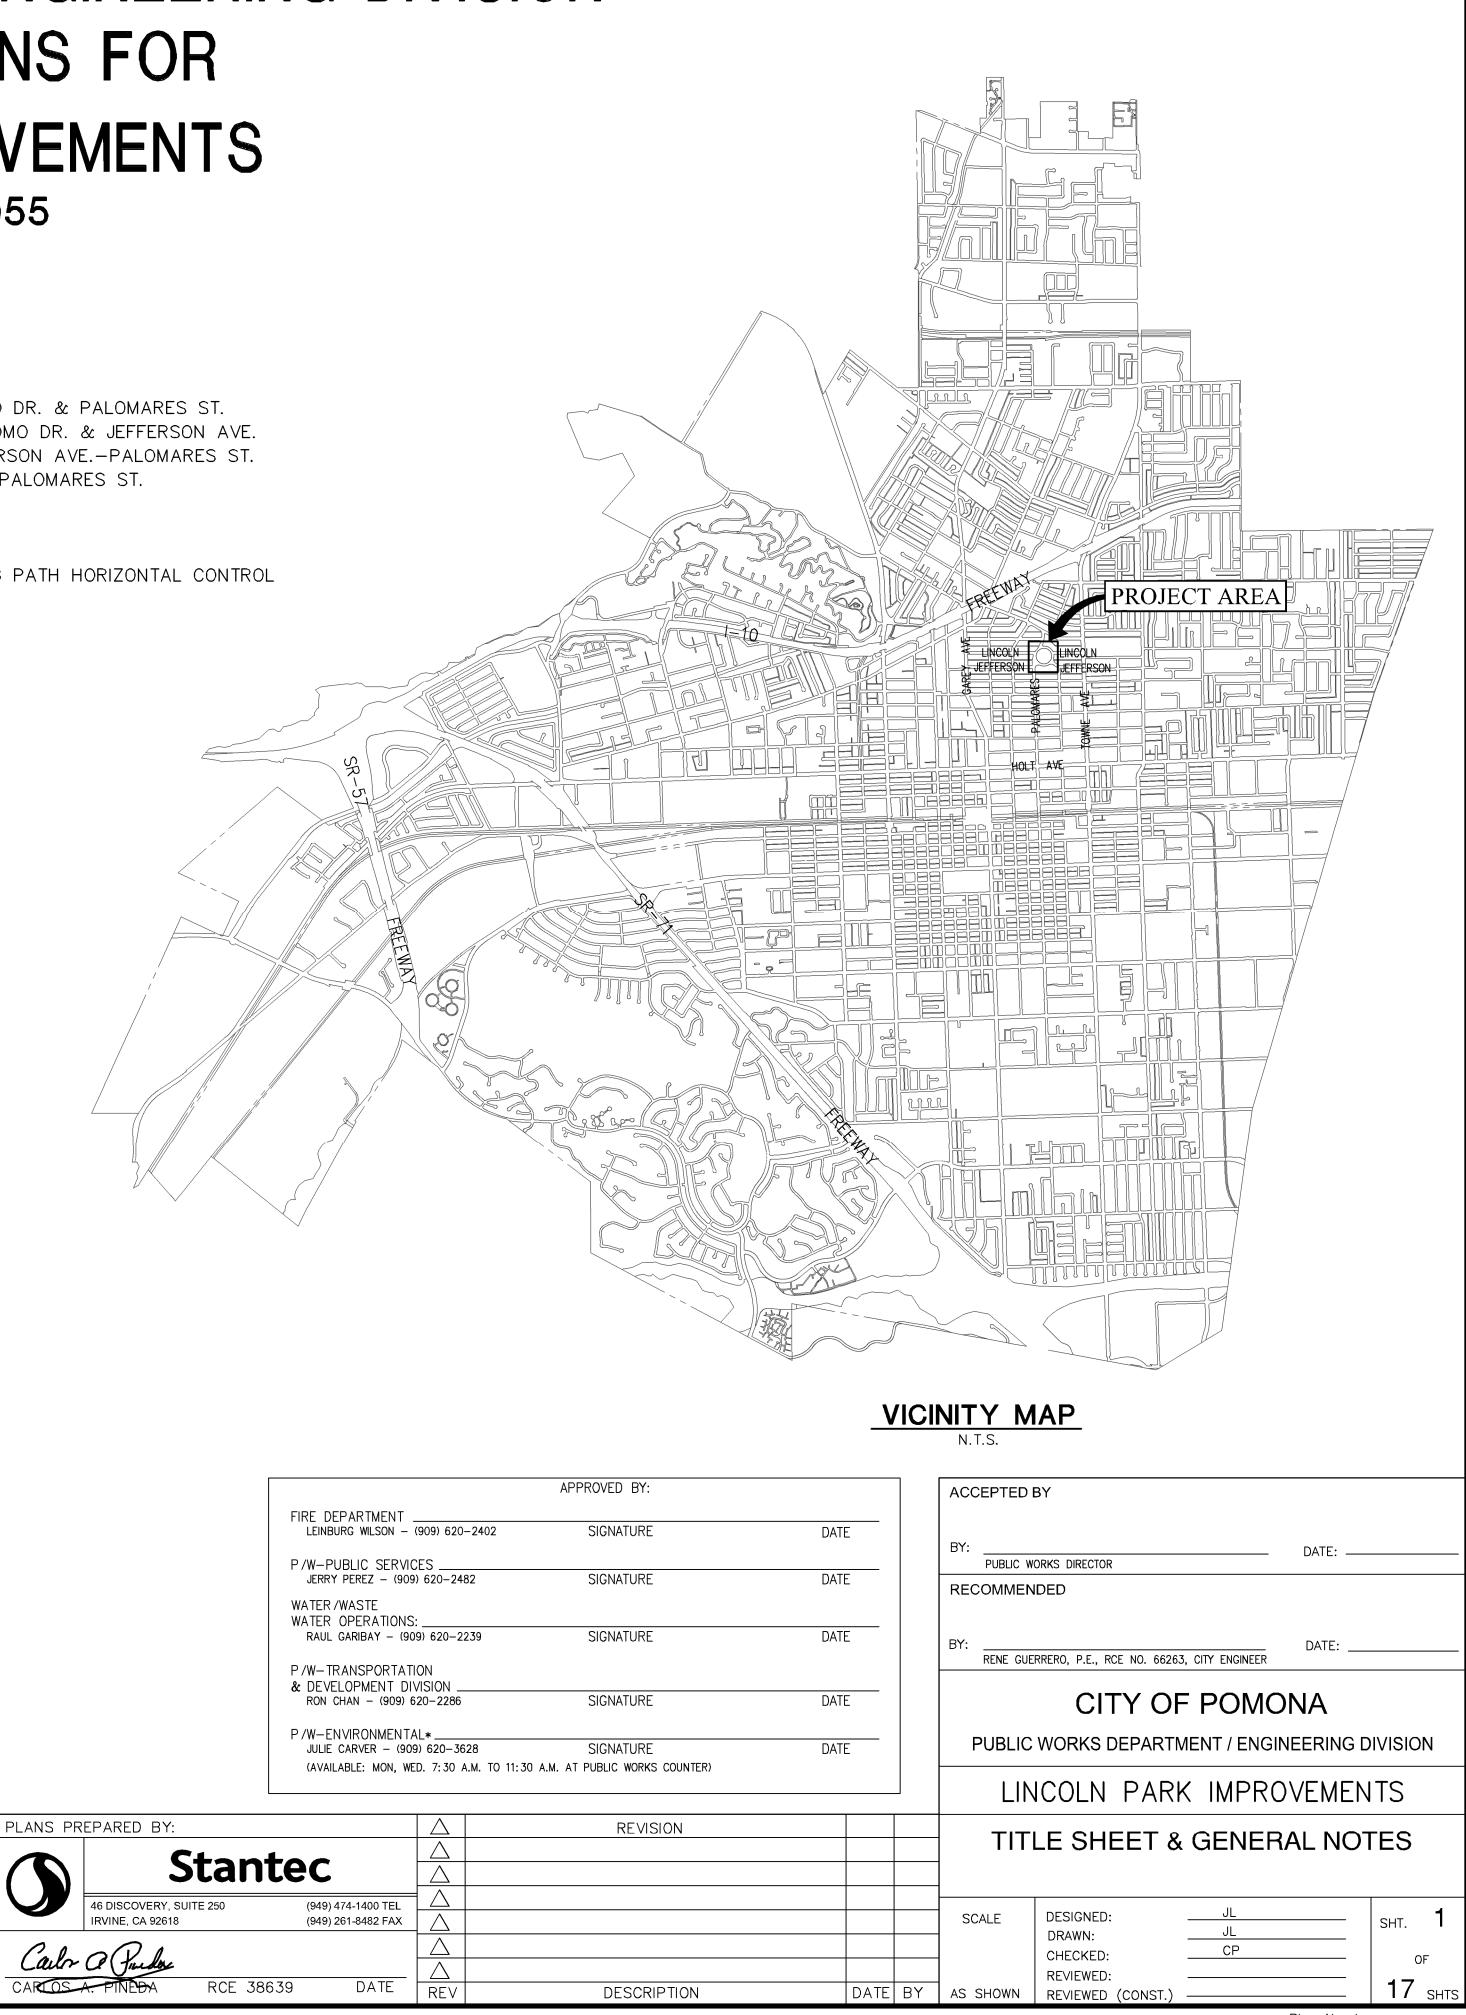

Plan Number _____

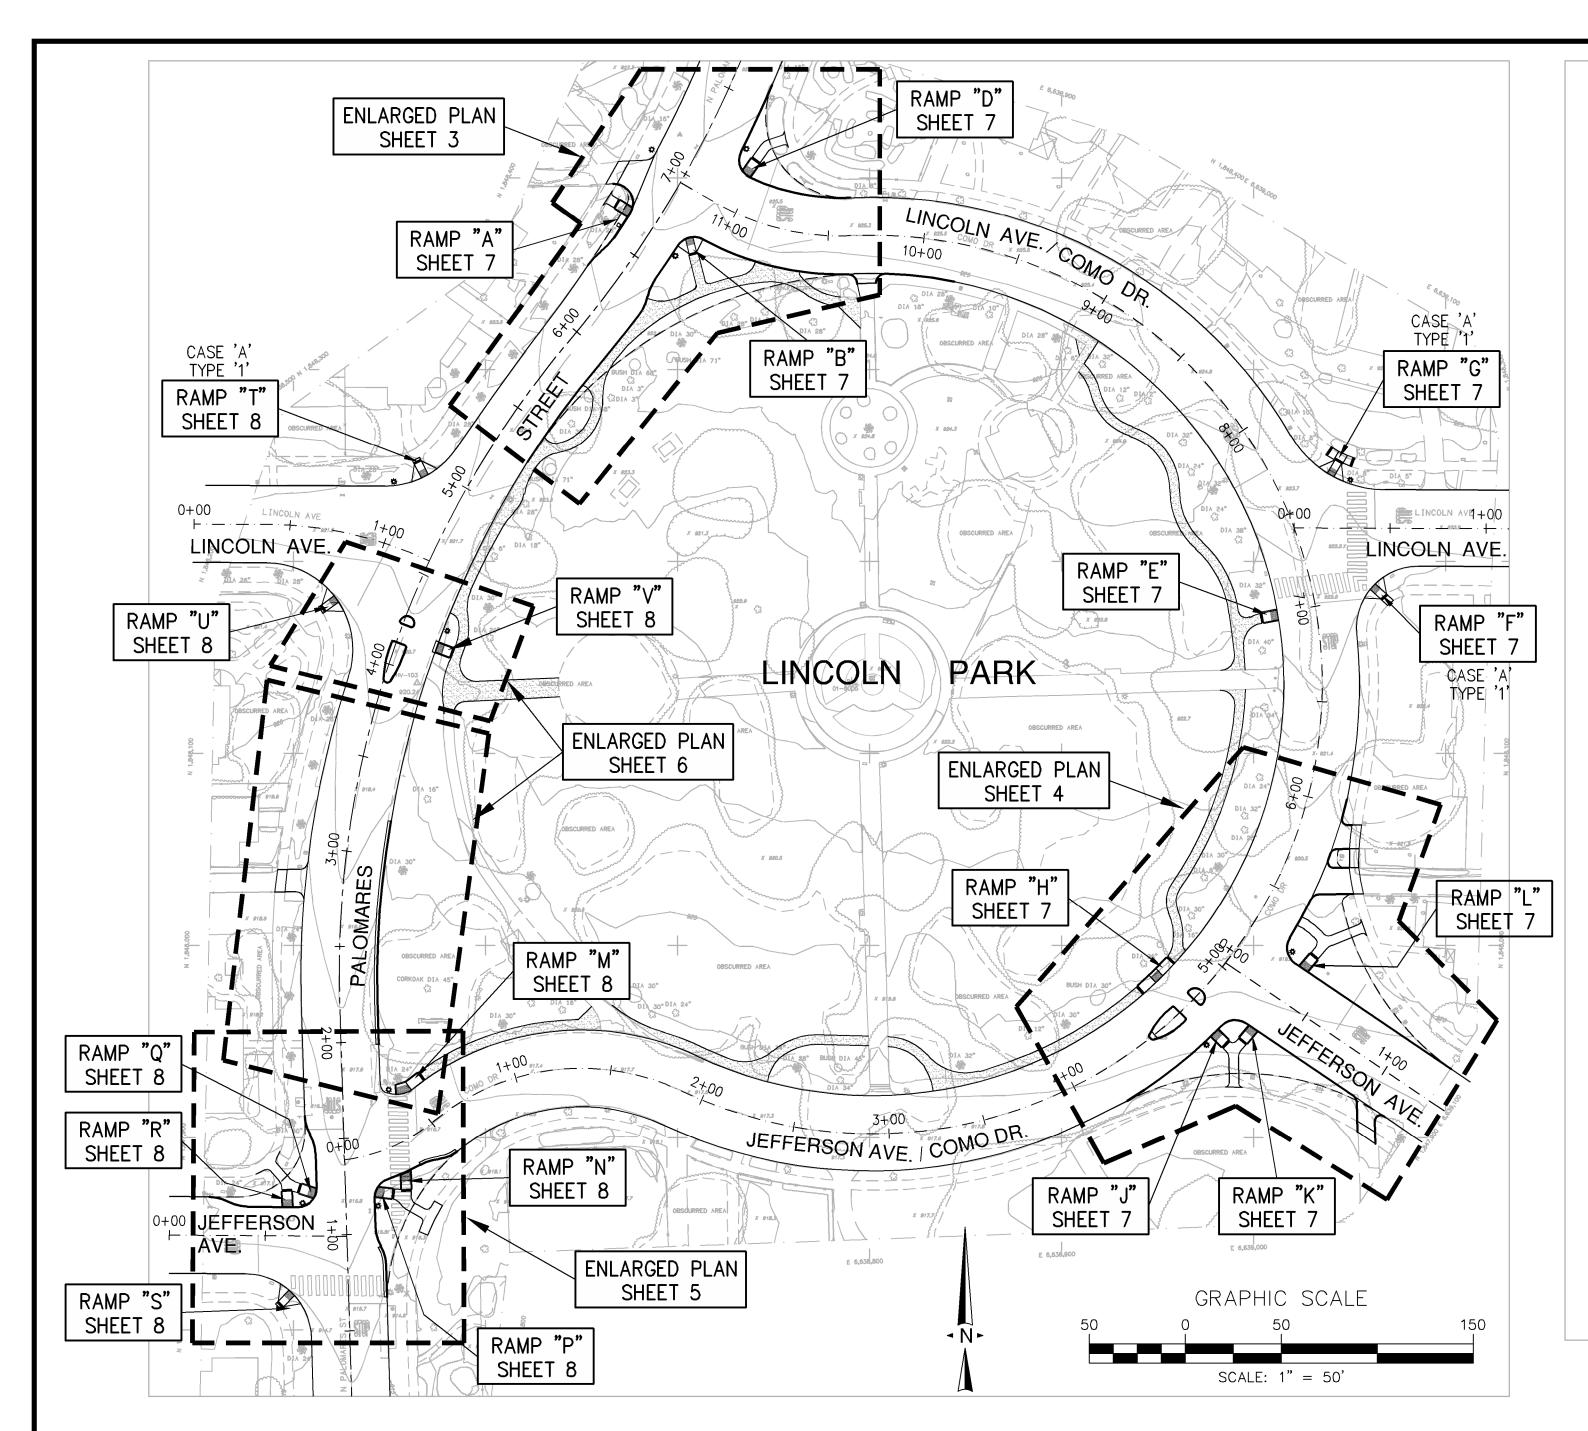

DESCRIPTION	STATION	LENGTH	DELTA OR BEARING	RADIUS	TANGENT
BEGIN ALIGNMENT	0+00.00				
BC	2+21.90	221.90	N 01°43'17" W		
PRC	5+94.05	372.15	41'48'34"	510.00	194.80
END ALIGNMENT	8+09.61	215.56	21'40'01"	570.00	109.08
COMO DR CONSTR	UCTION CE	ENTERLIN	IE		
DESCRIPTION	STATION	LENGTH	DELTA OR BEARING	RADIUS	TANGENT
PALOMARES ST. (1+38.92) INT.	0+00.00	50.92	32*25'05"	90.00	26.16
PRC	0+50.92	137.15	64 * 56'39"	121.00	77.00
PRC	1+88.07	849.46	207*59'39"	234.00	938.73
PRC	10+37.54	73.98	32*36'25"	130.00	38.02
EC PALOMARES ST. (6+94.94) INT.	11+11.52 11+32.83	21.31	N 60.03,08. W		
JEFFERSON AVE. (W)	- CONSTI		г		
DESCRIPTION	STATION	LENGTH	DELTA OR BEARING	RADIUS	TANGENT
BEGIN ALIGNMENT	0+00.00	92.47	S 89'35'10" E		
PALOMARES ST. (0+99.13) INT.	0+92.47				
LINCOLN AVE. (W) -	CONSTRU	ction ce	INTERLINE		1
DESCRIPTION	STATION	LENGTH	DELTA OR BEARING	RADIUS	TANGENT
BEGIN ALIGNMENT	0+00.00	37.89	S 89'48'20" E		
BC	0+37.89	87.38	25.02,01	200.00	44.40
PALOMARES ST. (4+57.53) INT.	1+25.27		20 02 01	200100	
JEFFERSON AVE. (E)	- CONSTR	RUCTION	CENTERLINE		
DESCRIPTION	STATION	LENGTH	DELTA OR BEARING	RADIUS	TANGENT

COMO DR. (5+02.69) INT.	0+00.00	137.30	S 55'57'18" E		
END ALIGNMENT	1+37.30	137.30	5 33 37 10 E		
LINCOLN AVE. (E) –	CONSTRUC	TION CE	NTERLINE		
DESCRIPTION	STATION	LENGTH	DELTA OR BEARING	RADIUS	TANGENT
COMO DR. (7+42.26) INT.	0+00.00				
	0.00.00	128.79	S 89'47'28" E		
END ALIGNMENT	1+28.79				


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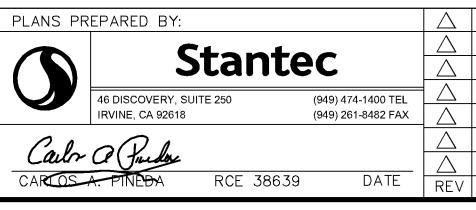
COMO DR. (5+02.69) INT.



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t's below. Call two working before you dig. Aderaround Service Alert



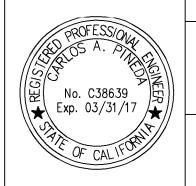

CONSTRUCTION NOTES & QUANTITIES


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NO.	ITEM	QUANTITY	UNIT
(11)	CONSTRUCT 8" AC PAVEMENT.	5,555	SF
(12)	CONSTRUCT TYPE "A-2" CURB ONLY PER CITY OF POMONA STD. PLAN NO. A-3-64.	1,163	LF
(13)	CONSTRUCT CURB RAMP PER CITY OF POMONA AND MODIFIED APWA STD. PLAN NO. 111–5. (CASE 'D', TYPE '1' UNLESS NOTED OTHERWISE).	19	EA
(14)	CONSTRUCT 4" PCC SIDEWALK PER CITY OF POMONA STD. PLAN NO. A-7-02.	820	SF
(15)	CONSTRUCT ALLEY INTERSECTION PER CITY OF POMONA STD. PLAN NO. A-5-06 AND DETAIL HEREON.	2	SF
(16)	CONSTRUCT DRIVEWAY APPROACH PER CITY OF POMONA AND MODIFIED APWA STD. PLAN NO. 110–2 AND DETAIL HEREON.	3	EA
17	CONSTRUCT 8" CF, 18" GUTTER TYPE "B" INTEGRAL CURB AND GUTTER PER CITY OF POMONA STD. PLAN NO. A-3-64.	166	LF
18	SEE LANDSCAPING PLAN.		LS
(19)	CONSTRUCT ALLEY INTERSECTION WITH ASPHALT CONCRETE PER CITY OF POMONA STD. PLAN NO. A-5-06 AND DETAIL HEREON.	1	EA
20	CONSTRUCT PARKWAY DRAIN PER CITY OF POMONA AND MODIFIED APWA STD. PLAN NO. 151–2.	60	LF
(21)	CONSTRUCT (3) 3" PVC PIPE CULVERT PER ELEVATIONS SHOWN ON THE PLAN.	1	EA
22	CONSTRUCT 12"x12" BROOKS GRATE INLET CATCH BASIN (MODEL 1212CB) AND 4" PVC PIPE PER PLAN.	1	EA
23	ADJUST EXISTING WATER VALVE TO GRADE	3	EA
24	FURNISH AND INSTALL 150W HPS LAMP WITH PHOTOELECTRIC CONTROLS ON 10' TAPERED CONCRETE POLE (TYPE 782–10) AND 8" GLOBE. SEE ELECTRICAL PLANS.	4	EA
25	RELOCATE STREET LIGHT POLE AND REPLACE WITH 150W HPS LAMP. SEE ELECTRICAL PLANS.	7	EA
26	RELOCATE EX. WATER METER.	1	EA
27	CONSTRUCT 4" PVC CURB DRAIN.	1	EA
28	SAWCUT, REMOVE DAMAGED SIDEWALK AND RECONST. 4" PCC SIDEWALK PER CITY OF POMONA STD. PLAN NO. A-7-02.	130	SF
29	SAWCUT, REMOVE DAMAGED CURB AND RECONST TYPE 'A-2' CURB PER CITY OF POMONA STD. PLAN NO. A-3-64.	50	LF

<u>DEMOLITION NOTES & QUANTITIES</u>

NO.	ITEM	QUANTITY	UNIT
Р	PROTECT IN PLACE, ITEM PER PLAN		
1	SAWCUT AND REMOVE EXISTING CURB	920	LF
2	SAWCUT AND REMOVE EXISTING AC PAVEMENT	14,580	SF
3	SAWCUT AND REMOVE EXISTING CONCRETE WALKWAY	450	SF
4	REMOVE EXISTING DG PATH	90	SF

			ACCEPTED	ВҮ		
			BY: PUBLIC W	ORKS DIRECTOR	DATE:	
			RECOMMEN	IDED		
			BY: RENE GUE	RRERO, P.E., RCE NO. 6626.	DATE:	
				CITY OF	= POMONA	
			PUBLIC	WORKS DEPART	MENT / ENGINEERING	DIVISION
			LIN	ICOLN PARI	K IMPROVEMEN	NTS
REVISION			INE		YPICAL SECTIO ANTITIES	ONS
			SCALE	DESIGNED: DRAWN:	JL	sht. 2
DESCRIPTION	DATE	BY	AS SHOWN	CHECKED: REVIEWED: REVIEWED (CONST.)	CP	оғ 17 shī

Plan Number _____

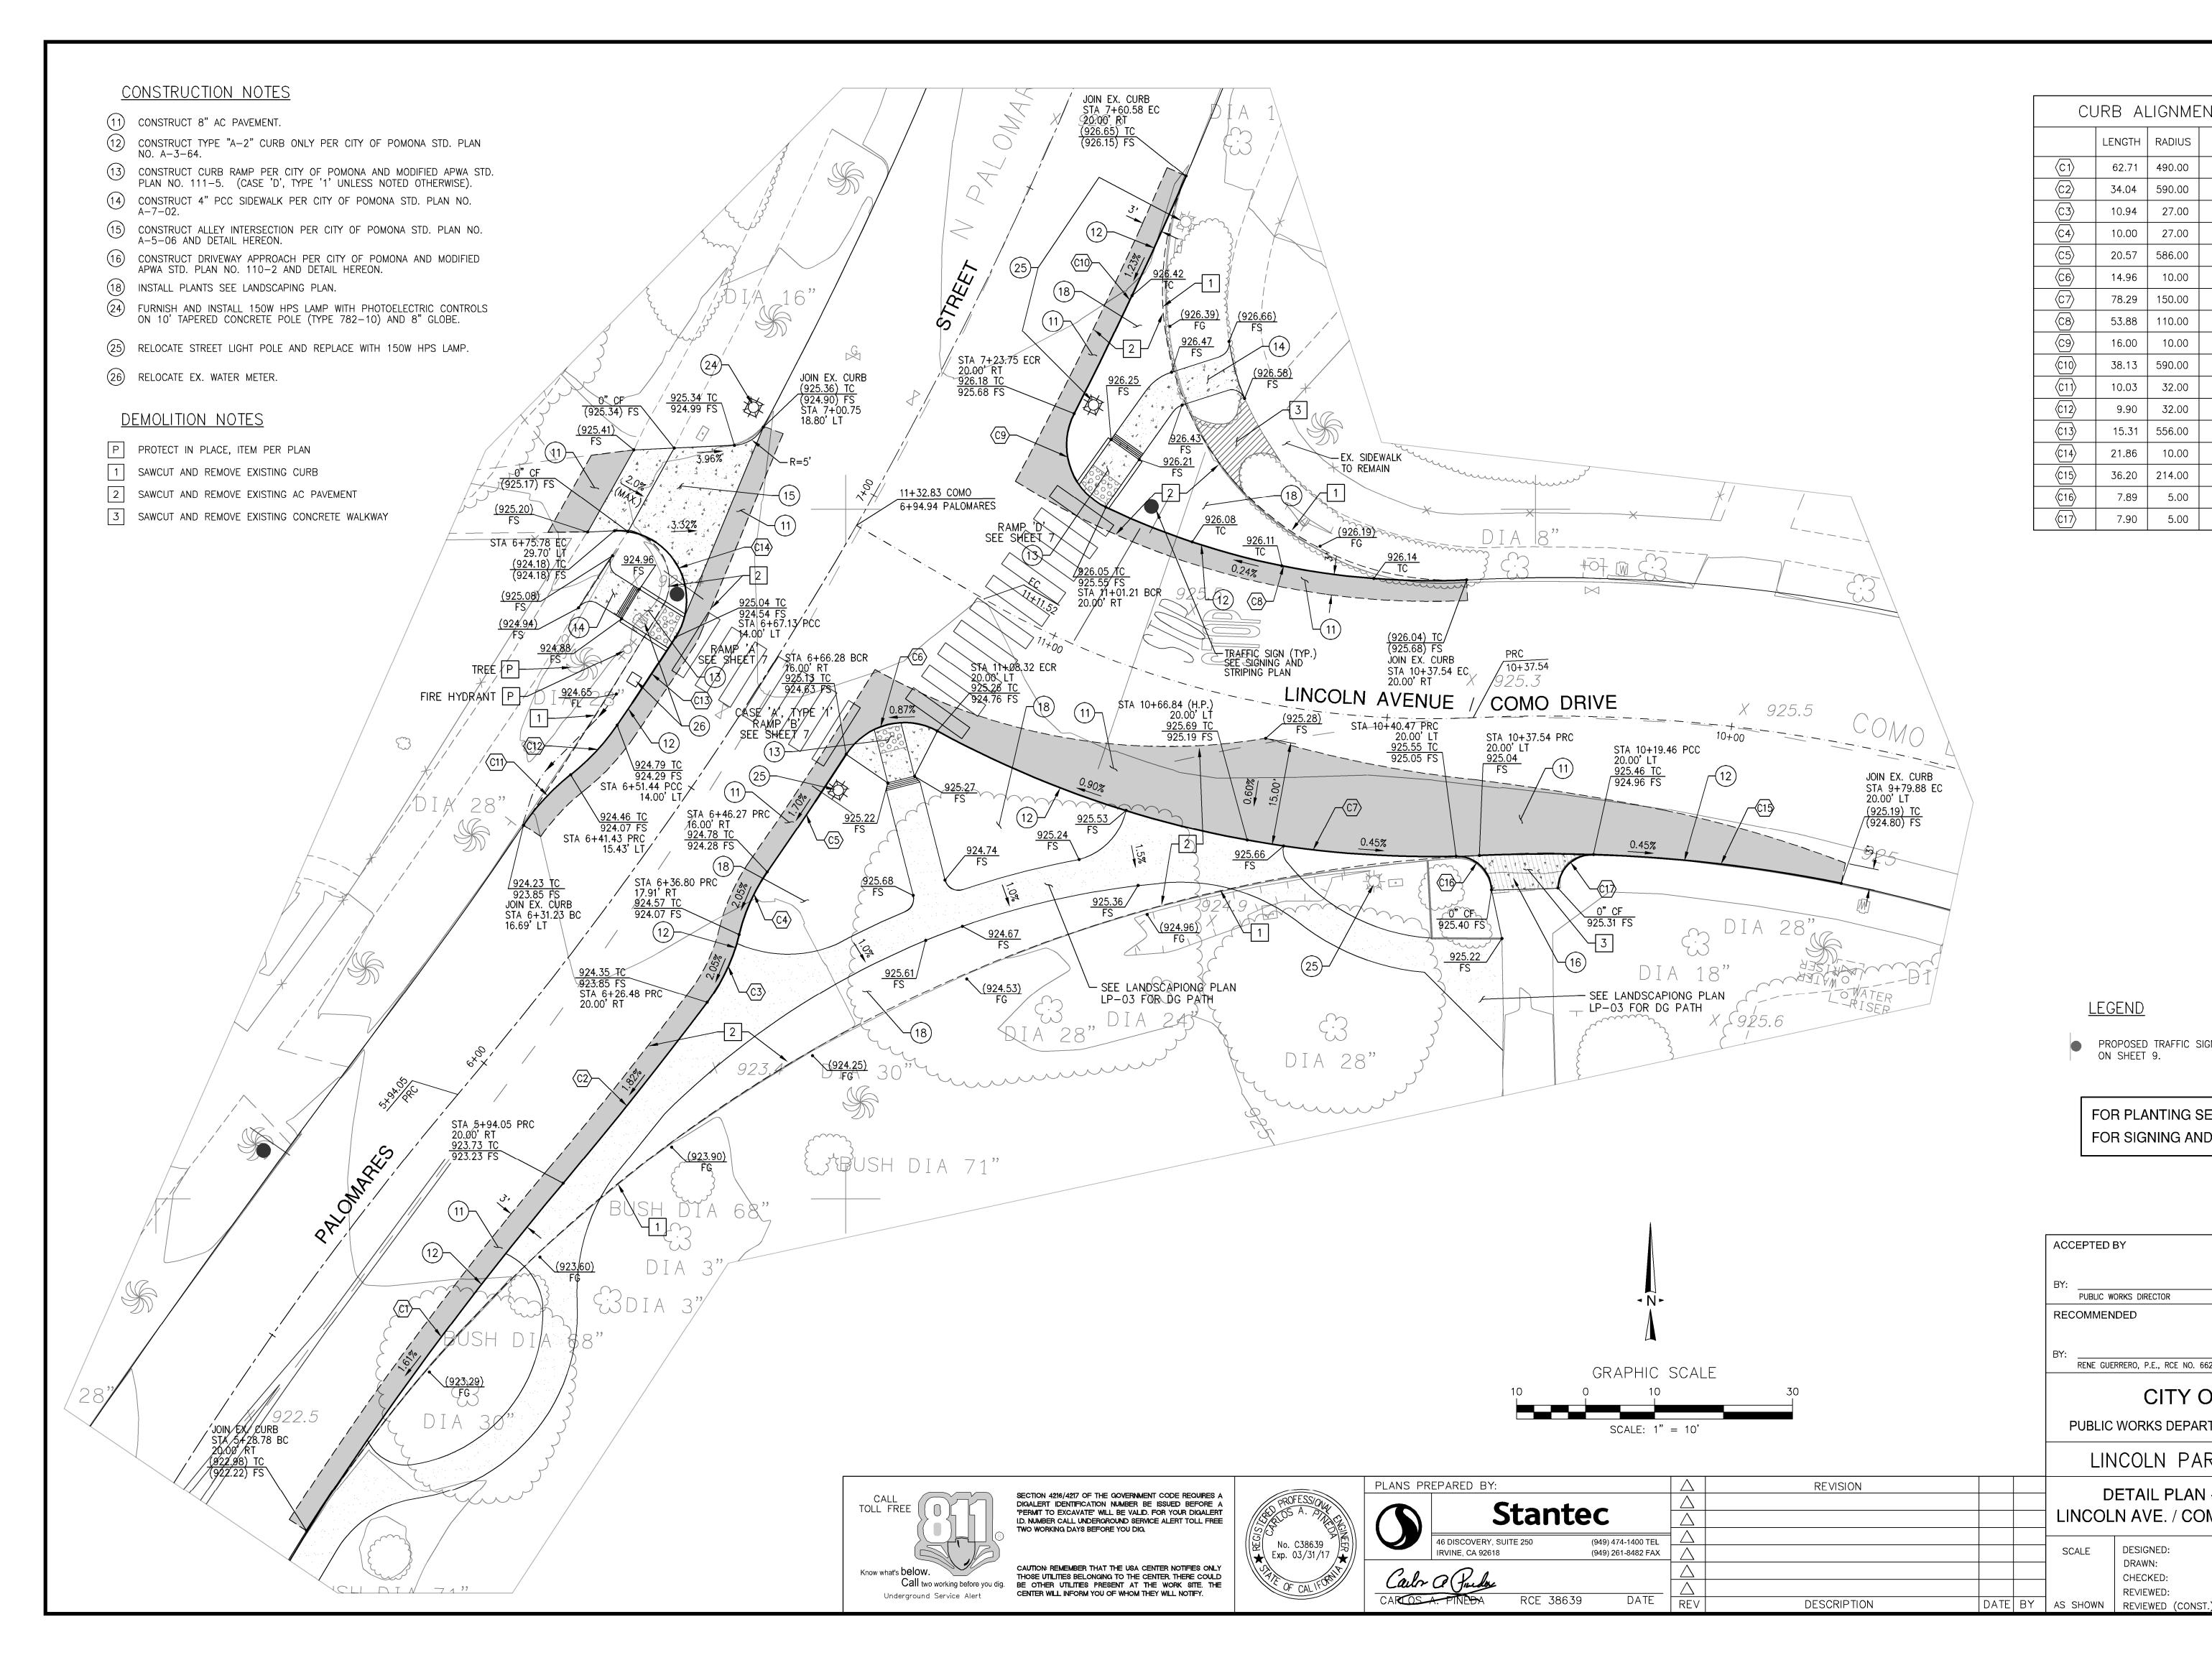

CURB ALIGNMENT TABLE							
	LENGTH	RADIUS	DELTA OR BEARING	TANGENT			
(C1)	62.71	490.00	7°20'00"	31.40			
(C2)	34.04	590.00	3•18'22"	17.03			
(C3)	10.94	27.00	23°12'27"	5.54			
(C4)	10.00	27.00	21°13'05"	5.06			
(C5)	20.57	586.00	2.00,41"	10.29			
<u>(C6)</u>	14.96	10.00	85°42'35"	9.28			
(C7)	78.29	150.00	29`54`18"	40.06			
<u>(C8)</u>	53.88	110.00	28.03,46"	27.49			
(C9)	16.00	10.00	91°38'54"	10.29			
(C10)	38.13	590.00	3°42'10"	19.07			
(C11)	10.03	32.00	17 ` 57'57"	5.06			
(C12)	9.90	32.00	17 ` 43'03"	4.99			
(C13)	15.31	556.00	1`34'38"	7.65			
(C14)	21.86	10.00	125.13'51"	19.30			
(C15)	36.20	214.00	9°41'32 "	18.14			
(C16)	7.89	5.00	90°26'55"	5.04			
(C17)	7.90	5.00	90°29'36"	5.04			

<u>LEGEND</u>

ACCEPTED BY

RECOMMENDED

SCALE

PUBLIC WORKS DIRECTOR

RENE GUERRERO, P.E., RCE NO. 66263, CITY ENGINEER

DESIGNED:

DRAWN:

CHECKED:

REVIEWED:

FOR PLANTING SEE SHEET LP-02 FOR SIGNING AND STRIPING SEE SHEET 9

CITY OF POMONA

PUBLIC WORKS DEPARTMENT / ENGINEERING DIVISION

LINCOLN PARK IMPROVEMENTS

DETAIL PLAN - INTERSECTION OF

LINCOLN AVE. / COMO DR. & PALOMARES ST.

ON SHEET 9.

PROPOSED TRAFFIC SIGN. SEE SIGNING AND STRIPING PLAN

DATE: _____

DATE:

Plan Number _____


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OF

SHT





- A-7-02.

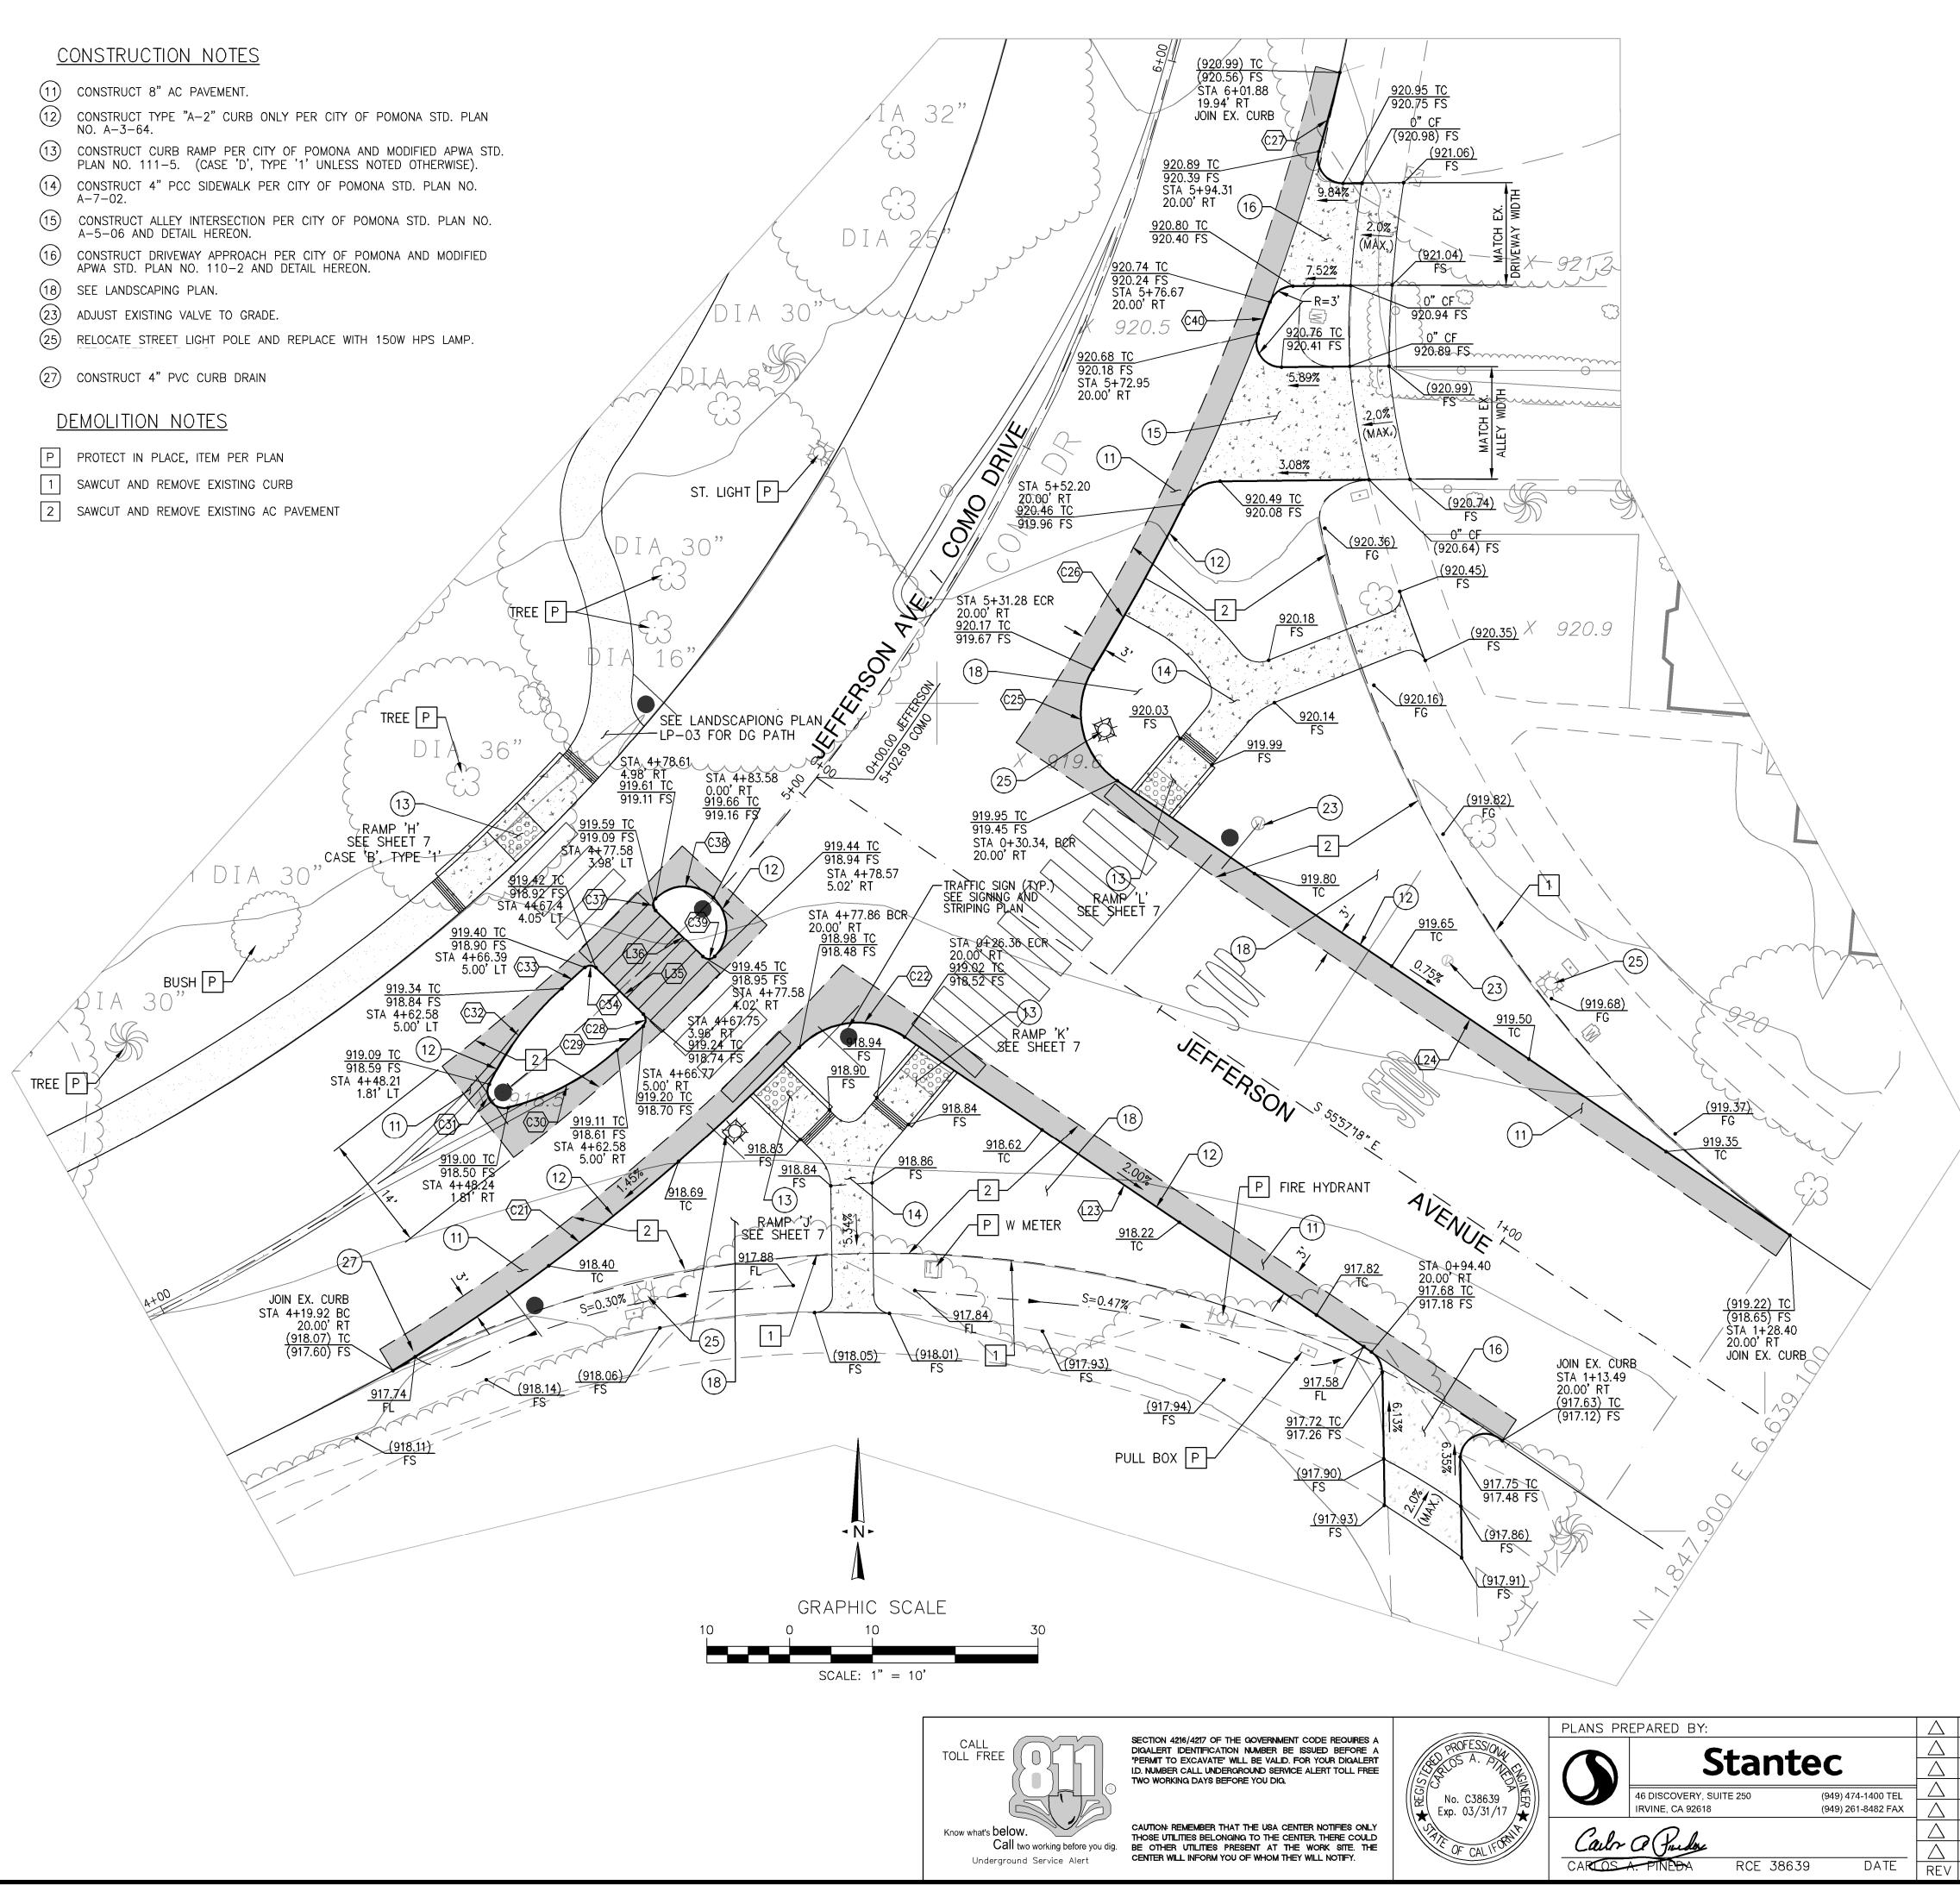

			PRC	END DPOSED TRAFFIC SIGN. SHEET 9.	SEE SIGNING A	and striping	G PLAN
			FOF	R PLANTING SEE			9
			ACCEPTED	ВҮ			
			BY:	ORKS DIRECTOR		DATE:	
			BY: RENE GUE	RRERO, P.E., RCE NO. 66263	, CITY ENGINEER	DATE:	
			PUBLIC	CITY OF WORKS DEPARTM			VISION
			LIN	ICOLN PARK	(IMPRO)	VEMEN	TS
REVISION				ETAIL PLAN - SON AVE./COM			
			SCALE	DESIGNED: DRAWN: CHECKED:	JL JL CP		SHT. 4
DESCRIPTION	DATE	ΒY	AS SHOWN	REVIEWED: REVIEWED (CONST.)			17 SHT
					F	^o lan Number	

CURB ALIGNMENT TABLE								
	LENGTH	RADIUS	DELTA OR BEARING	TANGENT				
(C21)	62.89	254.00	14•11'13"	31.40				
(C22)	13.90	10.00	79'39'56"	8.34				
(L23)	68.04		S 55°57'18" E					
<u>(L24</u>)	98.06		N 55°57'18" W					
(C25)	15.23	10.00	87 15 21"	9.53				
(C26)	22.72	254.00	5°07'28"	11.37				
(C27)	9.91	254.00	2.14'09"	4.96				
(C28)	1.62	1.00	92'38'57"	1.05				
<u>(C29</u>)	4.28	239.00	1.01,33"	2.14				
(C30)	15.04	30.56	28'12'16"	7.68				
(C31)	4.53	2.00	129`54`35"	4.28				
(C32)	14.59	38.21	21.53'09"	7.39				
(C33)	3.73	229.00	0.56'01"	1.87				
(C34)	1.52	1.00	87 15 31"	0.95				
(L35)	8.01		S 45°33'11" E					
(L36)	8.00		N 45°33'11" W					
(C37)	1.57	1.00	90°07'13"	1.00				
(C38)	15.69	5.00	179°45'34"	INF.				
(C39)	1.57	1.00	90°07'13"	1.00				
(C40)	4.04	254.00	0*54'40"	2.02				

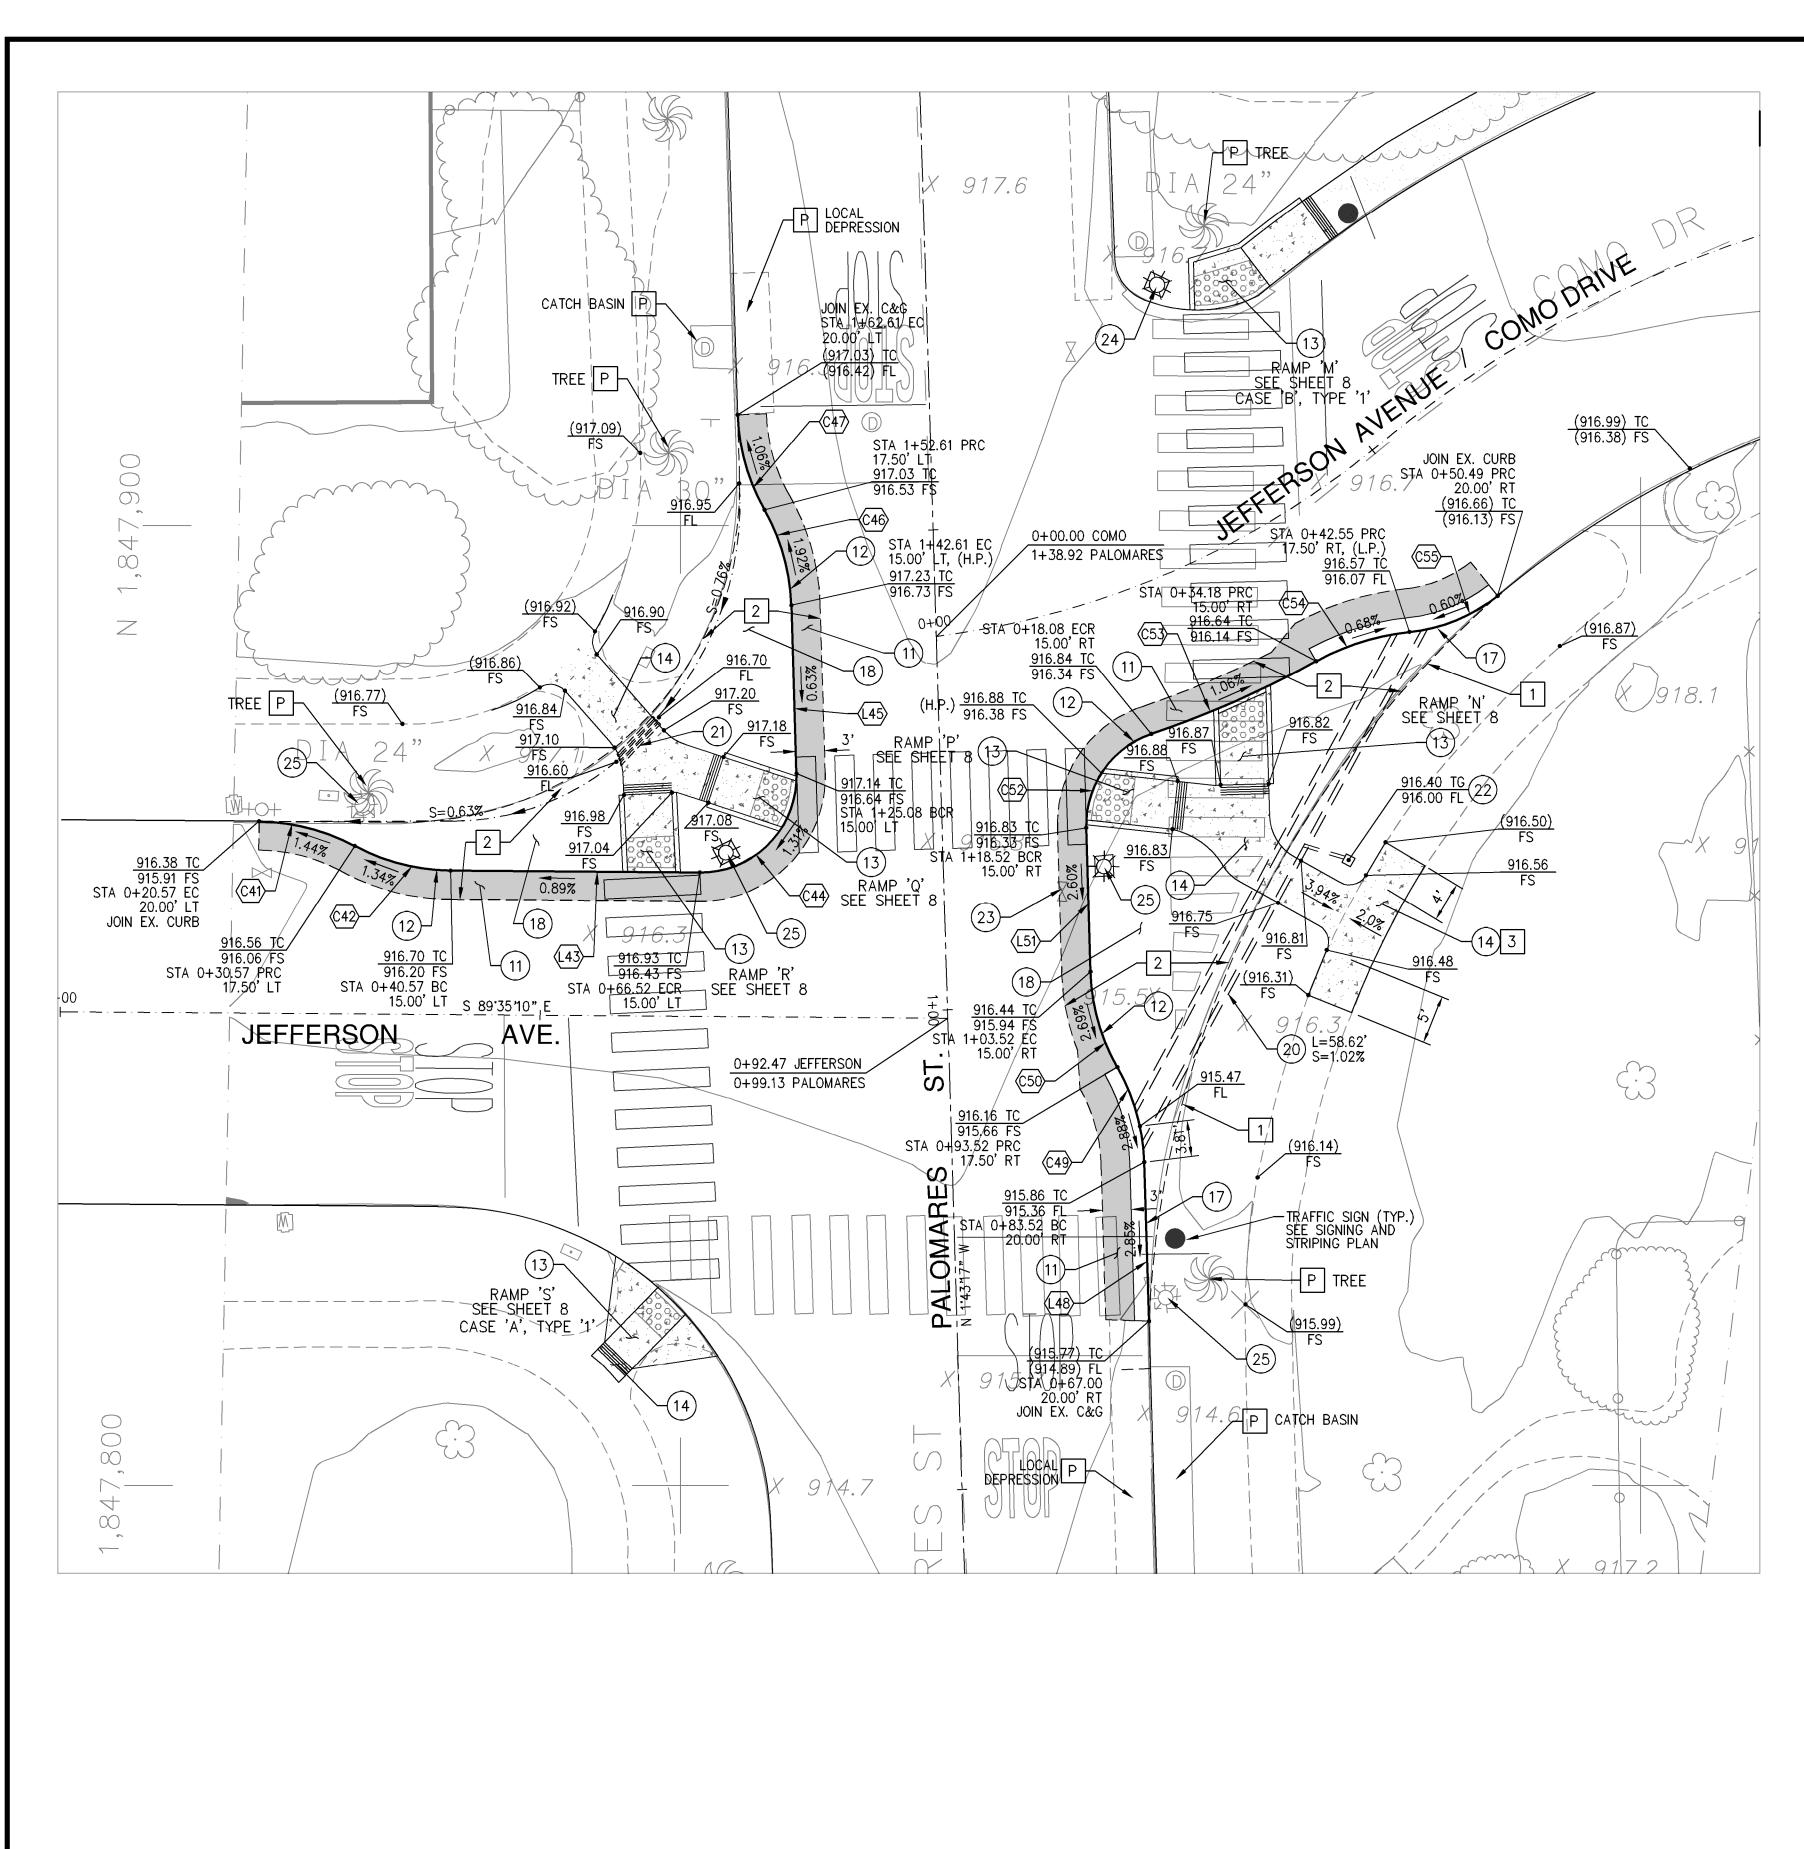

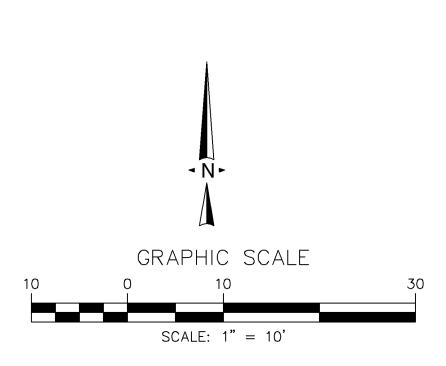

CONSTRUCTION NOTES

- (11) CONSTRUCT 8" AC PAVEMENT.
- (12) CONSTRUCT TYPE "A-2" CURB ONLY PER CITY OF POMONA STD. PLAN NO. A-3-64.
- (13) CONSTRUCT CURB RAMP PER CITY OF POMONA AND MODIFIED APWA STD. PLAN NO. 111-5. (CASE 'D', TYPE '1' UNLESS NOTED OTHERWISE).
- (14) CONSTRUCT 4" PCC SIDEWALK PER CITY OF POMONA STD. PLAN NO. A-7-02.
- (17) CONSTRUCT 8" CF, 18" GUTTER TYPE "B" INTEGRAL CURB AND GUTTER PER CITY OF POMONA STD. PLAN NO. A-3-64.
- (18) INSTALL PLANTS SEE LANDSCAPING PLAN.
- 20 CONSTRUCT PARKWAY DRAIN PER CITY OF POMONA AND MODIFIED APWA STD. PLAN NO. 151-2.
- (21) CONSTRUCT (3) 3" PVC PIPE CULVERT PER ELEVATIONS SHOWN ON THE PLAN.
- (2) CONSTRUCT 12"x12" BROOKS GRATE INLET CATCH BASIN (MODEL 1212CB) AND 4" PVC PIPE PER PLAN.
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- 4 FURNISH AND INSTALL 150W HPS LAMP WITH PHOTOELECTRIC CONTROLS ON 10' TAPERED CONCRETE POLE (TYPE 782-10) A
- (25) RELOCATE STREET LIGHT POLE AND REPLACE WITH 150W HPS LAMP.


DEMOLITION NOTES


- P PROTECT IN PLACE, ITEM PER PLAN
- 1 SAWCUT AND REMOVE EXISTING CURB
- 2 SAWCUT AND REMOVE EXISTING AC PAVEMENT



SECTION 4216/4217 OF THE GOVERNMENT CODE REQUIRES A DIGALERT IDENTIFICATION NUMBER BE ISSUED BEFORE A PERMIT TO EXCAVATE' WILL BE VALID. FOR YOUR DIGALERT I.D. NUMBER CALL UNDERGROUND SERVICE ALERT TOLL FREE TWO WORKING DAYS BEFORE YOU DIG.

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BY: DATE: _____ PUBLIC WORKS DIRECTOR RECOMMENDED DATE: RENE GUERRERO, P.E., RCE NO. 66263, CITY ENGINEER CITY OF POMONA PUBLIC WORKS DEPARTMENT / ENGINEERING DIVISION LINCOLN PARK IMPROVEMENTS REVISION DETAIL PLANS - INTERSECTIONS OF JEFFERSON AVE-COMO DR/-PALOMARES AVE SHT. **5** DESIGNED: SCALE DRAWN: CHECKED: OF REVIEWED: DATE BY AS SHOWN REVIEWED (CONST.) DESCRIPTION SH Plan Number _____
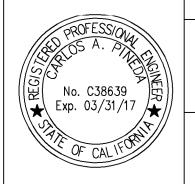
<u>LEGEND</u> PROPOSED TRAFFIC SIGN. SEE SIGNING AND STRIPING PLAN ON SHEET 9. FOR PLANTING SEE SHEET LP-02 FOR SIGNING AND STRIPING SEE SHEET 9 ACCEPTED BY

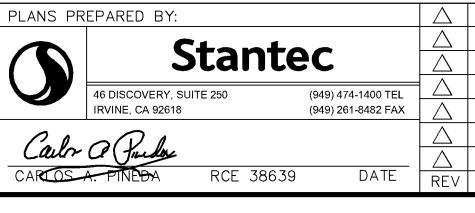
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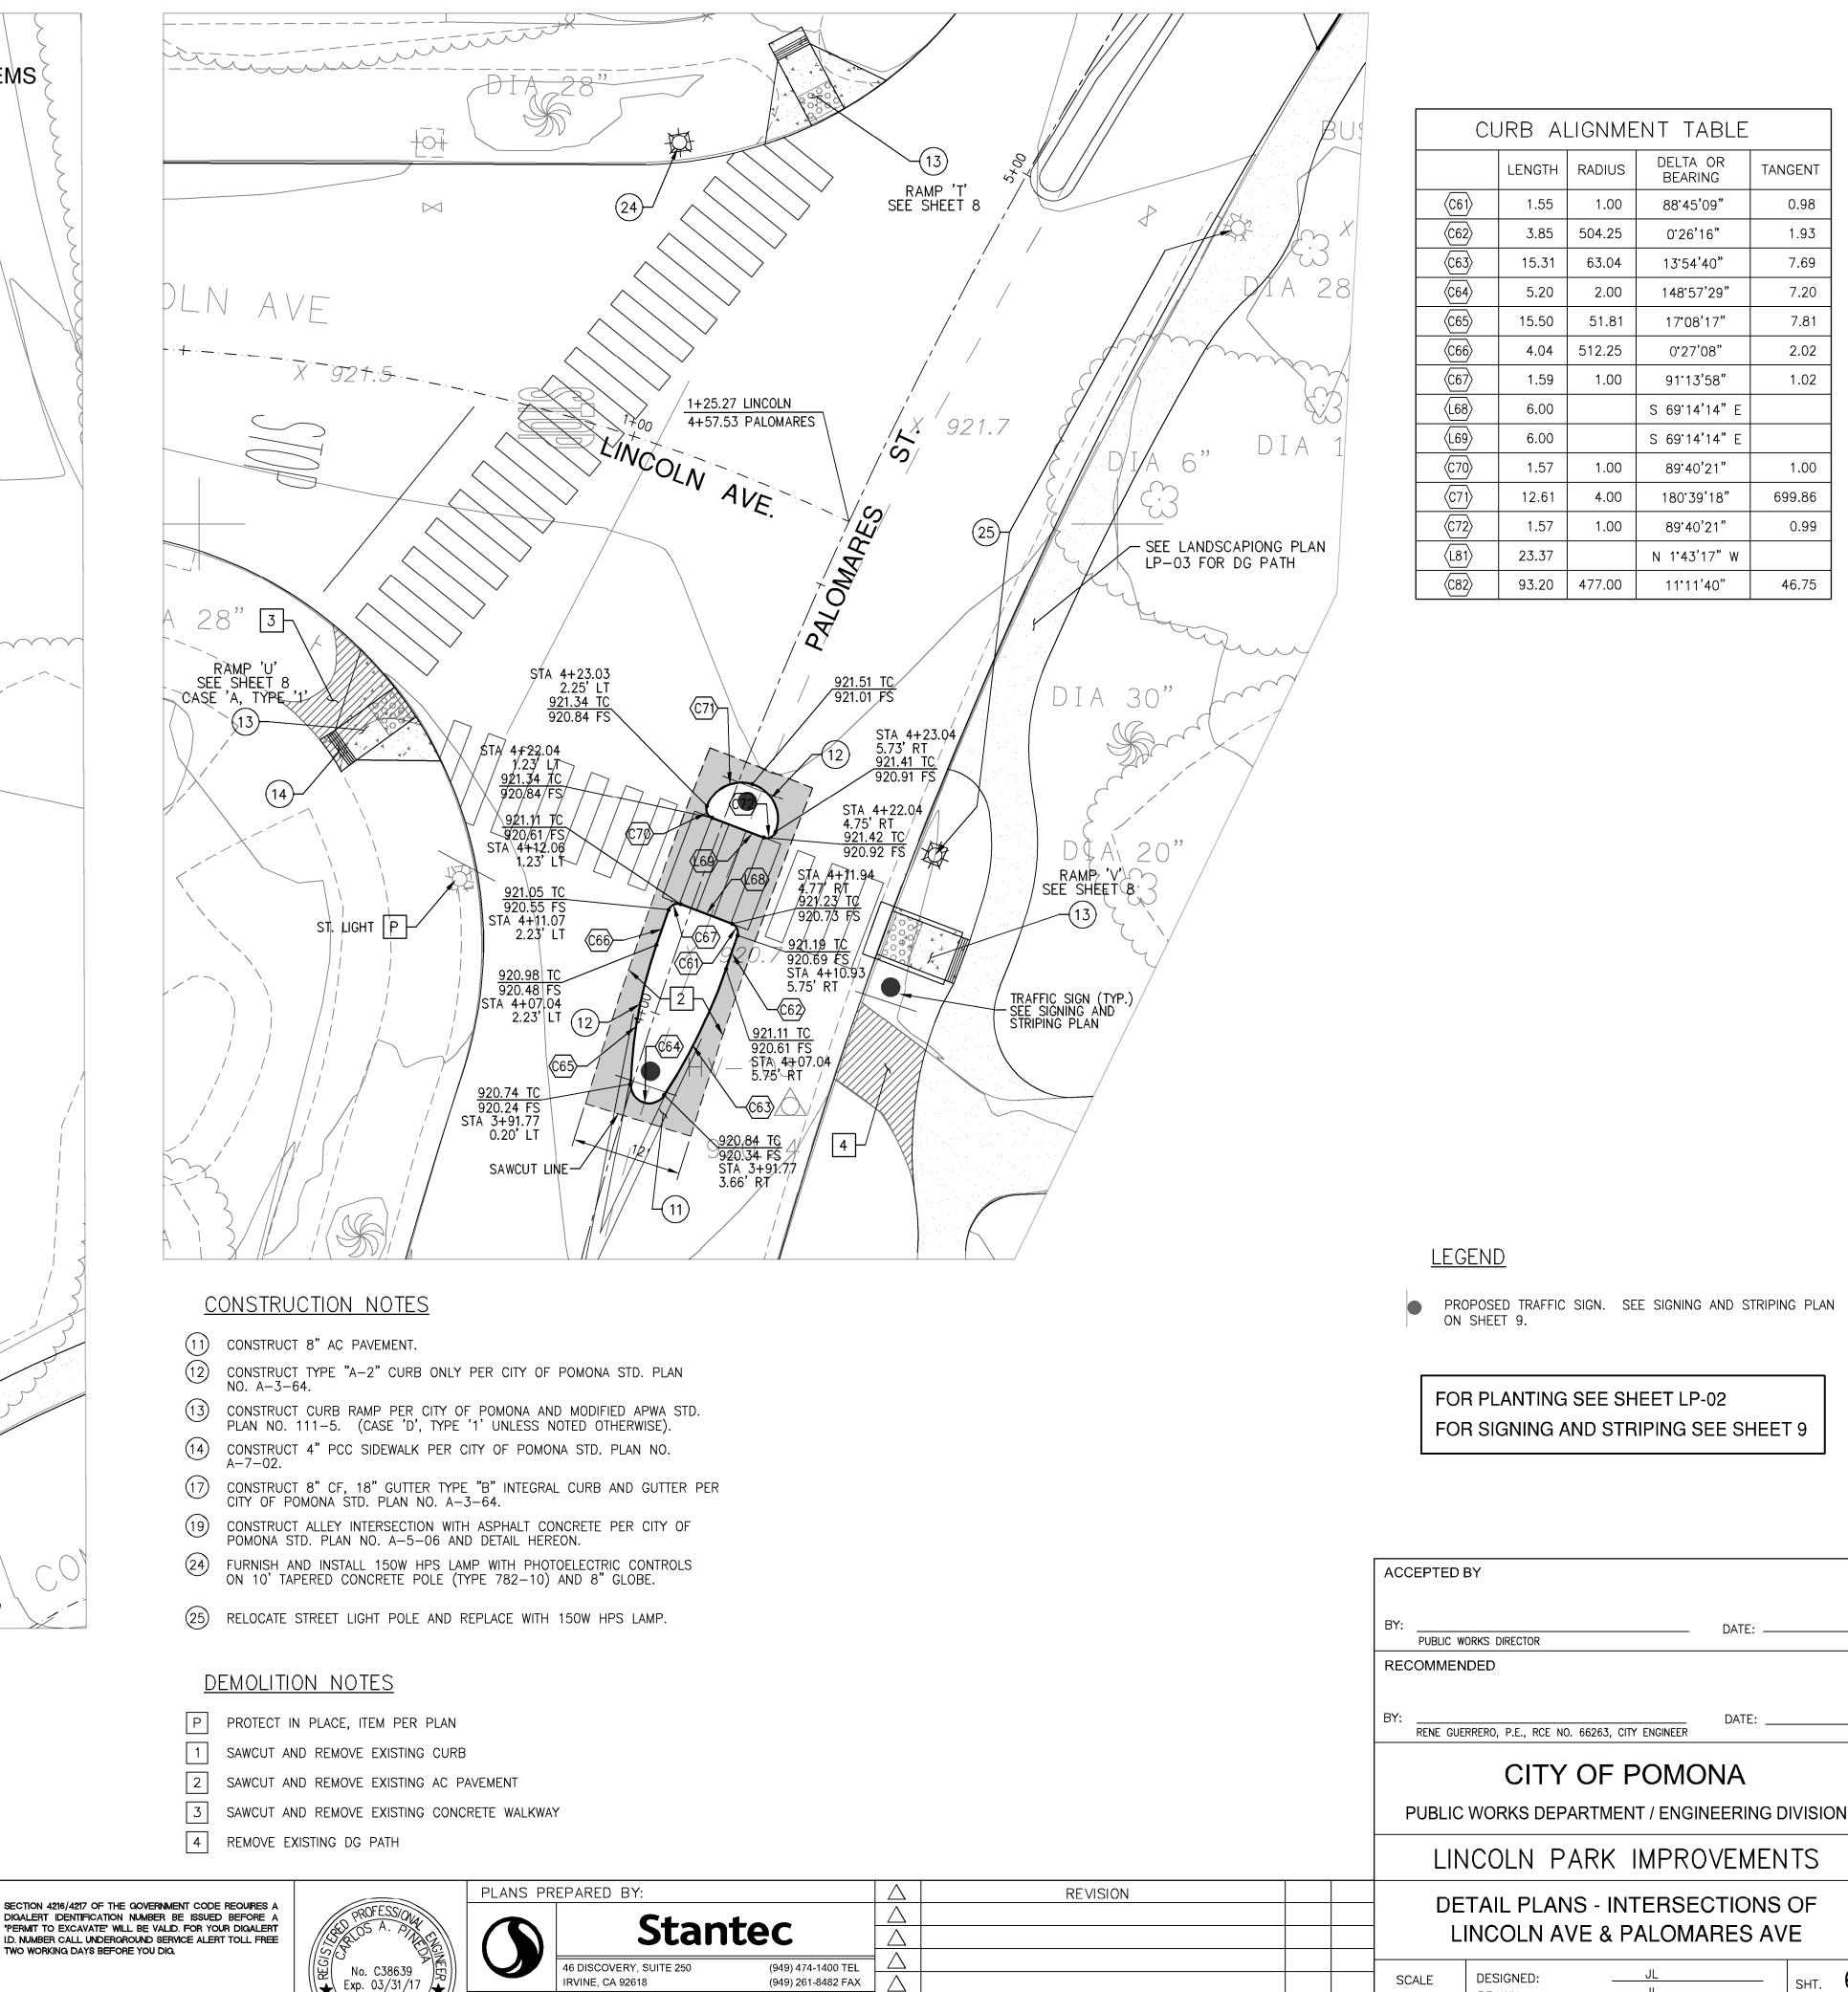
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AND	8"	GLOBE.
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٩ND	8"	GL	OBE.	

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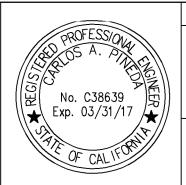
CURB ALIGNMENT TABLE							
	LENGTH	RADIUS	DELTA OR BEARING	TANGENT			
(C41)	10.41	21.25	28'04'21"	5.31			
(C42)	10.41	21.25	28'04'21"	5.31			
(L43)	25.95		S 89'35'10" E				
(C44)	16.08	10.00	92.08,07"	10.38			
(L45)	17.53		N 1°43'17" W				
(C46)	10.41	21.25	28'04'21"	5.31			
(C47)	10.41	21.25	28'04'21"	5.31			
<u>(L48</u>)	16.52		N 1°43'17" W				
(C49)	10.41	21.25	28'04'21"	5.31			
(C50)	10.41	21.25	28'04'21"	5.31			
(L51)	15.00		N 1°43'17" W				
<u>(C52</u>)	12.74	10.00	73'01'22"	7.40			
(C53)	18.79	105.00	10°15'04"	9.42			
(C54)	10.26	25.51	23'02'24"	5.20			
(C55)	10.05	17.67	32°35'15"	5.17			






PERMIT TO EXCAVATE' WILL BE VALID. FOR YOUR DIGALERT I.D. NUMBER CALL UNDERGROUND SERVICE ALERT TOLL FREE TWO WORKING DAYS BEFORE YOU DIG.

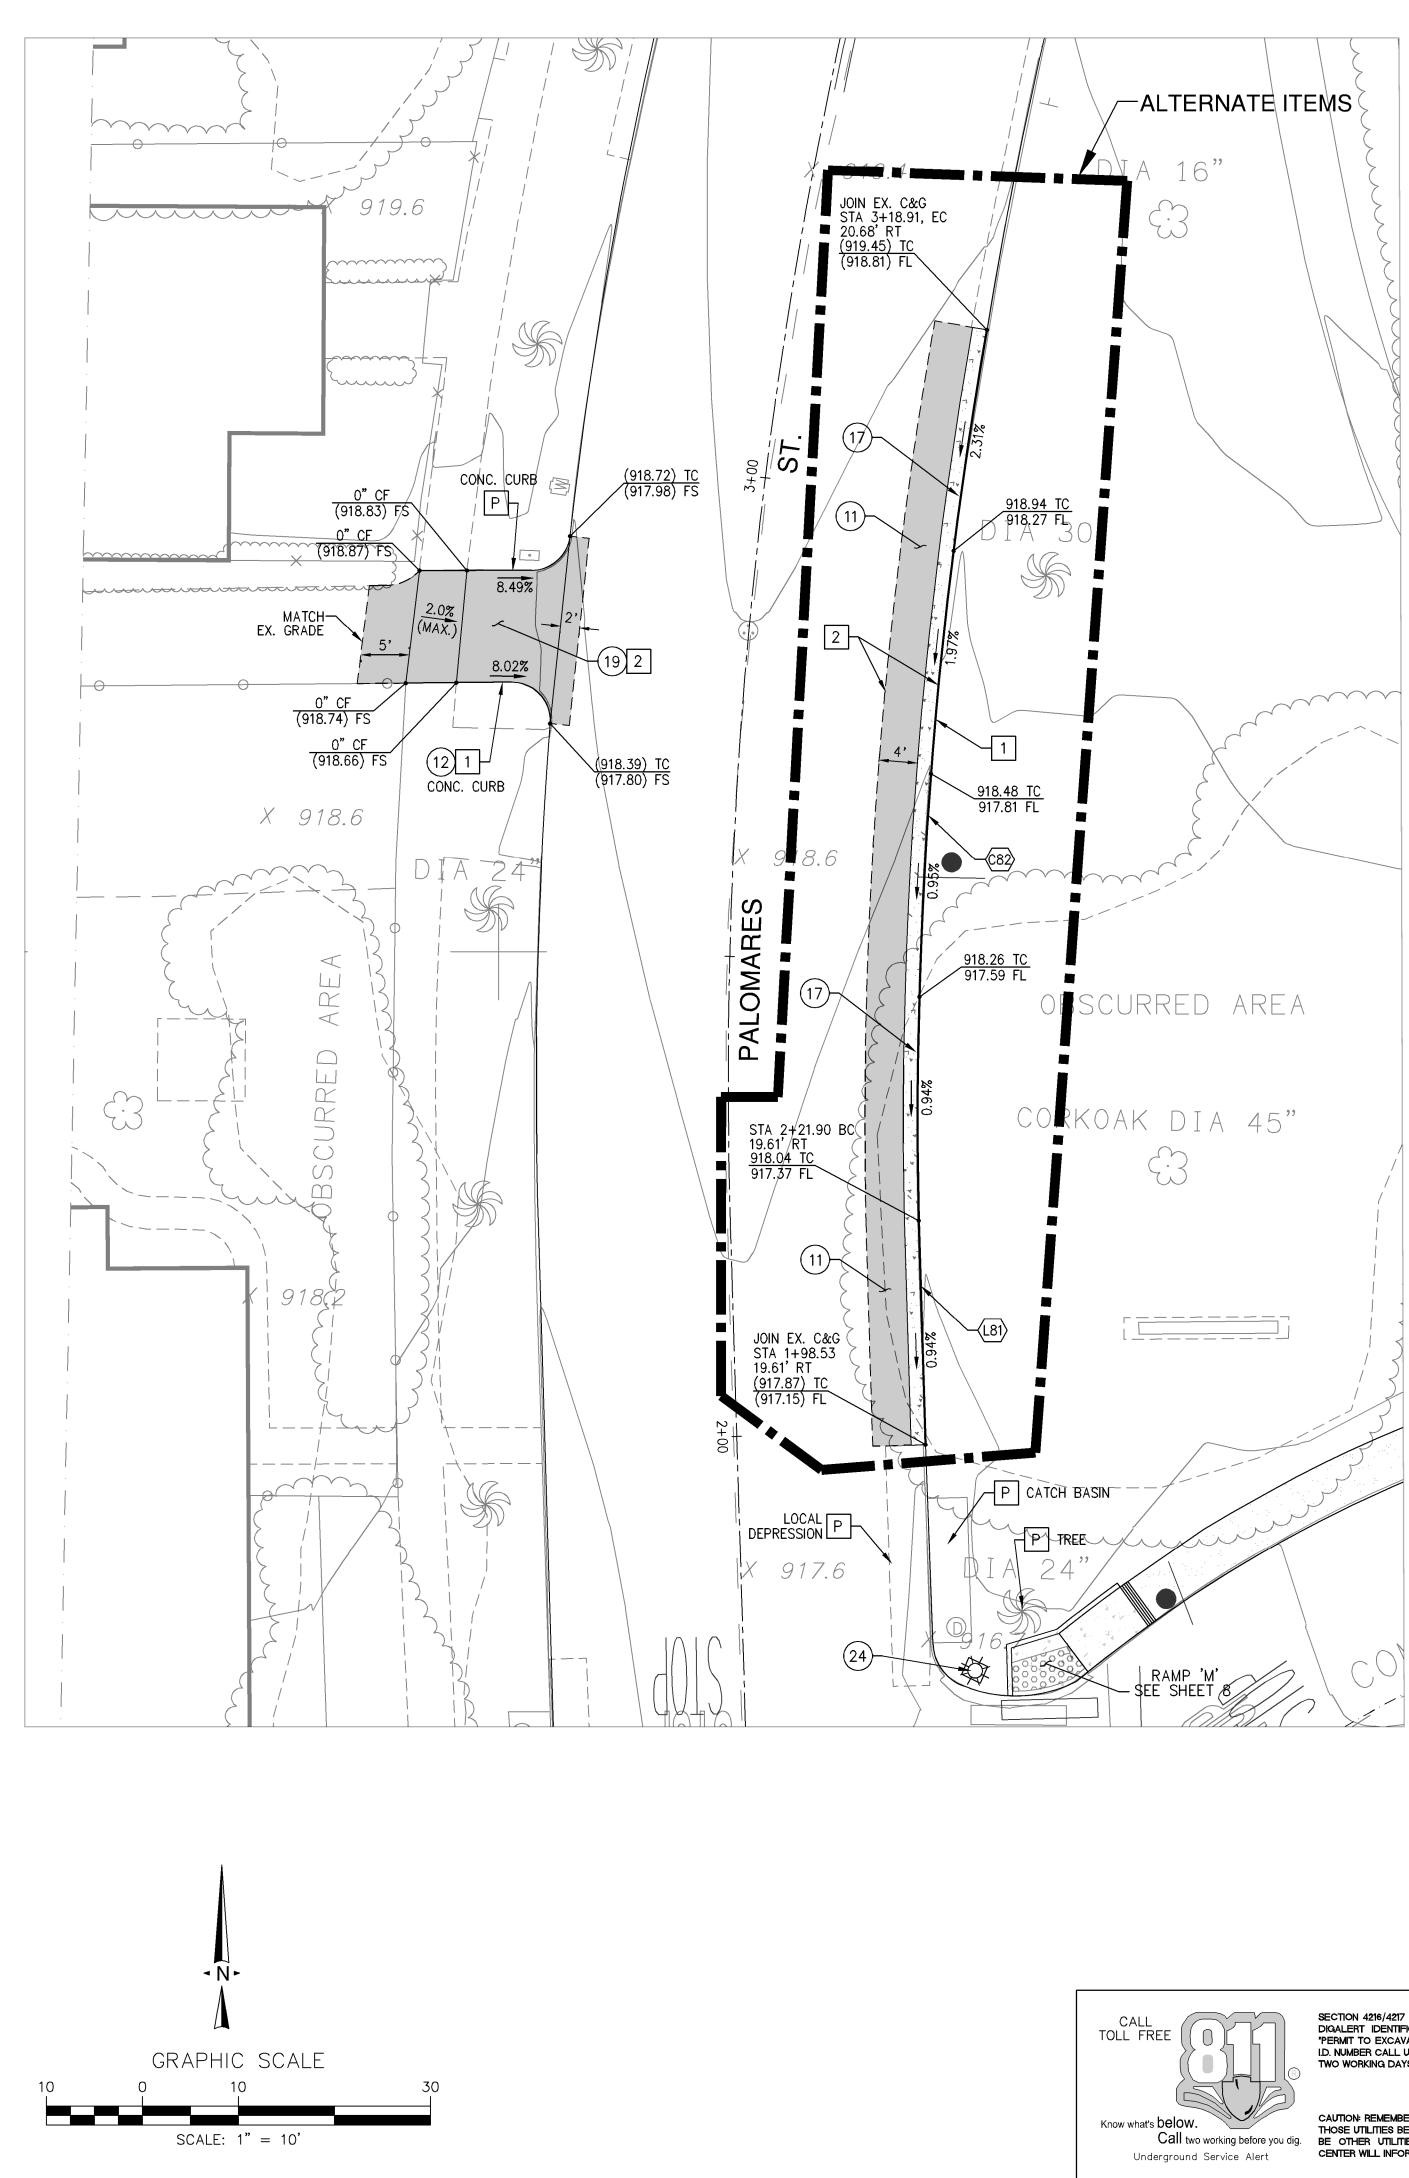CAUTION: REMEMBER THAT THE USA CENTER NOTIFIES ONLY THOSE UTILITIES BELONGING TO THE CENTER. THERE COULD Call two working before you dig. BE OTHER UTILITIES PRESENT AT THE WORK SITE. THE CENTER WILL INFORM YOU OF WHOM THEY WILL NOTIFY.



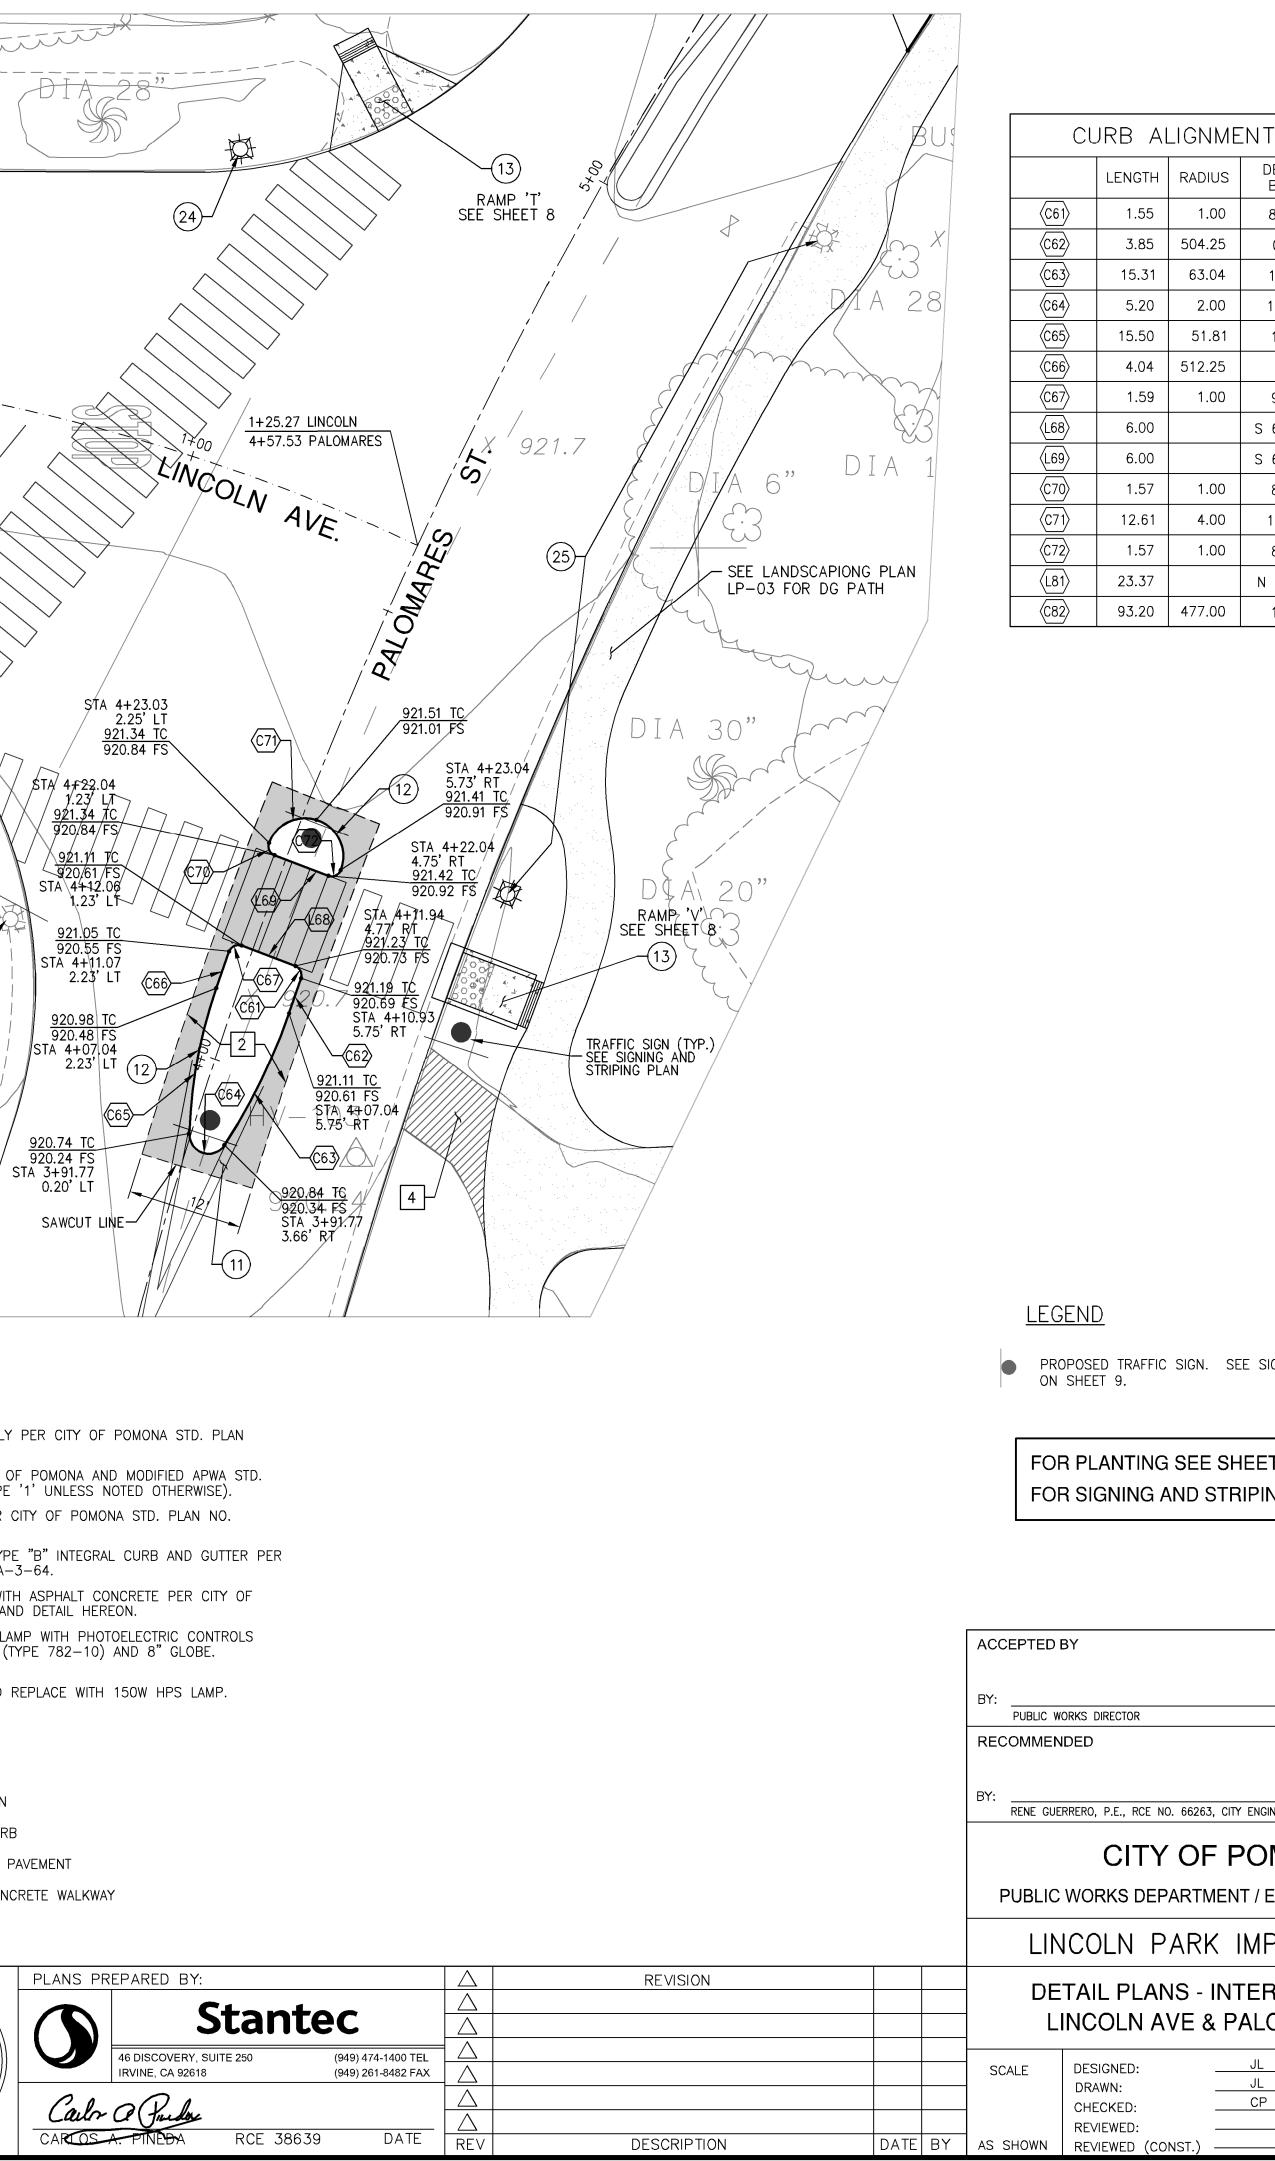

sht. **6** OF

DATE: _____

DATE:

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TANGENT

0.98

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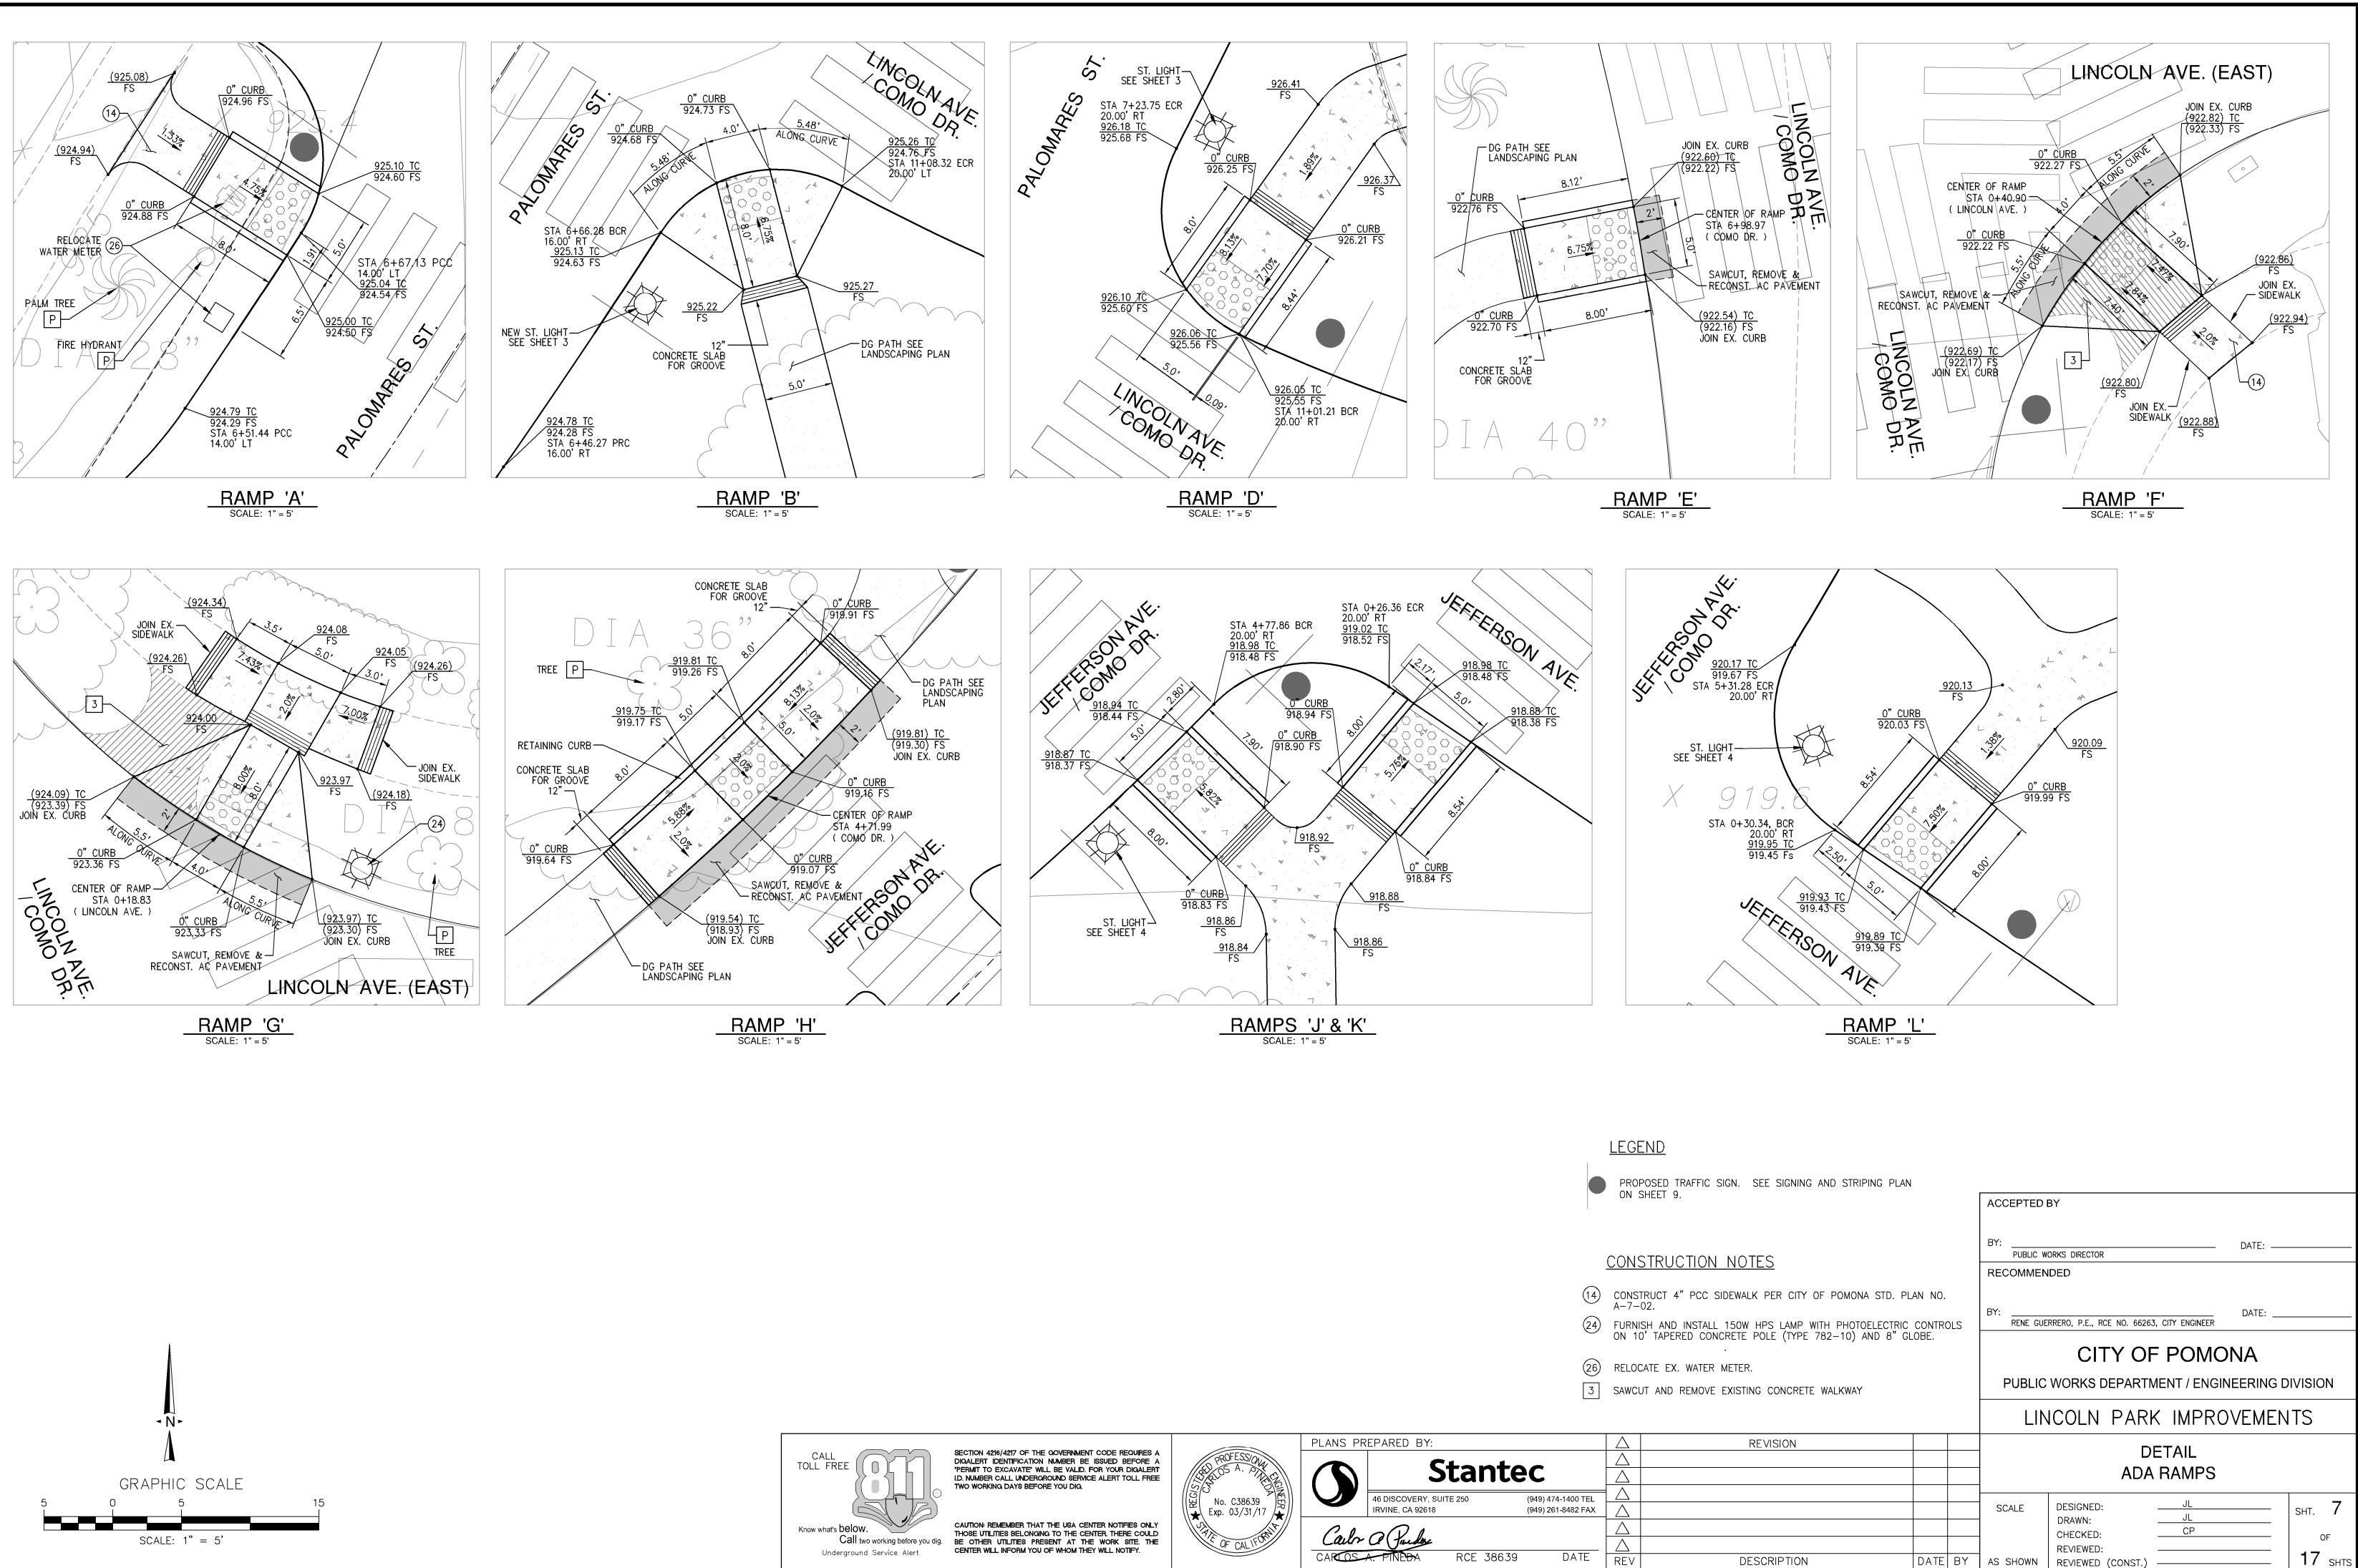
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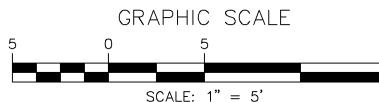
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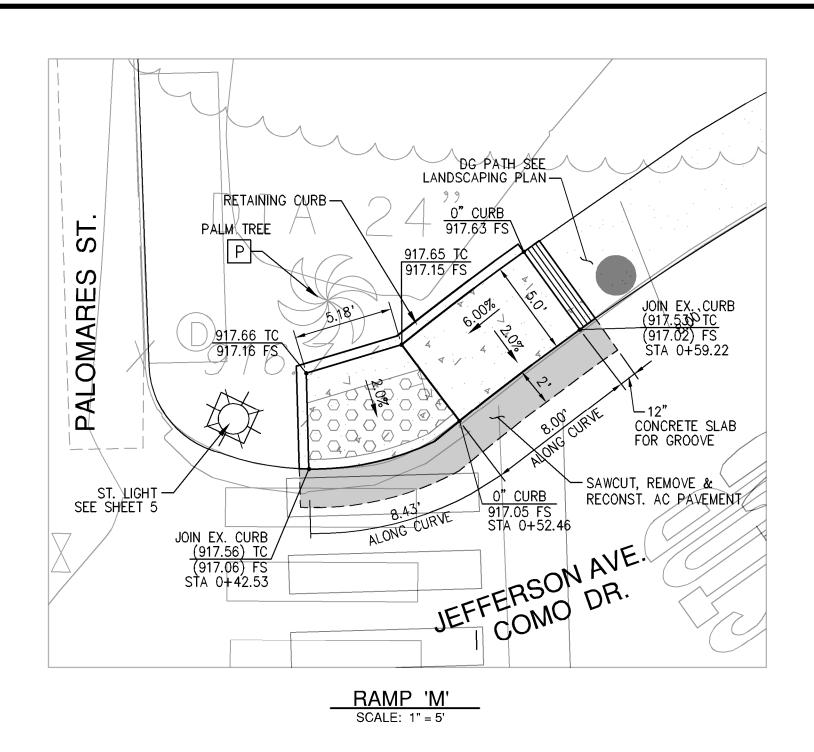
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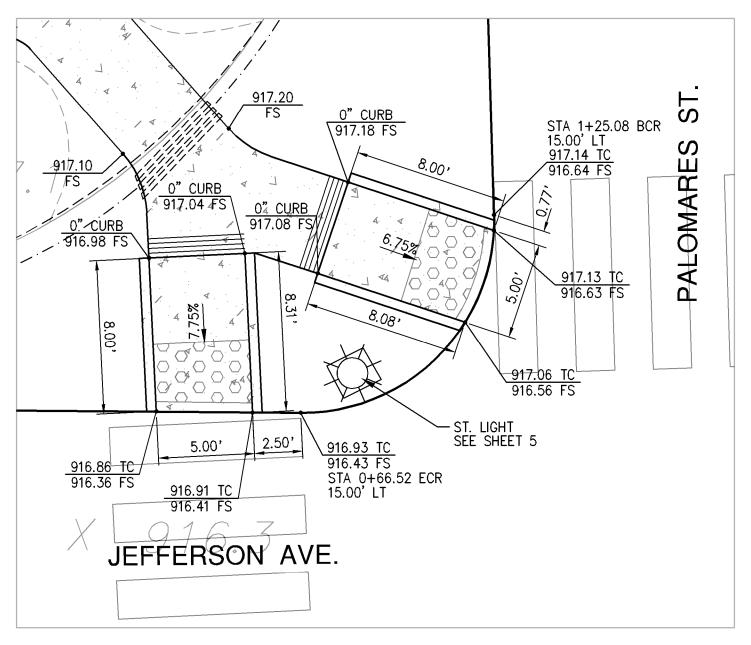
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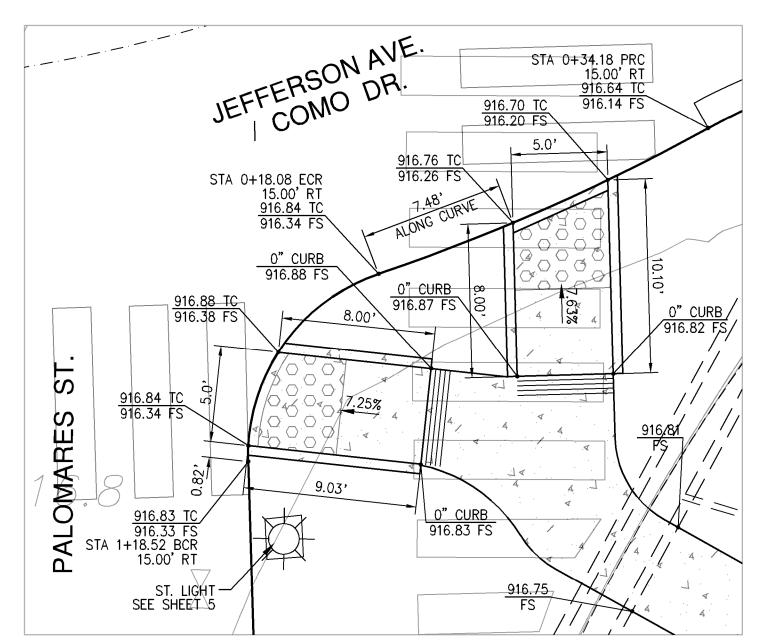





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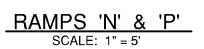








RAMPS 'Q' & 'R' SCALE: 1" = 5'




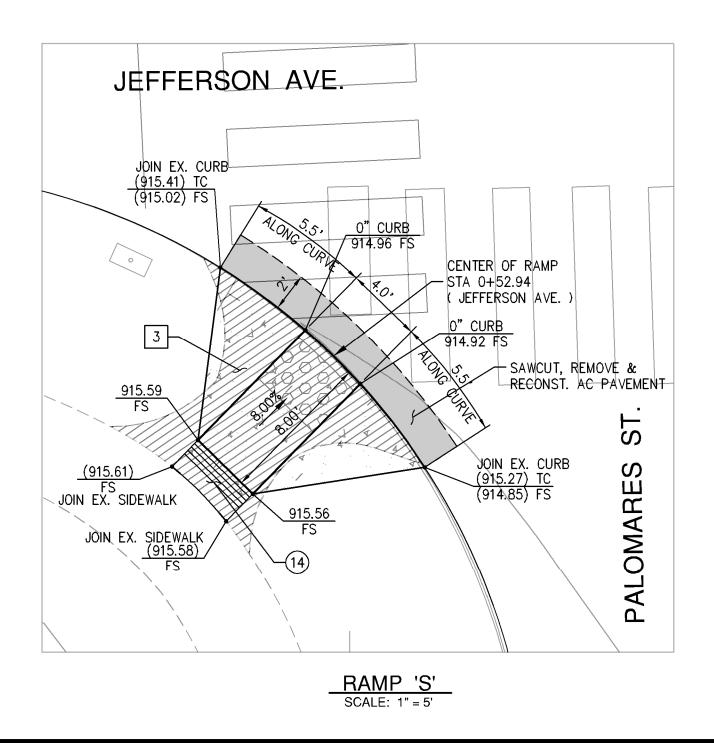

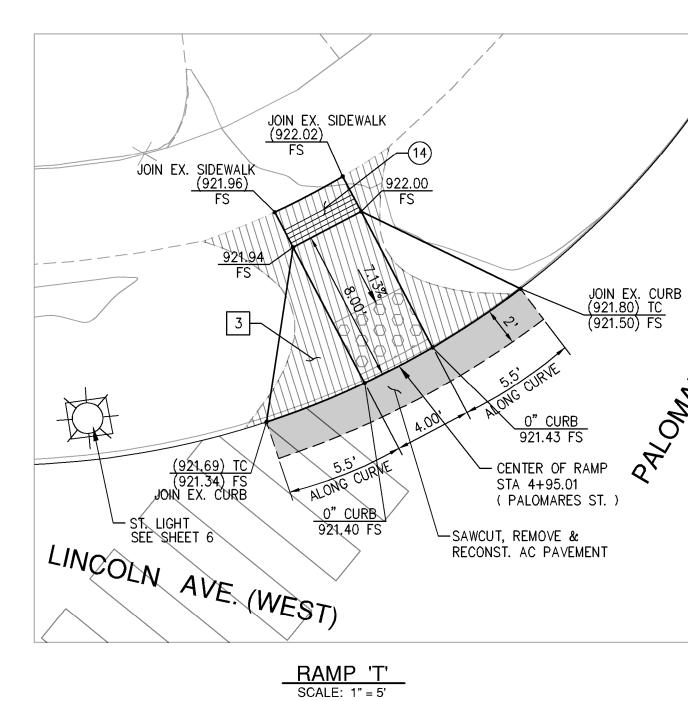


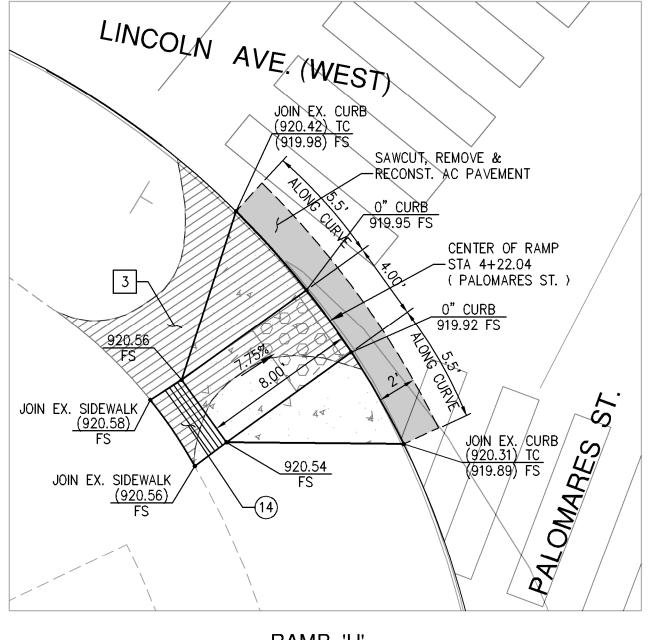



RAMP 'U' SCALE: 1" = 5'

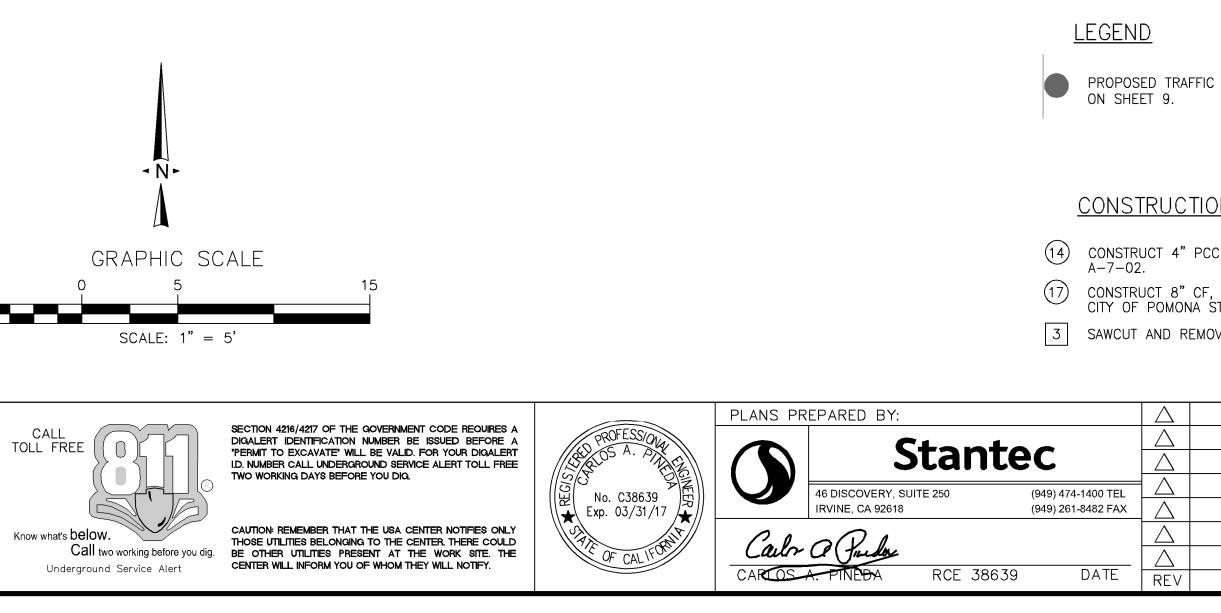


(<u>920.88)</u> TC (<u>920.22)</u> FL JOIN EX. CURB	825% 4	<u>0" CURB</u> 920.94 FS		
C SIGN. SEE SIGNING AND STRIPING PLAN	ACCEPTED	2		
IC SIGN. SEE SIGNING AND STRIFING FLAN	BY:	DRKS DIRECTOR	DAT	'E:
<u>on notes</u>	RECOMMEN			
CC SIDEWALK PER CITY OF POMONA STD. PLAN NO.	BY:RENE GUEF	RRERO, P.E., RCE NO. 6626	3, CITY ENGINEER	re:
F, 18" GUTTER TYPE "B" INTEGRAL CURB AND GUTTER PER STD. PLAN NO. A–3–64. IOVE EXISTING CONCRETE WALKWAY	PUBLIC		F POMONA	
			K IMPROVEI	
REVISION		D	ETAIL A RAMPS	
	SCALE	DESIGNED: DRAWN:	JL	
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DESCRIPTION DATE E	3Y AS SHOWN	REVIEWED (CONST.)		17 SHTS

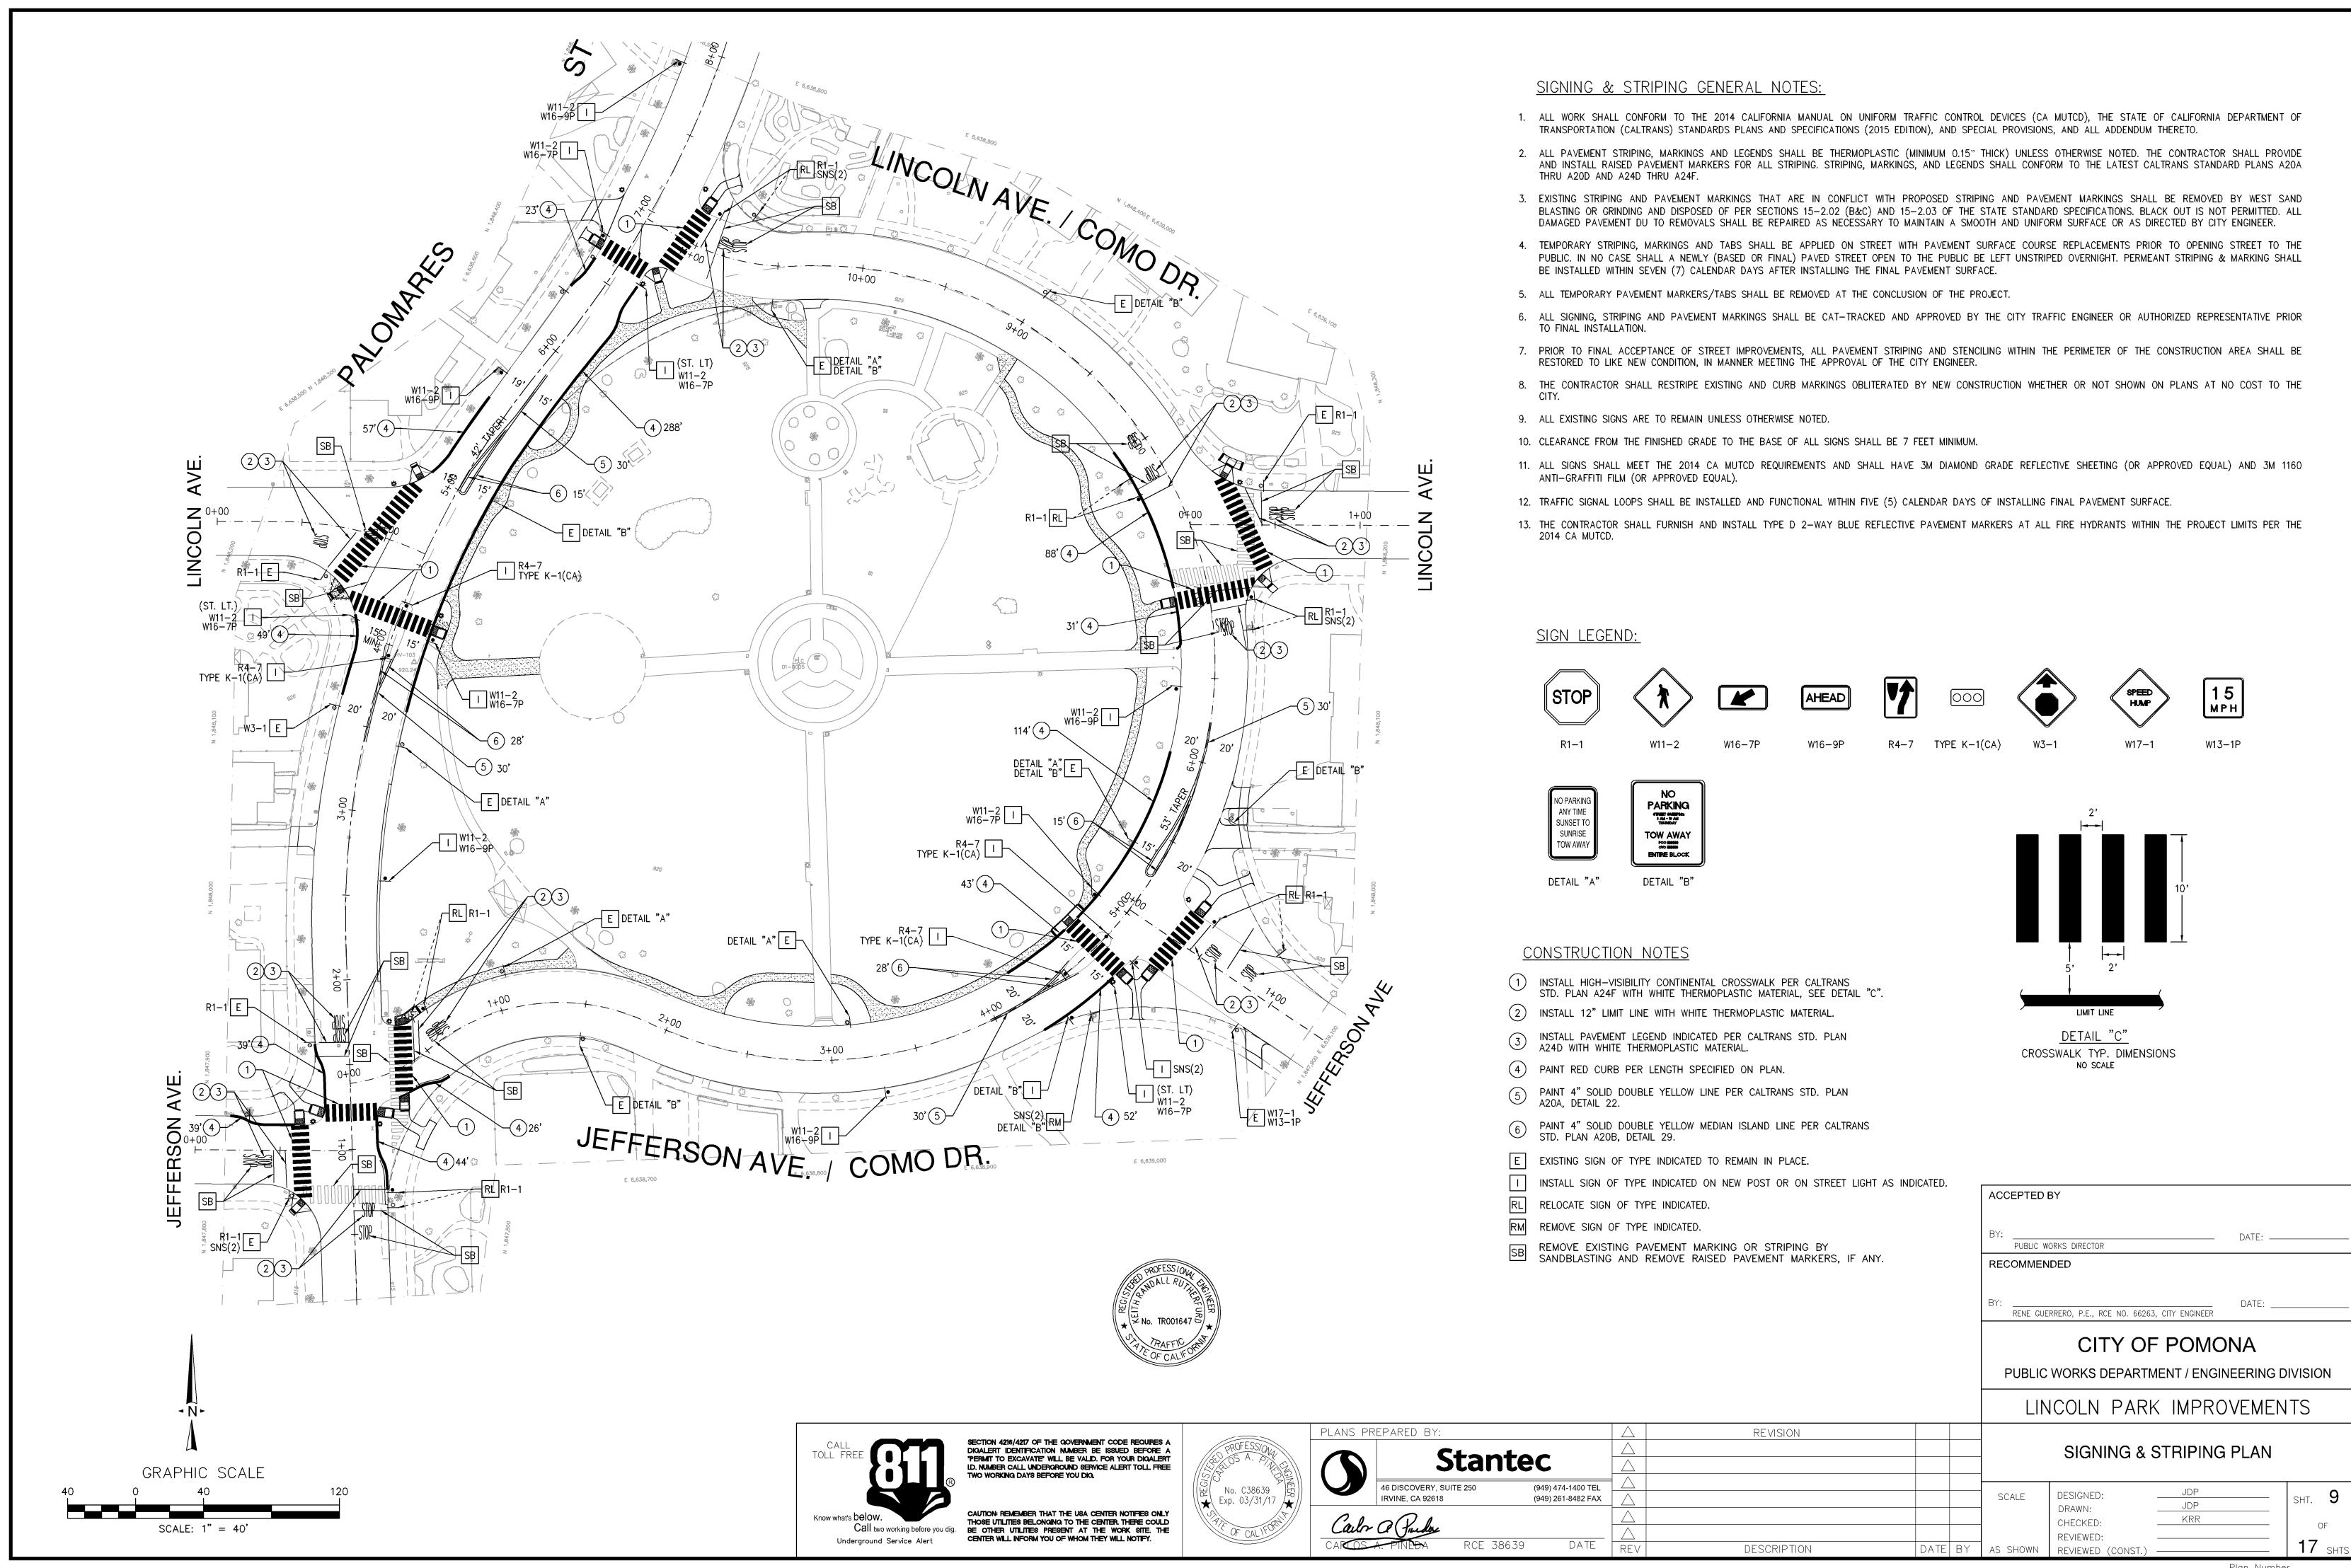

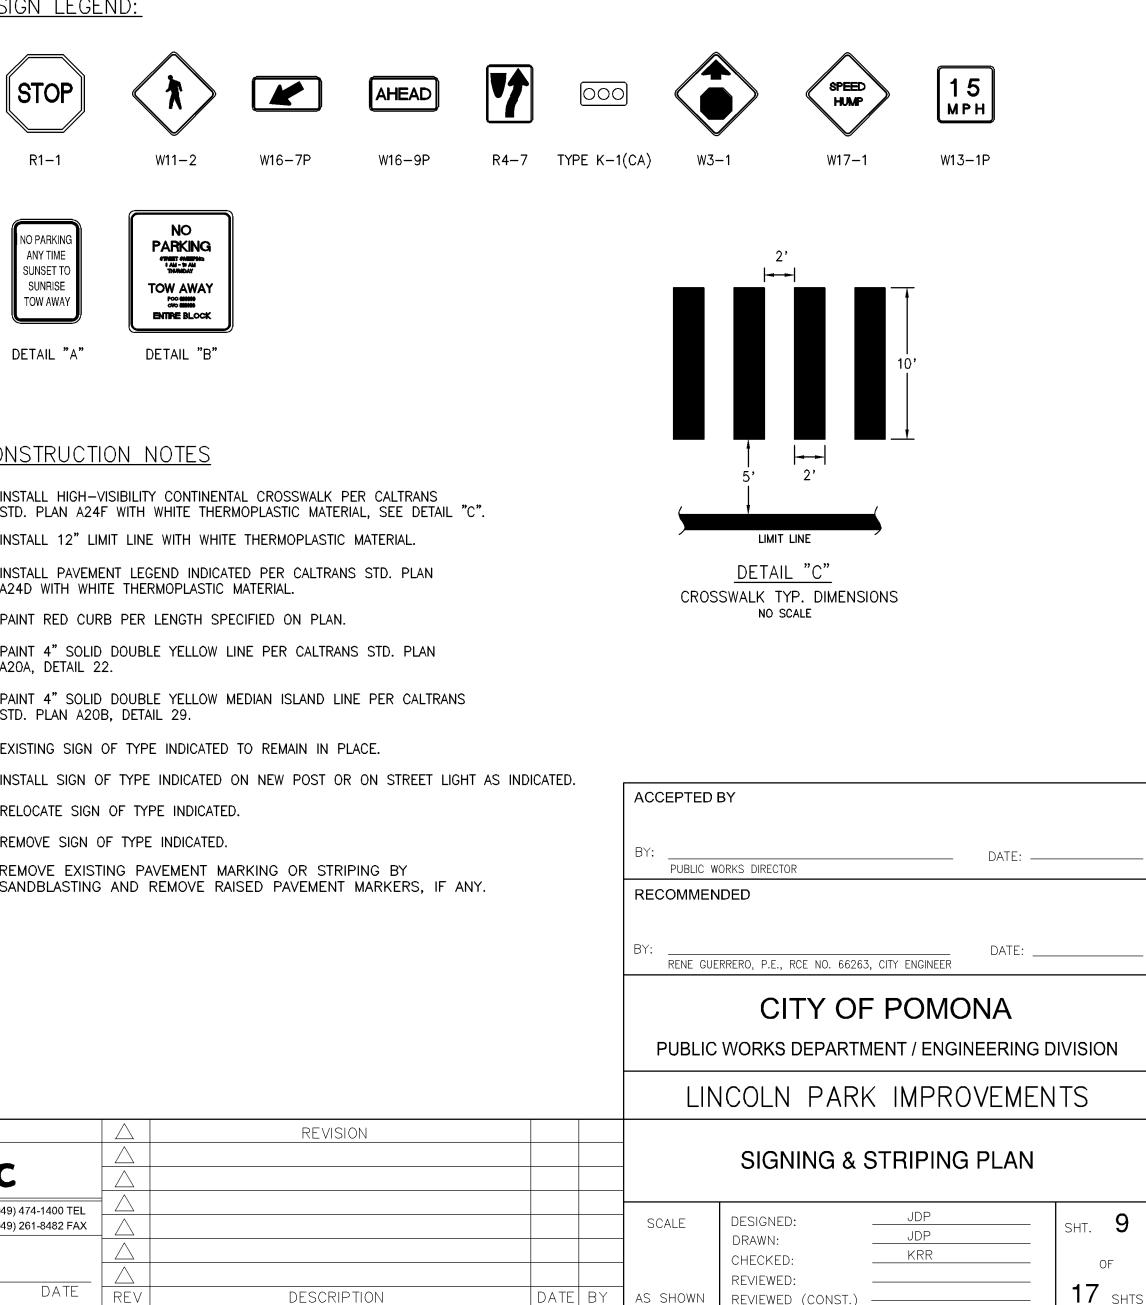

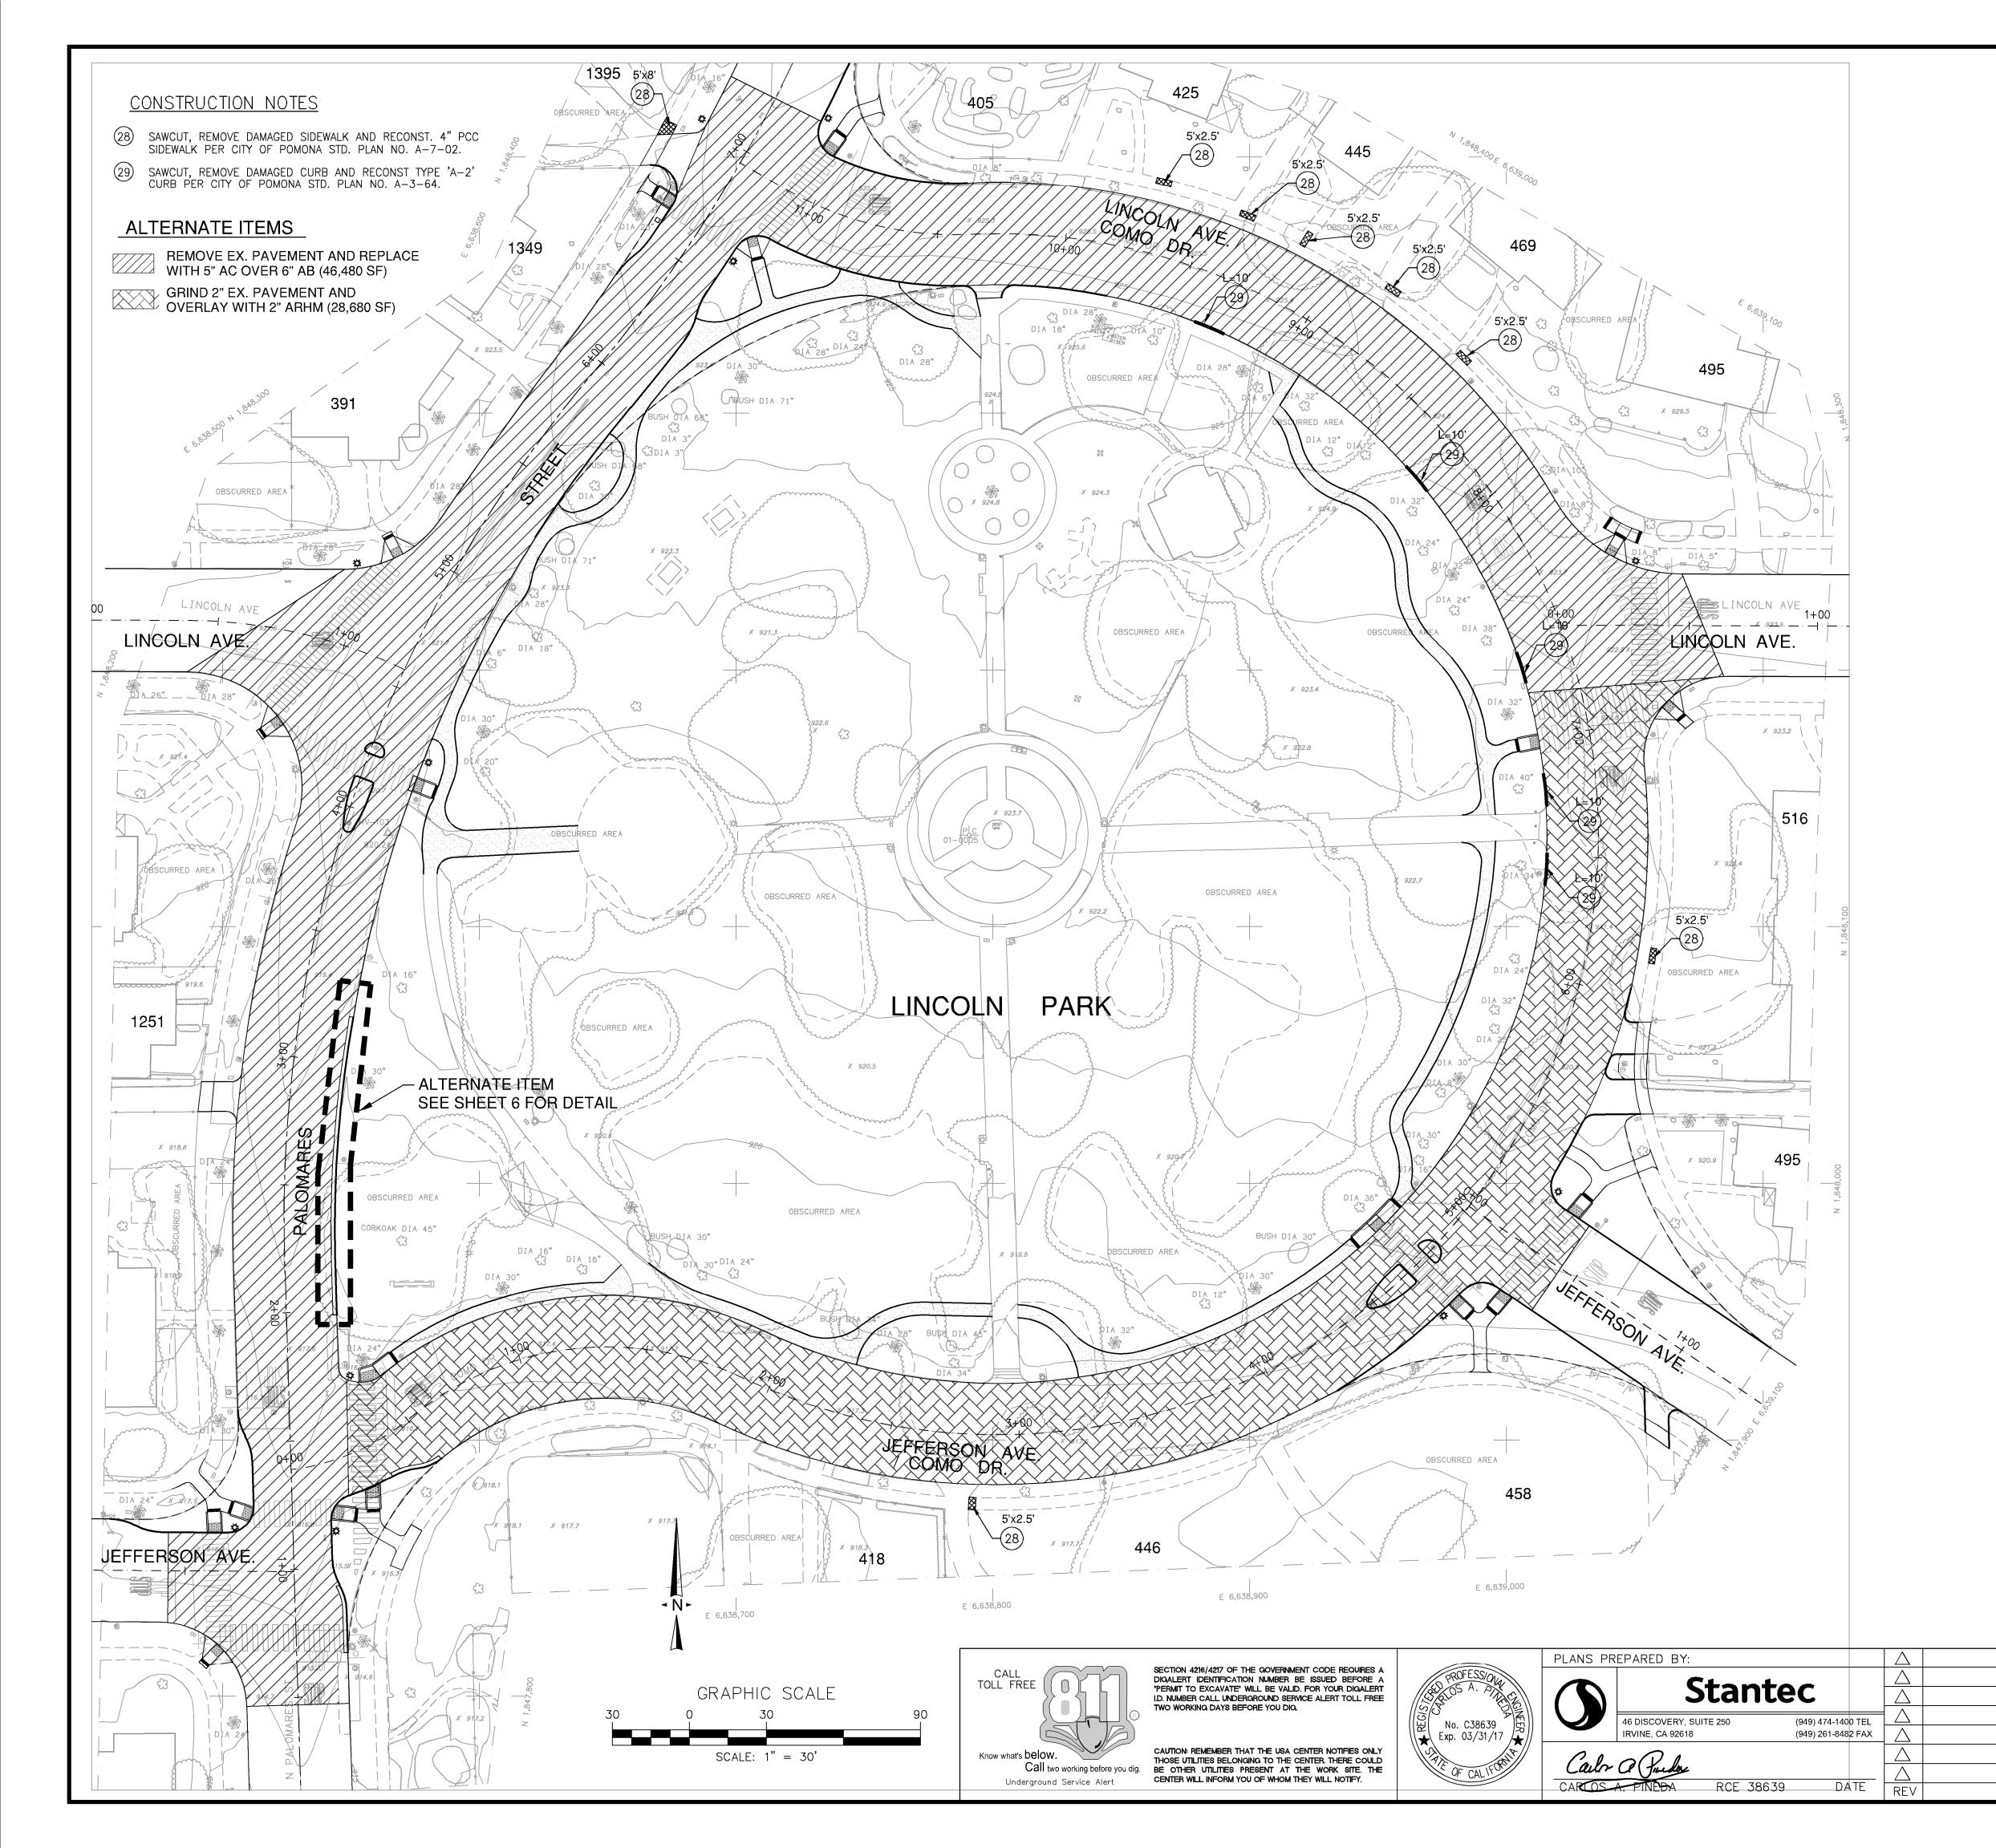

			ACCEPTED	BY			
			BY:	ORKS DIRECTOR		DATE:	
			RECOMMEN	DED			
			BY: RENE GUE	RRERO, P.E., RCE NO. 66263	, CITY ENGINEER	DATE:	
				CITY OF		A	
			PUBLIC	WORKS DEPARTM	1ENT / ENGINE	ERING D	IVISION
			LIN	ICOLN PARK	K IMPROV	EMEN	TS
REVISION			STREE	T REHAB, SID	EWALK & C	URB F	REPAIR
				DG PATH HO	RIZONTAL	CONT	ROL
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DESCRIPTION	DATE	BY	AS SHOWN	CHECKED: REVIEWED: REVIEWED (CONST.)	CP		ог 17 SHTS
					PI	an Numbe	r

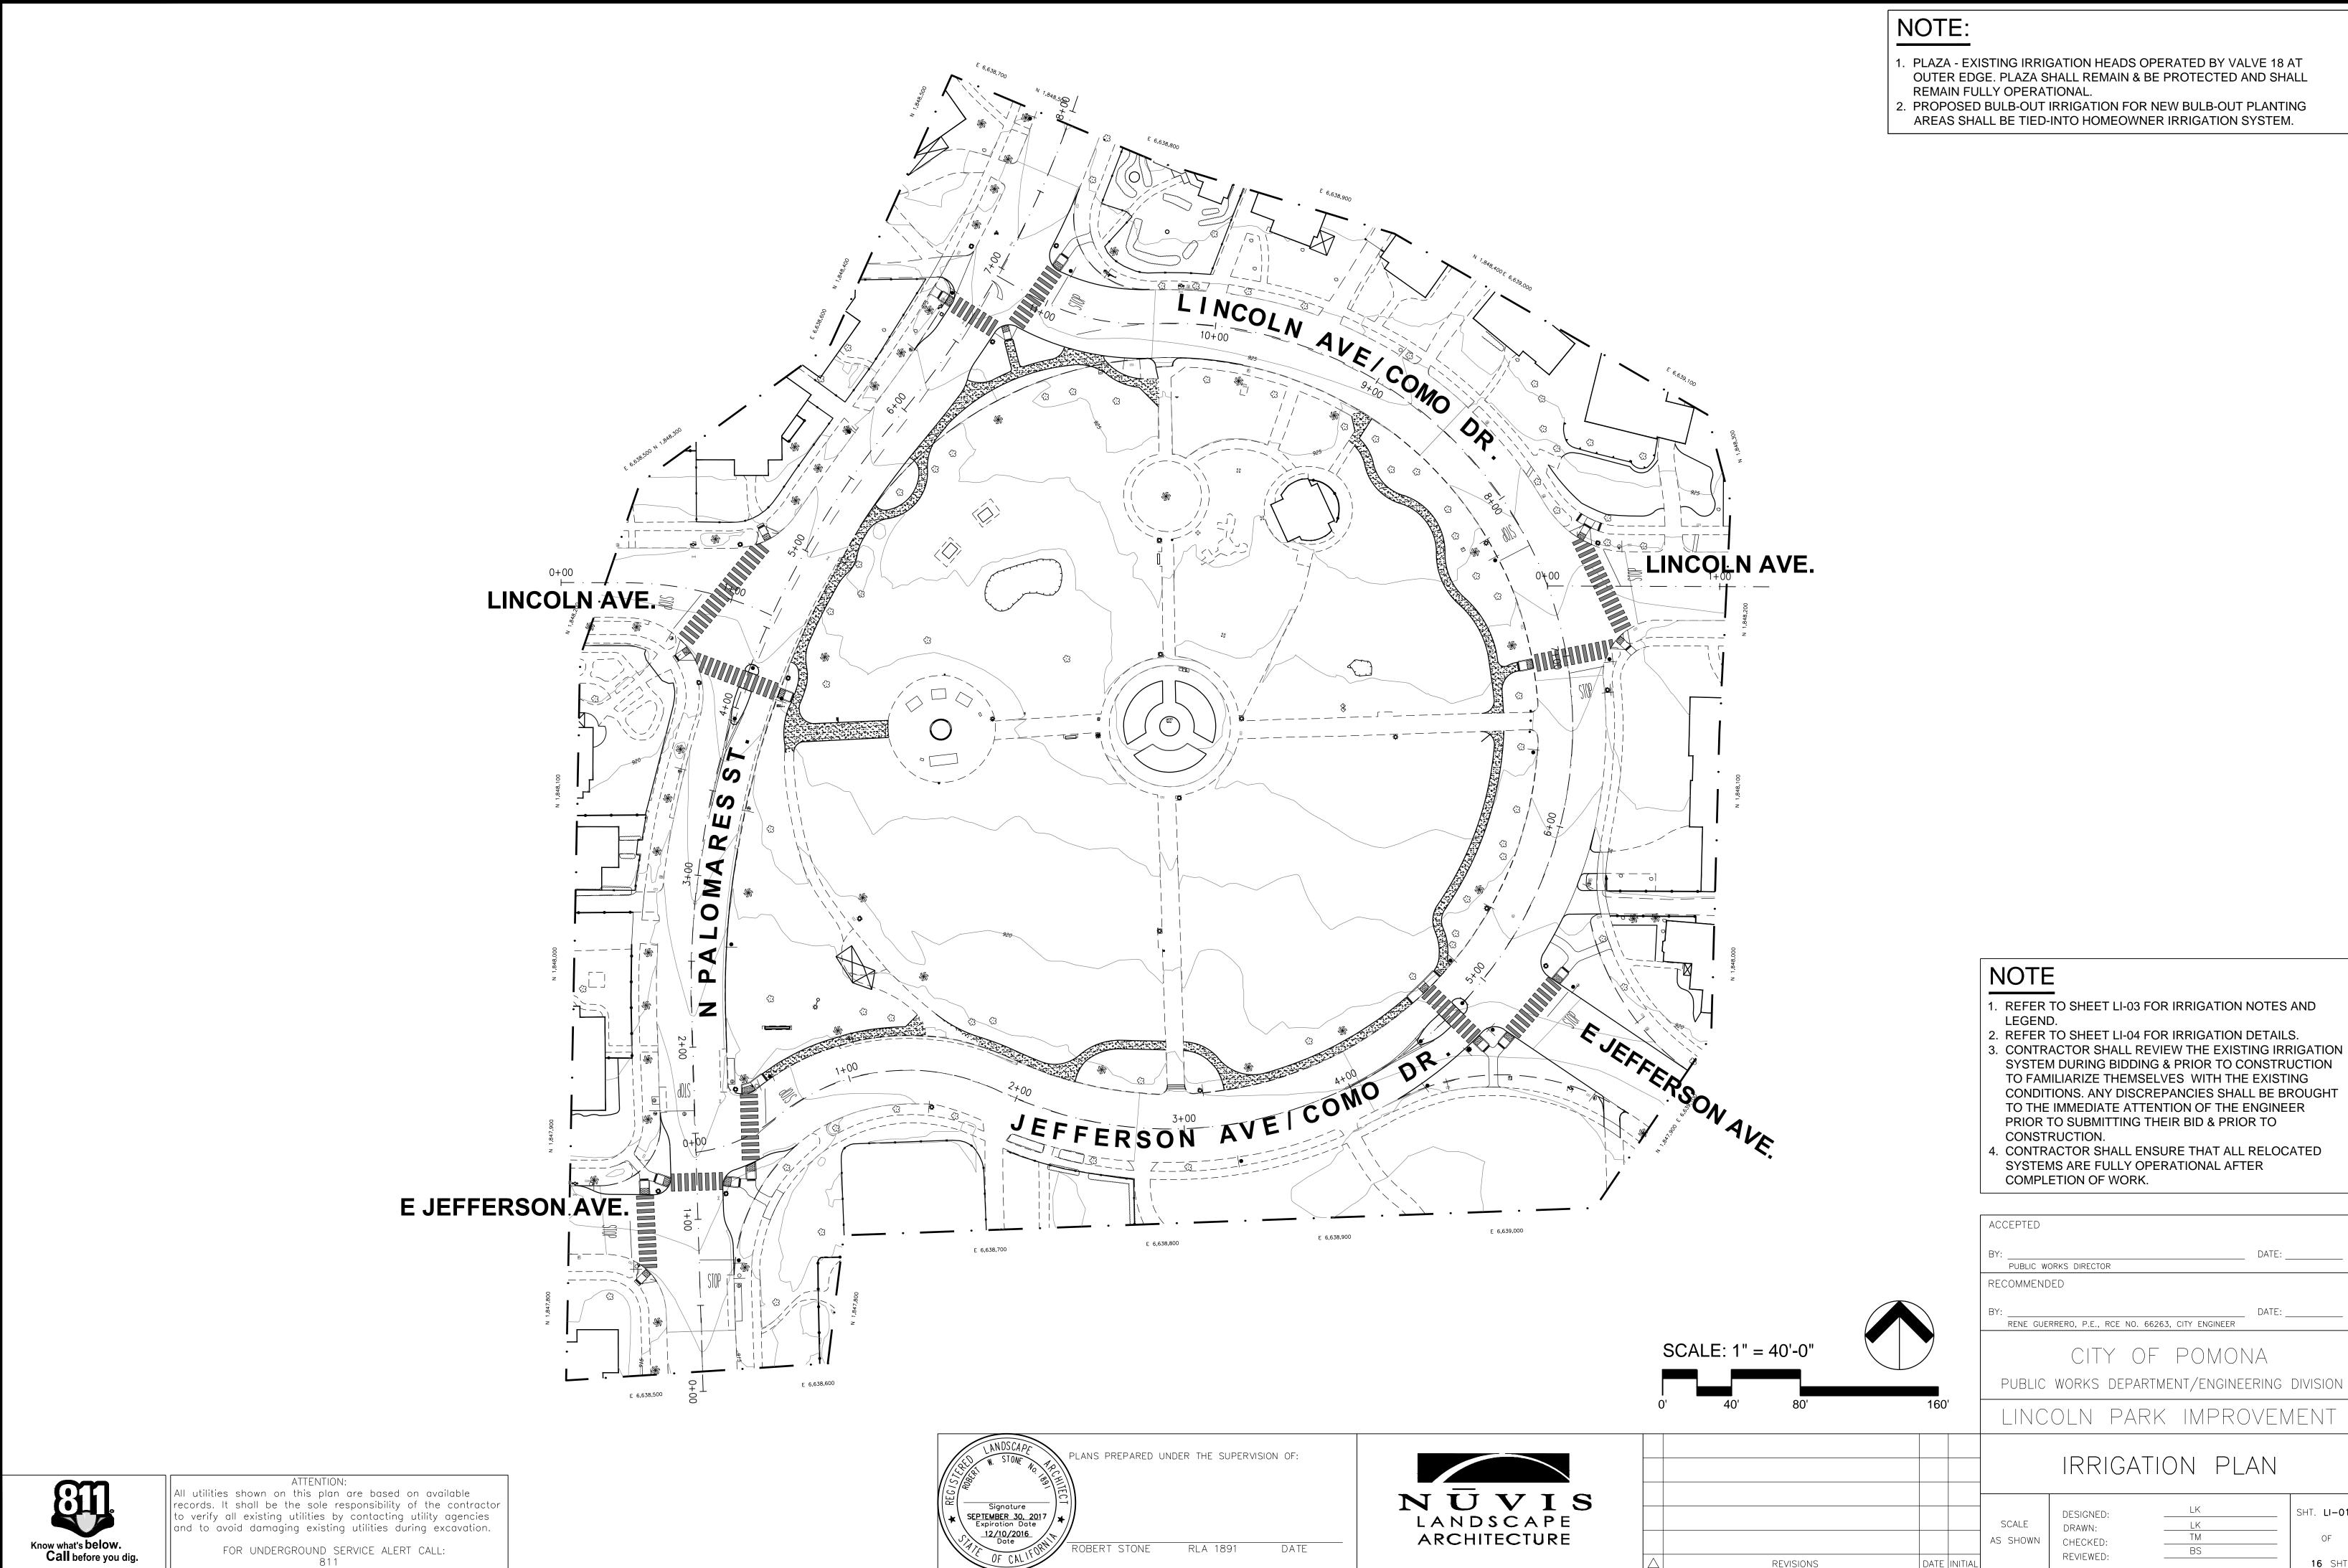

- . PLAZA EXISTING IRRIGATION HEADS OPERATED BY VALVE 18 AT OUTER EDGE. PLAZA SHALL REMAIN & BE PROTECTED AND SHALL
- 2. PROPOSED BULB-OUT IRRIGATION FOR NEW BULB-OUT PLANTING AREAS SHALL BE TIED-INTO HOMEOWNER IRRIGATION SYSTEM.

SHT. LI-01

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16 9

IRRIGATION NOTES

- CONTRACTOR SHALL PROVIDE ALL LABOR, MATERIALS, AND EQUIPMENT NECESSARY TO FURNISH AND INSTALL THE IRRIGATION SYSTEM AS SHOWN ON THE DRAWINGS, AS DESCRIBED IN THE SPECIFICATIONS, AND IN ACCORDANCE WITH APPLICABLE CODES AND ORDINANCES.
- DESIGN REFLECTS COMPLIANCE WITH CALIFORNIA STATE ASSEMBLY BILL 325 (AB 325) AND THE STATE'S MODEL ORDINANCE AND/OR THE LOCAL GOVERNING AGENCY'S ADOPTED WATER EFFICIENT LANDSCAPE ORDINANCE.
- DRAWINGS ARE DIAGRAMMATIC. CONTRACTOR SHALL BE RESPONSIBLE FOR ADJUSTMENTS NECESSARY TO CONFORM TO ACTUAL FIELD CONDITIONS.
- CONTRACTOR SHALL FLUSH ALL LINES AND ADJUST ALL HEADS FOR OPTIMUM PERFORMANCE IN ACCORDANCE WITH THE SPECIFICATIONS AND TO PREVENT OVERSPRAY ONTO HARDSCAPE AREAS OR STRUCTURAL ELEMENTS. THIS SHALL INCLUDE 5 SELECTING THE BEST DEGREE OF ARC TO FIT ACTUAL SITE CONDITIONS AND TO THROTTLE THE FLOW CONTROL AT EACH VALVE TO OBTAIN THE OPTIMUM OPERATING PRESSURE FOR EACH SYSTEM. COSTS INCURRED DUE TO ANY ADJUSTMENTS FOR 100% COVERAGE, INCLUDING THOSE REQUESTED BY THE CITY/OWNER'S AUTHORIZED REPRESENTATIVE SHALL BE THE RESPONSIBILITY OF THE CONTRACTOR.
- SYSTEM DESIGN IS BASED ON A MINIMUM OPERATING PRESSURE (P.S.I.) AND A MAXIMUM DEMAND (G.P.M.) AS SHOWN AT EACH POINT OF CONNECTION ON THE DRAWINGS. CONTRACTOR SHALL VERIFY PRESSURE AND DEMAND AT EACH POINT OF CONNECTION PRIOR TO COMMENCING INSTALLATION AND SUBMIT SUCH IN WRITING TO THE CITY/OWNER'S AUTHORIZED REPRESENTATIVE. IF ANY DISCREPANCIES EXIST, THEY SHOULD BE BROUGHT TO THE IMMEDIATE ATTENTION OF THE CITY/OWNER'S AUTHORIZED REPRESENTATIVE.
- EQUIPMENT SHOWN IN HARDSCAPE AREAS ARE FOR DESIGN CLARIFICATION ONLY AND SHALL BE INSTALLED WHENEVER POSSIBLE WITHIN PLANTED AREAS A REASONABLE, REACHABLE DISTANCE FROM HARDSCAPE OR TURF AREAS.
- UNLESS OTHERWISE NOTED ON THE DRAWINGS, CONTRACTOR SHALL INSTALL WIRE AND PIPE UNDER HARDSCAPE AREAS IN P.V.C. SCHEDULE 40 SLEEVES PLACED PRIOR TO INSTALLING HARDSCAPE IN ACCORDANCE WITH APPLICABLE CODES.
- . WHEREVER POSSIBLE, CONTROL WIRES SHALL OCCUPY THE SAME TRENCH AS PIPES. 9. EACH CONTROLLER SHALL HAVE ITS OWN INDEPENDENT GROUND WIRE.
- SPLICING OF 24 VOLT WIRES WILL NOT BE PERMITTED EXCEPT IN VALVE BOXES. CONTRACTOR TO LEAVE A 24" COIL OF EXCESS WIRE AT EACH SPLICE AND EVERY 100' ON CENTER ALONG WIRE RUN. TAPE WIRE BUNDLES 10' ON CENTER. NO TAPING WILL BE PERMITTED INSIDE SLEEVES.
- 11. WIRE CONNECTORS SHALL BE SCOTCH DBY OR APPROVED EQUAL. 12. CONTROL VALVES SHALL BE SIZED AS DESIGNATED ON THE DRAWINGS AND SHALL BE INSTALLED IN VALVE BOXES AS INDICATED IN THE DETAILS. BOXES SHALL BE SET FLUSH WITH THE FINISH GRADE OR SURFACE AND PERMANENTLY MARKED WITH THE LETTERS R.C.V.
- 13. FINAL LOCATION FOR BACKFLOW PREVENTION DEVICES SHALL BE APPROVED BY THE CITY'S/OWNER'S AUTHORIZED REPRESENTATIVE PRIOR TO INSTALLING. CONTRACTOR SHALL NOTIFY ALL LOCAL JURISDICTIONS FOR INSPECTION AND TESTING OF INSTALLED BACKFLOW PREVENTION DEVICE.
- 4. CONTRACTOR SHALL INSTALL ANTI-DRAIN CHECK VALVES AS NECESSARY TO PREVENT LOW HEAD DRAINAGE.
- 15. ALL IRRIGATION HEADS ADJACENT TO HARDSCAPE SHALL BE POP-UP STYLE. 16. IRRIGATION HEADS SHALL BE SET PERPENDICULAR TO FINISH GRADE OF THE AREA TO BE
- IRRIGATED UNLESS OTHEWISE DESIGNATED ON THE PLANS. 17. BUBBLERS SHALL BE LOCATED ON THE UPHILL SIDE OF TREES.

VALVE LOCATION NOTE

ELECTRIC CONTROL VALVES AND ISOLATION VALVE LOCATIONS ON THESE DRAWINGS ARE APPROXIMATE. THE LANDSCAPE CONTRACTOR SHALL STAKE OUT EACH ELECTRICAL CONTROL VALVE AND ISOLATION VALVE LOCATION FOR REVIEW AND APPROVAL BY ENGINEER PRIOR TO INSTALLATION OF ALL VALVES. FINAL LOCATION AND EXACT POSITIONING FOR ELECTRIC CONTROL VALVES AND ISOLATION VALVES SHALL BE DETERMINED BY THE ENGINEER. MINOR MODIFICATIONS OF ELECTRIC CONTROL VALVES AND ISOLATION VALVE LOCATIONS AS REQUESTED BY THE ENGINEER SHALL BE PROVIDED BY CONTRACTOR AT NO ADDITIONAL COST TO THE OWNER. FAILURE TO OBTAIN ENGINEER'S APPROVAL PRIOR TO THE INSTALLATION SHALL CAUSE THE CONTRACTOR TO MAKE ENGINEER DIRECTED REVISIONS AT NO ADDITIONAL COST TO THE OWNER. IN GENERAL, OTHERWISE DIRECTED BY ENGINEER, ALL VALVES SHALL BE INSTALLED ONE FOOT FROM EDGE OF HARDCAPE, WALK OR CURB IN SHRUB PLANTING AREAS.

PRESSURE LOSS CALCULATIONS

WATER PRESSURE CALCULATIONS							
POC NUMBER	{	Х	POC SIZE				Х
HYDRAULIC G	RADE LINE	-	POC ELEVATION				-
ELEVATION D	IFFERENCE	-	MINIMUM STATIC WA	TER PRE	ESSURE		Х
REMOTE CON	TROL VALVE #	Х	REMOTE CONTROL V	ALVE S	ZE		Х
R.C.V. DEMAN	ND (GPM)	Х	TOTAL DEMAND (GPI	M)			Х
HIGHEST HEA	D ELEVATION	-	STATIC PRESSURE A	TR.C.V.	L.		-
SIZE		DESCRIPT	ION		PSI LOSS		
Χ"	SERVICE LINE			1	Х	PSI	
Χ"	WATER METER			2	Х	PSI	
Χ"	BACKFLOW PRE	VENTER		3	Х	PSI	
Χ"	BALL VALVES			4	Х	PSI	
Χ"	MASTER CONTR	OL VALVE		5	Х	PSI	
Χ"	XXX FEET OF MA	INLINE: TYPE CLAS	S 315	6	Х	PSI	
-	FEET OF MAINLI	NE: TYPE		7	-	PSI	
Χ"	REMOTE CONTR	OL VALVE		8	Х	PSI	
10%	LATERAL LINE LO	OSS		9	Х	PSI	
10%	FITTING LOSS			10	Х	PSI	
0	FT. OF ELEVATION	ON CHANGE (P.O.C.	TO HIGHEST HEAD)	11	0.0	PSI	
TOTAL SYSTE	M PRESSURE LC	DSS (SUM OF #1 THF	RU #11)	12	0.0	PSI	
PRESSURE R	EQUIRED AT HEA	'D		13	30.0	PSI	
		(SUM OF #12 AND #	13)	14	30.0	PSI	
STATIC WATE	R PRESSURE (FF	ROM ABOVE)		15	Х	PSI	
RESIDUAL PRESSURE (SUBTRACT # 14 FROM # 15)			i)	16	#VALUE!	PSI	
SET PRV OR I	MCV AT (# 14 PLU	IS 10 PSI)		17	0.0	PSI	
PRESSURE B	OOST, IF REQUIR	ED (#14-#15 + 20 PS	5I)	18	0.0	PSI	

ATTENTION: Æ All utilities shown on this plan are based on available records. It shall be the sole responsibility of the contractor to verify all existing utilities by contacting utility agencies and to avoid damaging existing utilities during excavation. Know what's **below**. FOR UNDERGROUND SERVICE ALERT CALL: Call before you dig. 811

- 2.

- 7.

- 10.

DRIPLINE P	LAN NOTE	S				IRRIGA	I ION MAI	ERIAL LEGEND
	AMMATIC. INSTALL	-	OMPONENTS	PER MANUFACTU	JRERS	SYMBOL	MANUFACTURER	MODEL NO. / DESCRIPTION
 INSTALL DRIPLINE INSTALL 2" FROM DRIPLINE LATERA CONSISTANT DEP PLACE AIR/VACUL BELOW CHECK VA 1125' OF TOTAL DI PLACE FLUSH VAL POINT ON SLOPES INSTALL IN-LINE C 		APART WITH EMI TED AREA. THE AREA. DRIPLIN E CIRCUIT. THE HIGHEST F NSTALL ONE AIR/ JLIC CENTER OF	RE SHOULD E SHALL BE OINTS OF E VACUUM RE THE EXHAU THAN 3% AN	BE A MINIMUM OF INSTALLED AT A ACH ZONE AND JU LIEF VALVE FOR E ST HEADER OR AT ID WHERE LOW-LI	TWO IST EVERY LOW		RAIN BIRD	XFS-06-12 SUBSURFACE DRIP TUBI INTERNALLY INSTALLED IN THE DRIP TECHNOLOGY TO PREVENT ROOT INTE SOIL GRADE (NOT COUNTING MULCH) DRIP TUBING SHALL BE INSTALLED A SUBSEQUENT INTERIOR ROWS SHALL 16" MAXIMUM SPACING. INSTALL 9 ALONG THE LENGTH OF THE TUBING. IRRIGATION PRODUCTS (866) 582-96 DIRECTION AND SPACING OF THE DR
 CHECK VALVES SI BEFORE THE FLUS 6. ON ALL SLOPES A CONTOUR WHERE ONE-THIRD OF TH 7. PVC SUPPLY AND SAME SIZE FOR TI • 0-8 GPM – 3/4" • 8.1-15 GPM – 1" • 15.1-25 GPM – 1" 	HALL BE PLACED EVE SH VALVE. ND MOUNDS, PLACE E POSSIBLE. INCREAS E SLOPE TO AVOID E FLUSH LINE SIZING G HE ENTIRE ZONE):	ERY 4-5 FEET BE THE DRIPLINE LA SE THE LATERAL XCESS DRAINAG GUIDE (ALL SUPP	TWEEN DRIP ATERALS PAI SPACING B GE. CLY AND FLU	LINE LATERALS AN RALLEL TO THE SL Y 25% ON THE LOV	ND _OPE WER	NO SYMBOL	RAIN BIRD	CONNECTION BETWEEN XFS DRIP TUE BARBED FITTINGS, SCH. 40 PVC THR AT THE END RUN OF THE TUBING U 80 PVC THREADED NIPPLE, A 1/2" ADAPTER FITTING. WHEN THE CONNI TEE FITTING, A 1/2" X LENGTH AS AND TWO (2) XFF-MA-050 17mm E A PVC DISCHARGE HEADER. FLEXIBL PRODUCTS (866) 582-9684.
CONTAMINATION 10. RUN THE DRIPLIN MATERIAL. MAINT	E SYSTEM EVERY DA AIN A CONSISTENT M	Y OR EVERY OTH IOISTURE BALAN	HER DAY TO	ESTABLISH PLANT		NO SYMBOL	RAIN BIRD	XF SERIES 17mm BARBED FITTINGS DRIP TUBING FITTINGS SHALL BE INS NO HEATING OF TUBING SHALL BE A
WATER EFF	DIST WITHOUT SATUR	-	PE CAL	CULATIO	NS		AS APPROVED	PVC SUPPLY AND DISCHARGE HEADE WITH SCH. 40 PVC FITTINGS.
PROJECT NAME: PART ONE:	NAME OF PROJECT					F	GPH IRRIG./ RAIN BIRD	GDFN DRIP FLUSH / INDICATOR NOZ BODY. THE FLUSH NOZZLE SHALL E NORMAL OPERATION OF THE DRIP SY
	MAWA = (ETo) (0.7) (LA) MAWA = (ETo) (0.62) [(0.7) YEARLY ETo CONVERSION FACTOR ET ADJUSTMENT FACTO TOTAL LANDSCAPE ARE ET ADJUSTMENT FACTO	(0.62) 7 x LA) + (0.3 x SLA) PR EA (LA in S.F.)]		0.0 0.00 0.0 0 0.00	A	RAIN BIRD	ARV050 AIR/VACUUM RELIEF VALVE I 3/4" X 1/2" SCH. 40 PVC THREADE PLANTER. SEE PLANS FOR APPROXI LATERAL CONSTRUCTED OF XFD "BLA ELEVATED AREA. MULTIPLE ARV'S MA VALVE BOX.
	TOTAL SPECIAL LANDSC	CAPE AREA (SLA in		MAWA GAL./YR.	0.00		RAIN BIRD	XXX-PEB PLASTIC DRIP REMOTE CON REGULATOR ON THE DOWNSTREAM SI BIRD LCRBY-100D DISC FILTER AND INSIDE A NDS 314BC RECTANGULAR
PART TWO:	ESTIMATED TOTAL WAT ETWU = (ETo) (HA) (PF) (ETWU = (ETo) (0.62) ((PF	(0.62) / (IE)					AS APPROVED	PVC PIPE 1" – 1 1/2" SCH. 40, S FINISHED GRADE
IRRIGATION METHOD SUB-SURFACE (SHRUB) DRIP (SHRUB)	LOW	HYDROZONE AREA (HA in S.F.) 0 0	0.0	0.00	ELWU GAL./YR.) 0 0		AS APPROVED	CL-315 PVC MAINLINE PIPE - 2" A . 2" DIA. OR SMALLER -18" MIN. CO BE PURPLE.
DRIP (SHRUB) SPRAY (LAWN) WATER FEATURE	MEDIUM HIGH HIGH TOTAL	0 0 0	0.0	0.00	0 0 0		AS APPROVED	PVC PIPE SCH. 40 AS SLEEVING, 2 ALL PIPE AND WIRE UNDER PAVING, SLEEVES. SLEEVES UNDER PEDESTR ARE TO BE CONSIDERED EXISTING VE
PART THREE	HYDROZONE INFORMAT HYDROZONE PLANT WATER USE TYPE	ION TABLE	IRRIGATION METHOD	HYDROZONE LA AREA (S.F.)	% OF NDSCAPE AREA	NO SYMBOL	AS APPROVED	ALL SOLVENT WELD CONNECTIONS FO OF PRIMER AND SOLVENT CEMENT. WELD-ON 711 PVC INDUSTRIAL GRAD GRADE CEMENT. USE DAUBERS SIZED CEMENTED JOINTS SHALL BE MADE F
	LOW MODERATE		DRIP		0.00%			1-1/4" MINIMUM SCH. 40 PVC ELECTRICAL
	HIGH		POOL	0	0.00%		NDS	
_	TOTAL				0.00%	PR NO SYMBOL		NDS 312BC ROUND SPLICE BOX FOR DBR/Y-6 DIRECT BURIAL (I.L. APPRO
							NDS	CONNECTIONS

ALL VALVE BOXES SHALL BE NDS SE IN COLOR. LIDS FOR BOXES SHA PENTA HEAD BOLT, WASHER AND CLI

> VAL\ CONT DESIC VAL V NUMB VALVE

HYDR (IF AF

PLANS PREPARED UNDER THE SUPERVISION OF:

NO SYMBOL NDS



SEPTEMBER 30, 2017 Expiration Date ROBERT STONE

Signature

<u>12/10/2016</u> Date

DATE RLA 1891

		DETAIL
NG (COPPER EXTERIOR COLOR) WITH 0.60 GPH, F P TUBING AT 12" O.C. SPACING. DRIP TUBING SH RUSION INTO THE DRIP EMITTER. DRIP TUBING SH AND IN PARALLEL ROWS A MAXIMUM OF 16" ON MAXIMUM OF 4" FROM THE EDGE OF ANY HARDS BE ADJUSTED TO PROVIDE AN EVEN SPACING ACF O" PVC COATED GALVANIZED TUBING STAKES A MAX . TUBING STAKES SHALL BE MODEL #GDTS14090 684. THE HATCH PATTERN SYMBOLS ON THE PLA TUBING ROWS, SEE ACTUAL SPACING REQUIREM	ALL BE EQUIPPED WITH COPPER CHIP HALL BE INSTALLED 2" BELOW FINISHED CENTER. THE PERIMETER ROW OF SCAPE OR TURF EDGE. ALL ROSS THE PLANTER WITHOUT EXCEEDING KIMUM OF FIVE (5) FEET ON CENTER OO AS MANUFACTURED BY GPH	B,F SHT. L-03
BING AND PVC SUPPLY AND DISCHARGE HEADERS READED FITTINGS, SCH. 80 NIPPLES AND FLEXIBLE USE A 1/2" SCH. 40 PVC THREADED 90° ELBOW, X 6" MIPT X FIPT FLEXIBLE NIPPLE, AND A XFF- ECTION IS IN THE MIDDLE OF THE TUBING RUN US REQUIRED SCH. 80 PVC THREADED NIPPLE, A 1/ BARB X 1/2" MIPT ADAPTERS. ALL END RUNS O LE NIPPLES SHALL BE MODEL #GFN050600 AS MA	NIPPLES. WHEN THE CONNECTION IS A 1/2" X LENGTH AS REQUIRED SCH. MA-050 17mm BARB X 1/2" MIPT SE A 1/2" SCH. 40 PVC THREADED /2" X 6" MIPT X FIPT FLEXIBLE NIPPLE, OF TUBING SHALL BE CONNECTED WITH	
FOR ALL CONNECTIONS BETWEEN DRIP TUBING (TI STALLED USING A FITINS-TOOL FOR PROPER INSER ALLOWED.		
RS SHALL BE PVC LATERAL LINE PIPE (AS SHOWN	N BELOW), 1 1/4" MINIMUM SIZE	B,F SHT. L-03
ZZLE, ORANGE IN COLOR, INSTALLED ONTO A RAIN BE ORIENTED TO SEND FLUSH WATER INTO THE PI YSTEM.		C SHT. L-03
INSTALLED WITH A XFD—TFA—075 BARB X BARB X ED REDUCER BUSHING. INSTALL AIR RELIEF ASSE IMATE LOCATION AND QUANTITY OF ARV'S PER DRI ANK" XF TUBING, CONNECT AIR RELIEF VALVE TO A AY BE REQUIRED PER DRIP TUBING ZONE, SEE PL	MBLY AT THE HIGH POINT OF EACH P ZONE. USING AN AIR RELIEF ALL DRIP LINE LATERALS WITHIN THE	I SHT. L-03
NTROL VALVE, SIZE AS SHOWN (1") . INSTALL A IDE OF EACH DRIP REMOTE CONTROL VALVE (DRCV A SENNINGER 1" PMR-40-MF PRESSURE REGULA VALVE BOX. INSTALL 2-WIRE DECODER COMPATIBL	V). FOR 1" DRCV'S INSTALL A RAIN ATOR. INSTALL THE DRCV ASSEMBLY	H SHT. L-03
SOLVENT WELD WITH SCH. 40 PVC FITTINGS, AS LA	TERAL LINES INSTALLED 12" BELOW	G SHT. L-03
ND LARGER SCH 40 PVC PURPLE PIPE MAINLINE OVER. ALL MAINLINE TO BE INSTALLED WITH TRACE	•	G SHT. L-03
TIMES THE DIAMETER OF PIPE OR WIRE BUNDLE (HARDSCAPE, ETC. (OR AS DIRECTED BY OWNER'S RIAN PAVING SHALL BE INSTALLED 24" BELOW FINIT ERIFY LOCATION IN FIELD.	AUTHORIZED REPRESENTATIVE) INSIDE	D SHT. L-03
OR BOTH MAINLINE AND LATERAL LINE SHALL BE M PRIMER SHALL BE LOW VOC "PURPLE PRIMER". DE CEMENT. LATERAL LINE SOLVENT CEMENT SHAL D AT LEAST ONE—HALF THE SIZE OF THE LARGES PER THE PIPE AND FITTING MANUFACTURER'S RECO	MAINLINE SOLVENT CEMENT SHALL BE L BE WELD-ON 711 PVC INDUSTRIAL ST PIPE BEING JOINED. ALL SOLVENT	
. CONDUIT FOR 2-WIRE SYSTEM WITH ELECTRICAL SWEEPS.	PROVIDE PULL BOXES PER PLAN.	
R LOW VOLTAGE CONTROL WIRE. OVED) WATER-PROOF WIRE CONNECTORS FOR USE	ON ALL WIRE SPLICES AND	A
		SHT. L-03
ERIES, PLASTIC TYPE WITH OVERLAPPING LIDS. VA ALL BE PURPLE LIDS. ALL BOXES SHALL BE SECU IP.		J SHT. L-03
	ACCEPTED	
/E IDENTIFICATION KEY	BY:	DATE:
GNATION	BY: RENE GUERRERO, P.E., RCE NO. 66263, CITY ENGINEER	DATE:
E STATION	CITY OF POMON	A
E SIZE	PUBLIC WORKS DEPARTMENT/ENGINEE	RING DIVISION
(IF APPLICABLE)	LINCOLN PARK IMPROY	
	IRRIGATION LEGE	IND
	DESIGNED:	SHT. LI-03

SCALE

AS SHOWN

DATE INITIAL

REVISIONS

DRAWN:

CHECKED:

REVIEWED:


ТМ

BS

Plan Number 428-81055

OF

17 SH

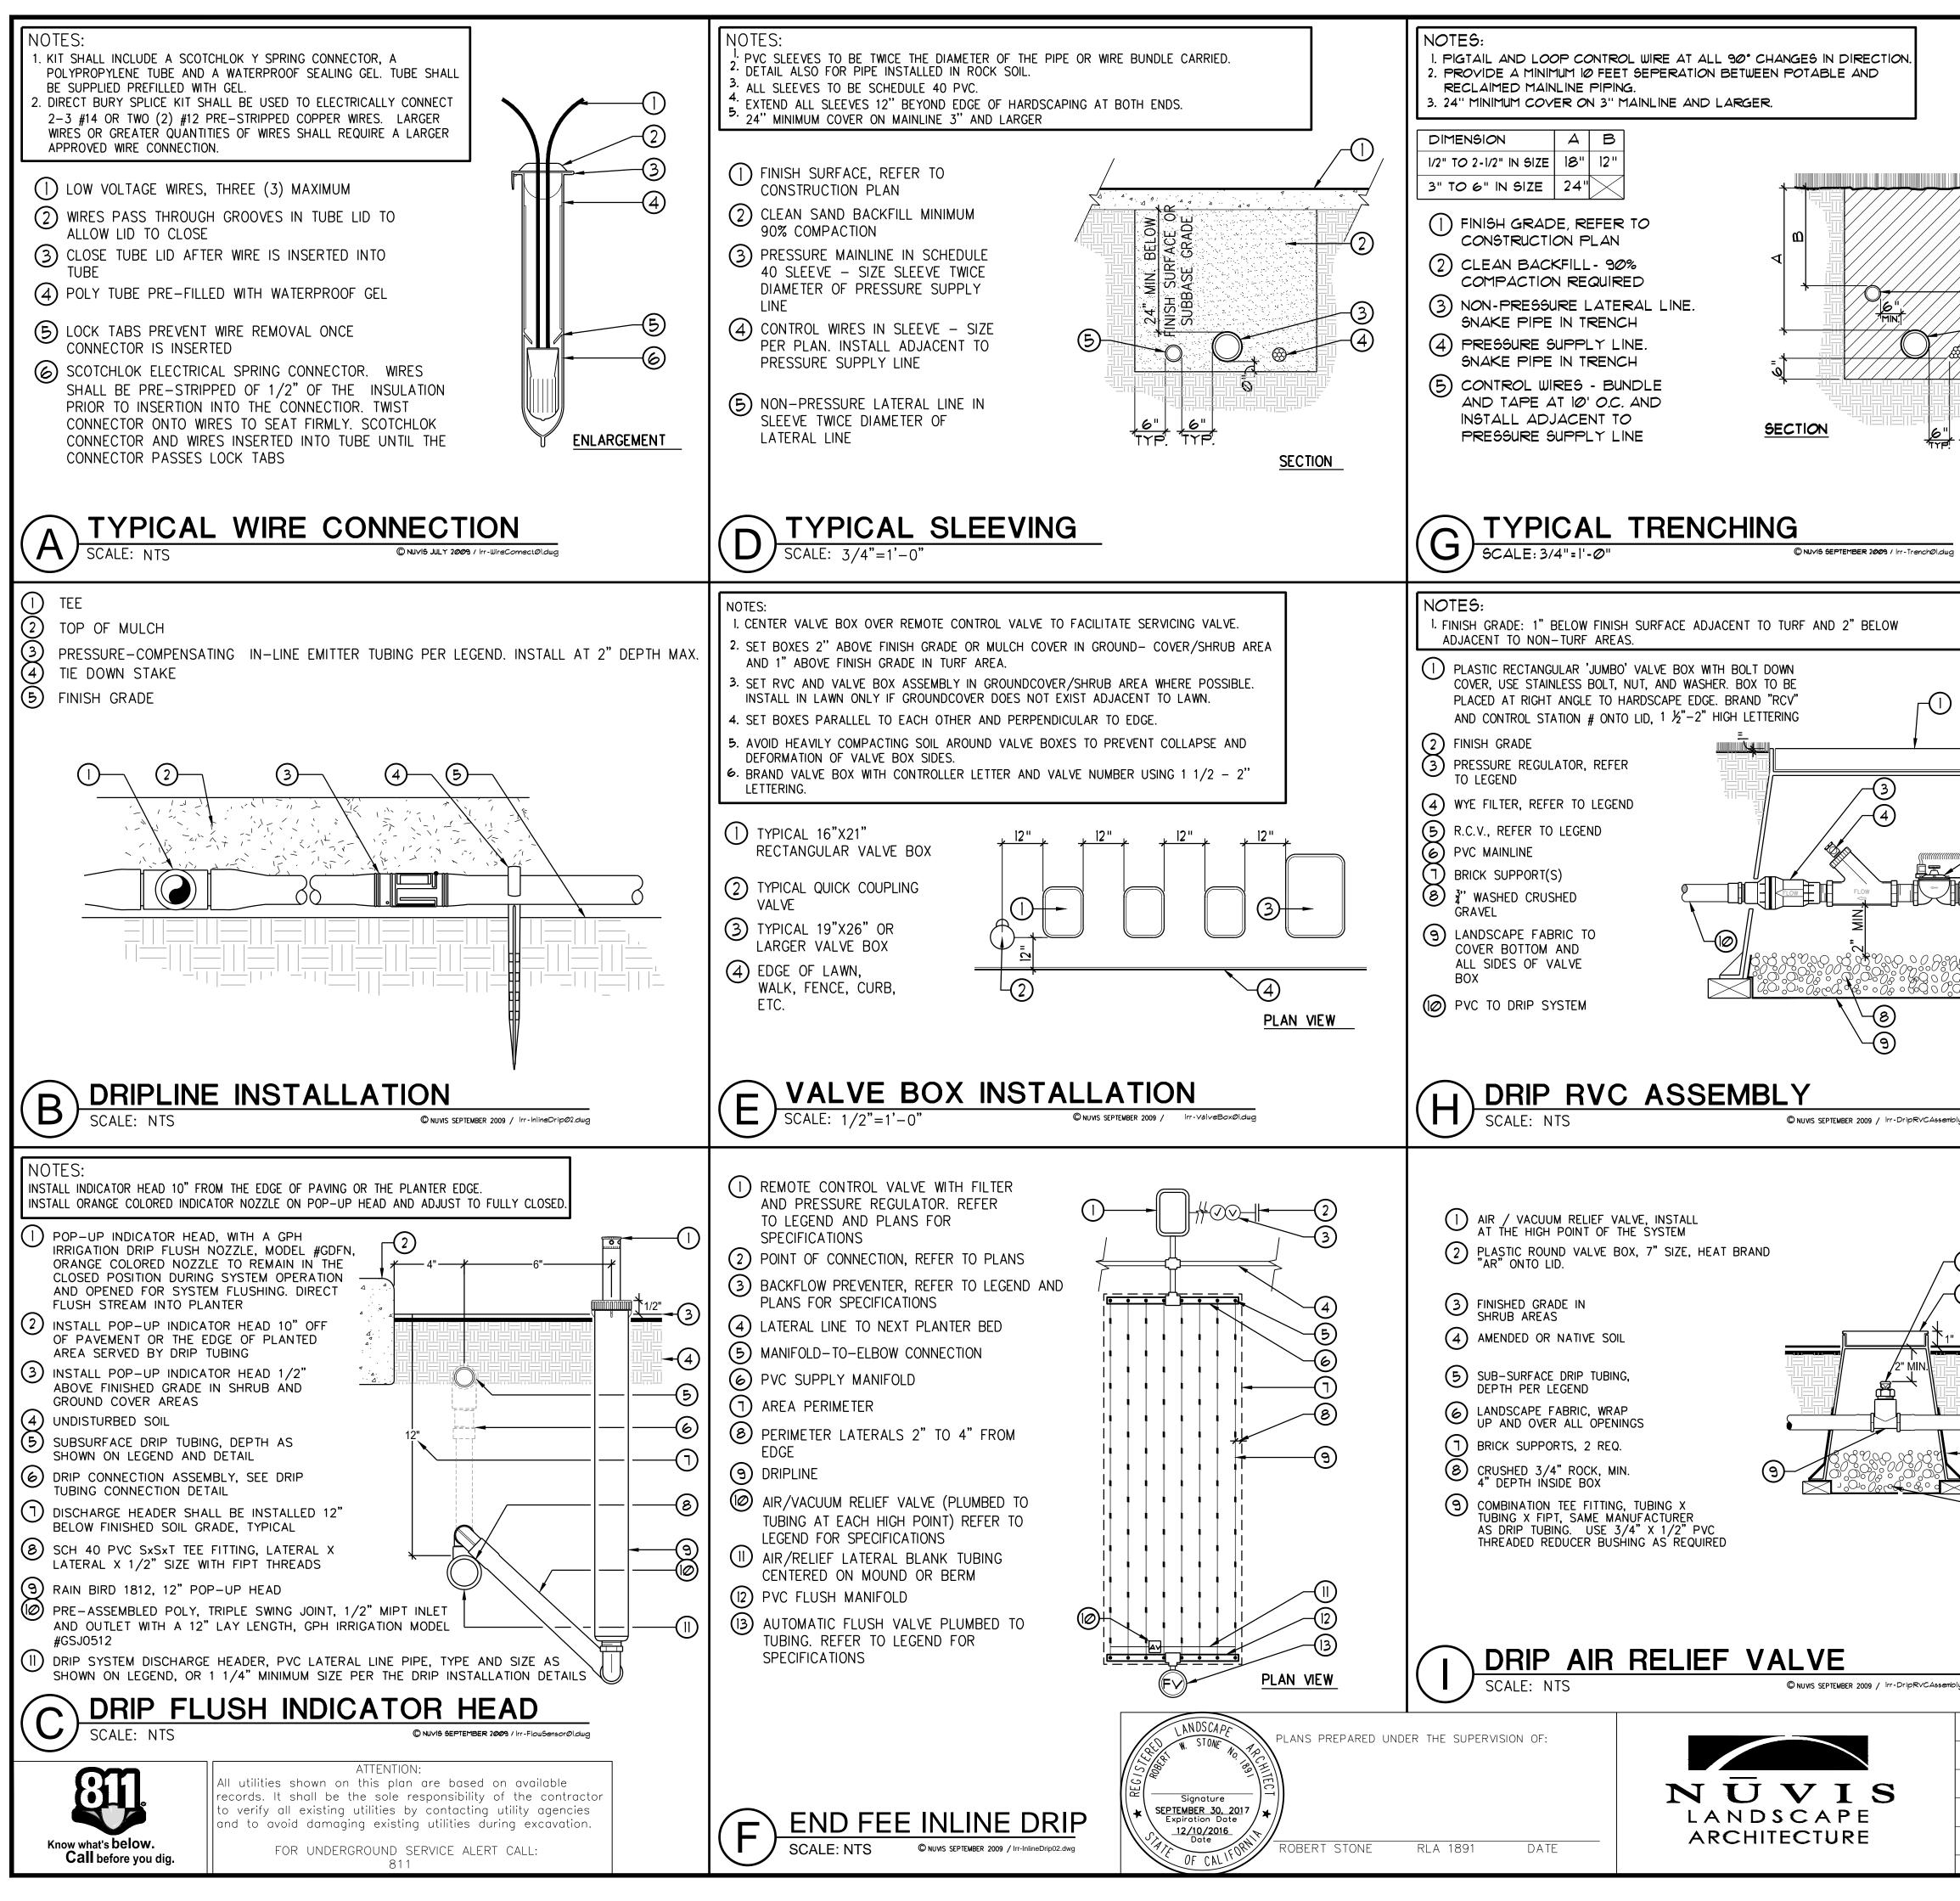

Independent						
-() -(2) "-(3) (4) (-) (-) (-) (-) (-) (-) (-) (-) (-) (-			RECOMMEND BY: RENE_GUE PUBLIC	DRKS DIRECTOR PED RRERO, P.E., RCE NO. 66263, P CITY OF WORKS DEPARTMEN OLN PARK	city engineer POMONA nt/engineering	DIVISION
				RRIGATION		
	REVISIONS	DATE INITIAL	SCALE AS SHOWN	DESIGNED: DRAWN: CHECKED: REVIEWED:	LK LK TM BS	SHT. LI-04 OF 17 SHTS

EXISTING PLANT LEGEND COMMON NAME

BOTANICAL NAME

1	ABELIA GRANDIFLORA	GLOSSY ABELIA
2	CAMELLIA SPP.	CAMELLIA
3	CINNAMOMUM CAMPHORA	CAMPHOR TREE
4	CUPANIOPSIS ANACARDIOIDES	CARROTWOOD
5	FEIJOA SELLOWIANA	PINEAPPLE GUAVA
6	FRAXINUS SPP.	ASH
7	JUNIPERUS SPP.	JUNIPER
8	LAGERSTROEMIA SPP.	CRAPE MYRTLE
9	PITTOSPORUM TOBIRA	MOCK ORANGE
10	PITTOSPORUM TOBIRA 'VARIEGATA'	MOCK ORANGE
(1)	PLATANUS RACEMOSA	CALIFORNIA SYCAMORE
(12)	PYRUS SPP.	EVERGREEN PEAR
(13)	QUERCUS AGRIFOLIA	COAST LIVE OAK
(14)	QUERCUS SUBER	CORK OAK
(15)	RHAPHIOLEPIS SPP.	INDIAN HAWTHORN
(16)	VACCINIUM SPP.	BLUEBERRIES
17	WASHINGTONIA SPP.	FAN PALM
(18)	LAURUS NOBILIS	SWEET BAY

CONSTRUCTION LEGEND


- 5' WIDE DECOMPOSED GRANITE PATH. REFER TO SECTIONS Α HEREON.
- EXISTING TREES & SHRUBS SHALL REMAIN & BE PROTECTED. #'S DENOTE PLANT MATERIAL PER PLANT LEGEND HEREON. MEDIAN WITH PAINTED CROSS WALK, RUNNING FROM PARK
- TO RESIDENTIAL. SIDE OF STREET. DENOTES PROPOSED BULB-OUT.
- EXISTING PLANTER WALL SHALL REMAIN, BE PROTECTED & REPAIRED.
- EXISTING TOT LOT AND PLAY EQUIPMENT SHALL REMAIN & BE PROTECTED.
- EXISTING RESTROOM BUILDING SHALL REMAIN & BE PROTECTED.
- EXISTING SHADE STRUCTURE SHALL REMAIN & BE PROTECTED.
- EXISTING PLAZA SHALL BE REFURBISHED:
- REGRADING FOR ADA ACCESSIBILITY
- EXISTING CONCRETE MOSAIC PAVING TO BE REMOVED AND REPLACED WITH STABILIZED D.G.
- MOSIAC BAND TO BE RESET AT BASE OF TREE PLANTER SHALL BE SET IN STABILIZED DECOMPOSED GRANITE (D.G.)
- EXISTING BBQ'S, TRASH RECEPTACLES, & THREE (3) EXISTING PICNIC TABLES SHALL REMAIN & BE PROTECTED. ONE (1) NEW ADA PICNIC TABLE SHALL BE INCLUDED IN PLAZA.
- NEW TURF AREA J
- K SUCCULENT PLANTING AREA


RECYCLED BRICK PAVING L

SITE LAYOUT PLAN LINCOLN PARK CITY OF POMONA, CA



ATTENTION: All utilities shown on this plan are based on available records. It shall be the sole responsibility of the contractor to verify all existing utilities by contacting utility agencies and to avoid damaging existing utilities during excavation. FOR UNDERGROUND SERVICE ALERT CALL: 811

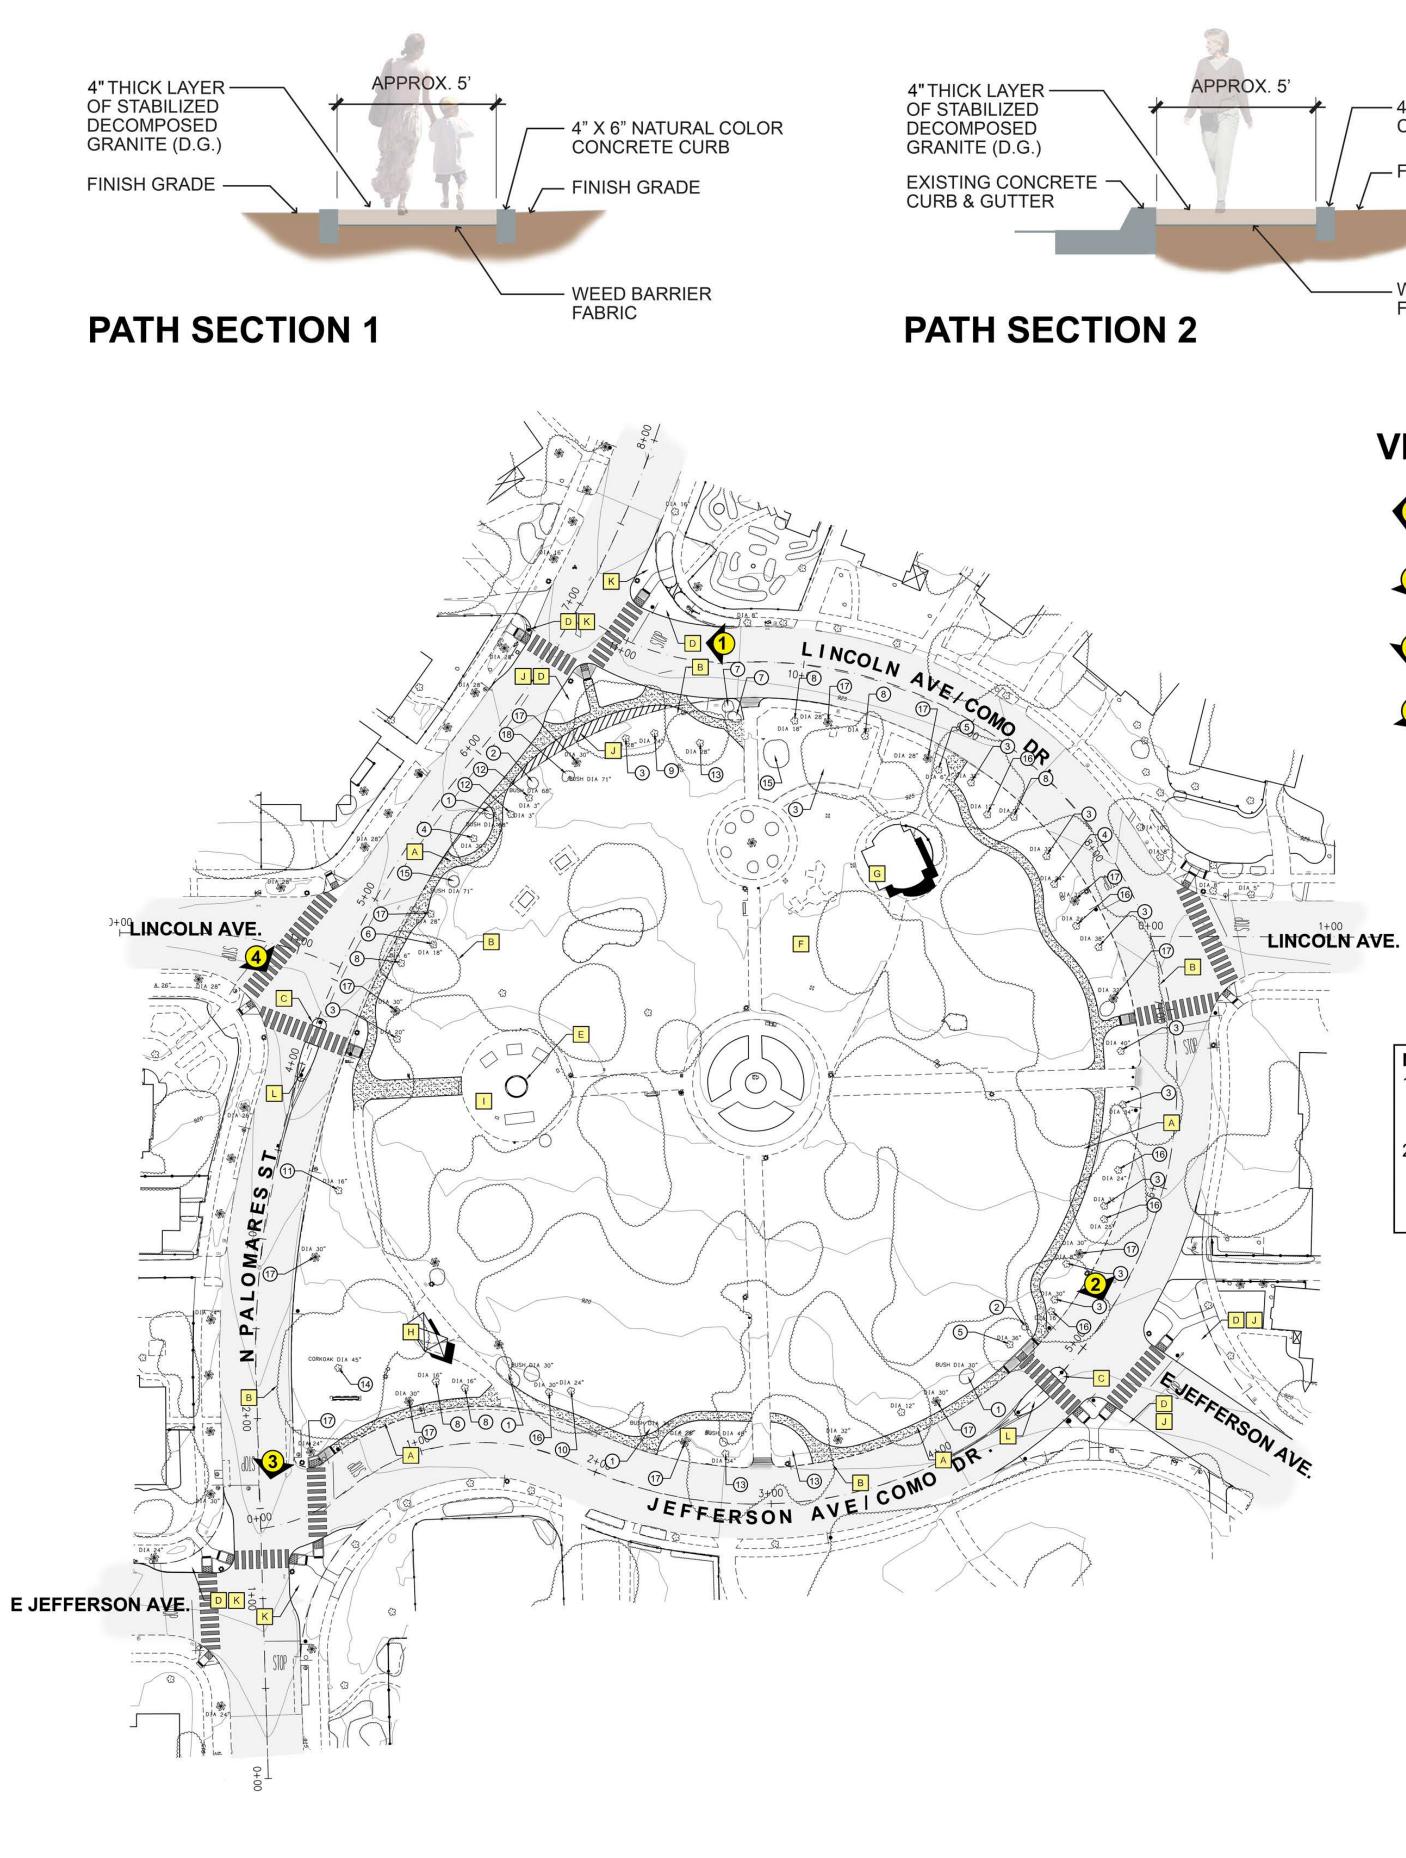

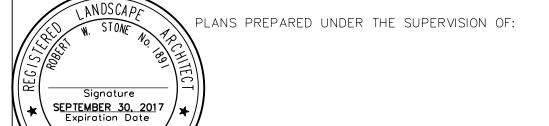

01/23/2017 Dote



ROBERT STONE

RLA 1891

DATE





N. PALOMARES ST. & LINCOLN AVE.

NOTE:

- 1. VIEWS CORRESPOND TO STREET VIEW PERSPECTIVE DESIGN SIMULATIONS.
- 2. PROPOSED BULB-OUT IRRIGATION FOR NEW BULB-OUT PLANTING AREAS SHALL BE TIED-INTO HOMEOWNER IRRIGATION SYSTEM.



REVISIONS

NOTE

1. REFER TO SHEET LP-03 FOR COMPLETE PLANT LIST NOTES AND DETAILS.

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ACCEPTED	
BY: PUBLIC WORKS DIRECTOR	DATE:
RECOMMENDED	
BY:	DATE:
CITY OF PON	
PUBLIC WORKS DEPARTMENT/EN	IGINEERING DIVISIO
LINCOLN PARK IMF	PROVEMEN
LANDSCA	⊃E

DESIGNED:

DRAWN:

CHECKED:

REVIEWED:

SCALE

AS SHOWN

DATE INITIAL

ERING DIVISION VEMENT SITE PLAN SHT. LP-01 OF 17 SH Plan Number 428-81055