verizon

GREVILLA

MTX-45 / BSC-17 MCE

2377 NORTH GAREY AVENUE POMONA, CALIFORNIA 91767

OVERALL HEIGHT 65-2"

PROJECT TEAM

SITE ACQUISITION /PLANNING:

SPECTRUM SERVICES, INC. 4405 E. AIRPORT DRIVE, SUITE 100 ONTARIO, CALIFORNIA 91761 PHONE: (909) 456-8401 FAX: (909) 456-8408

CIVIL ENGINEER:

SPECTRUM SERVICES, INC. 4405 E. AIRPORT DRIVE, SUITE 100 ONTARIO, CALIFORNIA 91761 CONTACT: GARRETT HAWTHORNE PHONE: (909) 456-8401 FAX: (909) 456-8408

ELECTRICAL ENGINEER:

DGS CONSULTING ENGINEERING SERVICES LLC 9811 W. CHARLESTON BOULEVARD, SUITE 2539 LAS VEGAS, NEVADA 89117 CONTACT: DEREK G. STEFUREAC PHONE: (702) 885-1552

DIAMONDBACK LAND SURVEYING 6140 BRENT THURMAN WAY, SUITE 230 LAS VEGAS, NEVADA 89148 CONTACT: TRENT J. KEENAN PHONE: (702) 823-3257

VERIZON WIRELESS SIGNATURE BLOCK

DISCIPLINE:	SIGNATURE:	DATE:
RE VENDOR:		
A&E VENDOR:		
A&E COORDINATOR:		
UTILITY VENDOR:		
RF:		
RE:		
CE:		
EE:		
TRANSPORT:		

PROJECT DESCRIPTION

THIS PROJECT IS A VERIZON WIRELESS UNMANNED TELECOMMUNICATION WIRELESS FACILITY. IT WILL CONSIST OF THE FOLLOWING:

- INSTALLATION OF A ~376 SQ. FT. VERIZON WIRELESS TELECOMMUNICATIONS
- FACILITY
 INSTALLATION OF (12) VERIZON WIRELESS PANEL ANTENNAS AT A 60'
- CENTERLINE MOUNTED ON A NEW 65'-2" ANTENNA STRUCTURE INSTALLATION OF (2) VERIZON WRELESS PARABOLIC ANTENNAS
- INSTALLATION OF (12) VERIZON WRELESS REMOTE RADIO UNITS (RRUS) WITH EXPANSION MODULES
- INSTALLATION OF (2) VERIZON WRELESS TOWER MOUNTED JUNCTION BOXES INSTALLATION OF (2) VERIZON WRELESS MACRO CELL EQUIPMENT CABINETS ON A CONCRETE PAO
- INSTALLATION OF (2) VERIZON WIRELESS GPS ANTENNAS INSTALLATION OF A VERIZON WRELESS 8' BLOCK WALL WITH A DECORATIVE CAP AND ANTI-GRAFFITI COATING
- AND ANTI-GRAFFIT COATING
 INSTALLATION OF A VERIZON WRELESS 4' WIDE SOLID METAL GATE
 INSTALLATION OF A VERIZON WRELESS 15KW DC GENERATOR WITH A 54
 GALLON DIESEL TANK ON A CONCRETE PAD
 HYBRIFLEX CABLE RUNS FROM RADIOS TO ANTENNAS
 NEW FIBER CONDUIT RUN TO CABINETS
 NEW 200A DEDICATED ELECTRICAL SERVICE TO METER

VICINITY MAP SITE

LOCATION NORT

DRIVING DIRECTIONS

Cameron Ave

POMONA, CALIFORNIA 9176

FROM 15505 SAND CANYON AVENUE, IRVINE, CALIFORNIA 92618: HEAD FROM 15505 SAND CANYON AVENUE, IRVINE, CALIFORNIA 92618: HEAD SOUTHEAST TOWARD SAND CANYON SIDE PATH/SAND CANYON TRAIL, 322 FT; TURN LEFT ONTO SAND CANYON AVENUE, 1.0 M; USE THE LEFT 2 LANES TO TURN LEFT TO MERGE ONTO I-5 NORTH, 0.3 M; MERGE ONTO I-5 NORTH, 9.9 M; USE THE RIGHT 2 LANES TO TAKE EXIT 107A FOR CA-57 NORTH TOWARD POMONA, 0.5 M; CONTINUE ONTO CA-57 NORTH, 17.5 M; KEEP RIGHT AT THE FORK TO STAY ON CA-57 NORTH, 3.0 M; USE THE RIGHT 2 LANES TO TAKE EXIT 21 FOR I-10 EAST/I-10 WEST TOWARD SAN BERNARDINO/LOS ANOELES, 0.3 M; KEEP RIGHT AT THE FORK TO CONTINUE ON EXIT 22B, FOLLOW SIGNS FOR I-10 EAST/SAN BERNARDINO FREEWAY AND MERGE ONTO I-10 EAST/SAN BERNARDINO FREEWAY, 3.3 MI; TAKE EXIT 45B FOR GAREY AVENUE/ORANGE GROVE AVENUE, 0.2 M; TURN LEFT ONTO NORTH GARRY AVENUE, 1.3 MI; MAKE A U-TURN, 0.1 MI; THE SITE WILL BE ON THE RIGHT.

PROJECT SUMMARY

APPLICANT/LESSEE

verizon/

VERIZON WIRELESS 15505 SAND CANYON AVENUE BUILDING D, 1ST FLOOR IRVINE CALIFORNIA 92618 OFFICE: (949) 286-7000

ASSESSOR'S PARCEL NUMBER

APN: 8371-016-017

PROPERTY OWNER:

KAI HUNG WONG AND SHUK FONG LAU OWNER: 1009 SOUTH HOLLENBECK STREET WEST COVINA, CALIFORNIA 91791 ADDRESS: VINCENT LIN

TELEPHONE: (626) 272-2202 PROPERTY INFORMATION:

SITE NAME: GREVILLA
SITE ADDRESS: 2377 NORTH GAREY AVENUE
POMONA, CALIFORNIA 91767

CONSTRUCTION INFORMATION

JURISDICTION: CITY OF POMONA

AREA OF CONSTRUCTION: 16'-4" X 23' (~376 SQ FT)

OCCUPANCY TYPE: TYPE OF CONSTRUCTION: V-R

CURRENT ZONING: CORRIDORS SPECIFIC PLAN (CSP)

FACILITY IS UNMANNED AND NOT FOR HUMAN ADA COMPLIANCE: HABITATION. MACHINERY SPACES ARE EXEMPT FROM ACCESSIBILITY REQUIREMENTS PER THE

CBC SECTION 11B-203.5.

GENERAL CONTRACTOR NOTES

DO NOT SCALE DRAWINGS

CONTRACTOR SHALL VERIFY ALL PLANS AND EXISTING DIMENSIONS AND CONDITIONS ON THE JOB SITE AND SHALL IMMEDIATELY NOTIFY THE ARCHITECT IN WRITING OF ANY DISCREPANCIES BEFORE PROCEEDING WITH THE WORK OR BE RESPONSIBLE FOR THE SAME.

CODE COMPLIANCE

- 2016 CALIFORNIA ENERGY CODE
- 2016 CALIFORNIA BUILDING CODE
- 2016 CALIFORNIA FLECTRICAL CODE
- 2016 CALIFORNIA FIRE CODE 2016 CALIFORNIA GREEN BUILDING
- 2016 CALIFORNIA MECHANICAL CODE 2016 CALIFORNIA PLUMBING CODE SHELTER IS STATE OF CALIFORNIA
- FOR LOCAL INSPECTION.

T1 TITLE SHEET A1 SITE PLAN SITE DETAIL, ANTENNA & CABLE SCHEDULE AND ANTENNA $\sqrt{6}$ A2 6 A2.1 SITE DETAIL WITH DIMENSIONS 6 Α3 NORTH & FAST FLEVATIONS 6 Α4 SOUTH & WEST ELEVATIONS 6 L1 LANDSCAPE PLAN L2 IRRIGATION PLAN LANDSCAPE DETAILS

DESCRIPTION

ZONING DRAWINGS



Call before you dig.

SHEET

TO OBTAIN LOCATION OF PARTICIPANTS UNDERGROUND FACILITIES BEFORE YOU DIG IN CALIFORNIA (SOUTH), CALL DIG ALERT
TOLL FREE: 1-800-227-2600 OR
WWW.DIGALERT.ORG

CALIFORNIA STATUTE REQUIRES MIN OF 2 WORKING DAYS NOTICE BEFORE YOU EXCAVATE

SPECTRUM SPECTRUM SERVICES. 4405 E. AIRPORT DRIVE, SUITE ONTARIO, CALIFORNIA 91761 PHONE: (909) 456-8401

ISSUE STATUS

100% 70NING

PLANNING REVISION

PLANNING REVISION

PLANNING REVISION

PLANNING REVISION

07/07/1

2\10/21/15 3 09/26/1

4 10/24/16

12/14/16

6 02/14/17

FAX: (909) 456-8408 PROPRIETARY INFORMATION

THE INFORMATION CONTAINED IN THIS SET OF DRAWINGS IS PROPRIETARY & CONFIDENTIAL TO VERIZON WIRELESS. ANY USE OR VERIZON WIRELESS IS STRICTLY PROHIBITED

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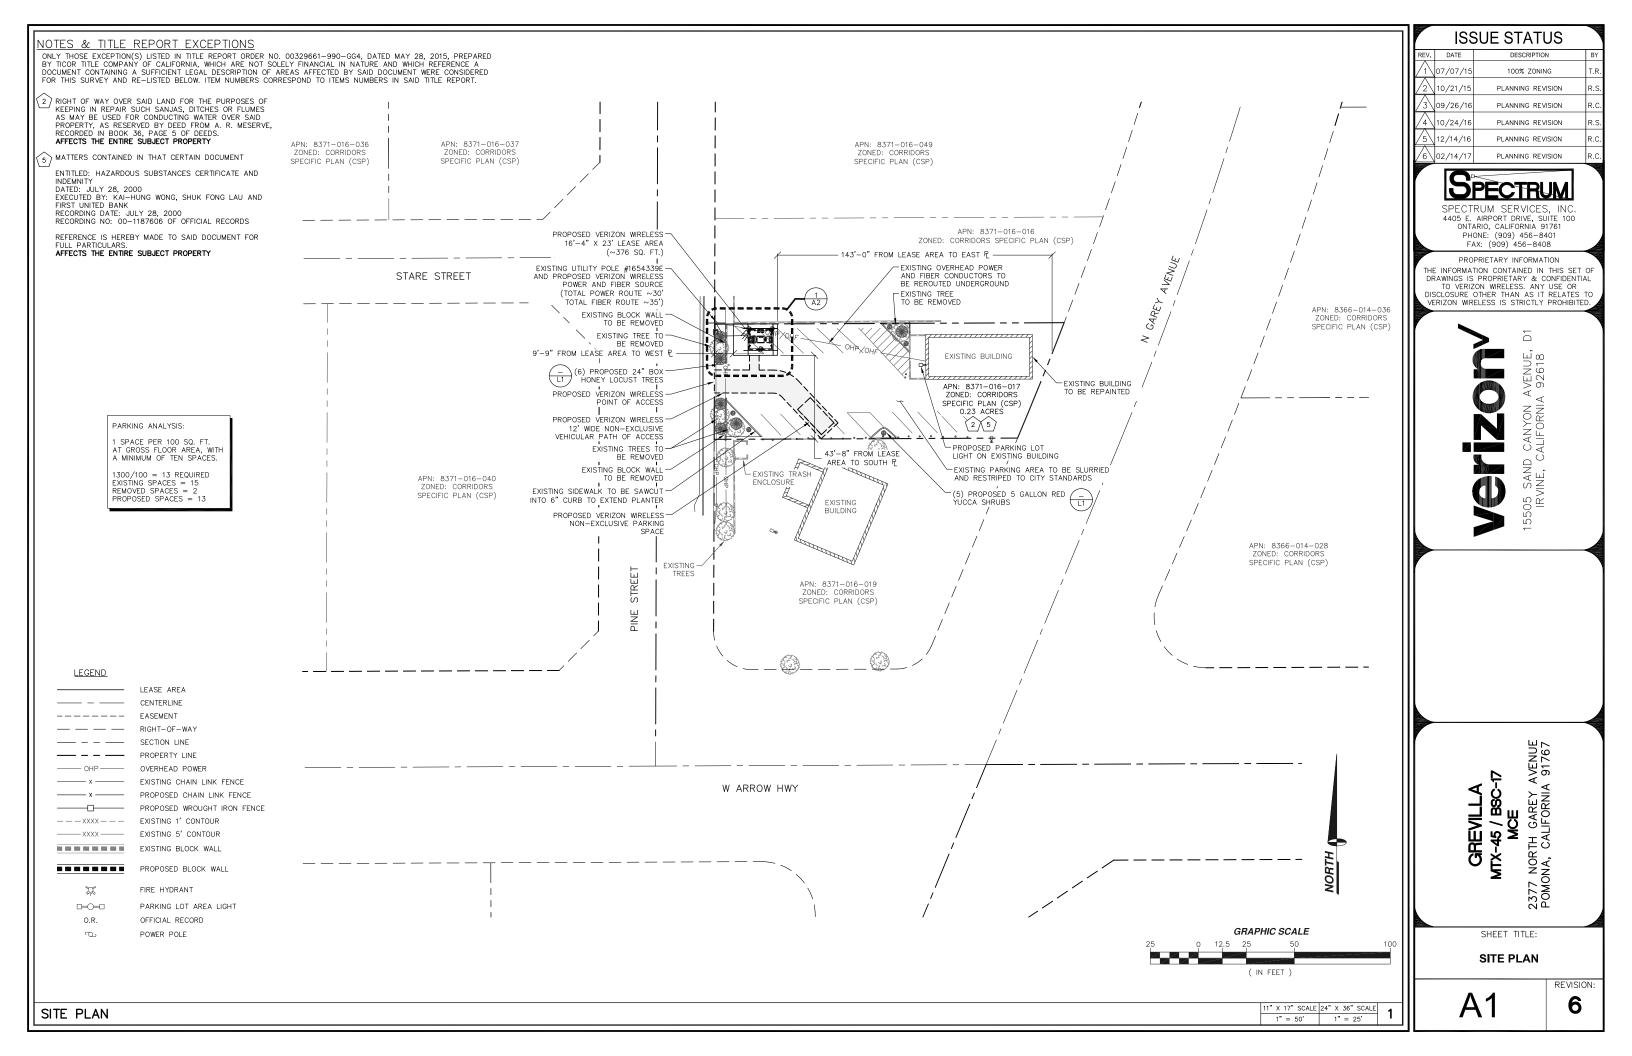
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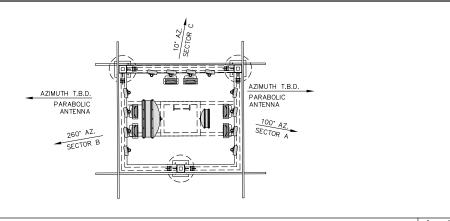
GREVILLA MTX-45 / BSC-17 MCE

2377 NORTH GAREY AVENUE POMONA, CALIFORNIA 91767

SHEET TITLE:

TITLE SHEET






SITE DETAIL

ANTENNA SECTOR	AZIMUTH	# OF ANTENNAS	# OF RRUS	CENTERLINE	CABLE LENGTH	CABLE TYPE	COLOR CODE	HYBRID JUMPER	JUMPER	COMMENTS
SECTOR A	100*	4	4	60'			RED/GREEN RED/RED	5'	15'	
SECTOR B	260°	4	4	60'	80'	80' (2) 1.7" HYBRIFLEX	BLUE/GREEN BLUE/RED	5'	15'	
SECTOR C	10°	4	4	60'			YELLOW/GREEN YELLOW/RED	5	15'	
PARABOLIC ANTENNA	T.B.D.	2		T.B.D.				•		
GPS	N/A	2				1/2" COAX	GRAY		-	

NOTE: CONTRACTOR TO FIELD VERIFY CABLE LENGTHS PRIOR TO ORDERING, FABRICATION, OR INSTALLATION OF CABLES.

11" X 17" SCALE 24" X 36" SCALE 3 ANTENNA AND CABLE SCHEDULE ANTENNA LAYOUT

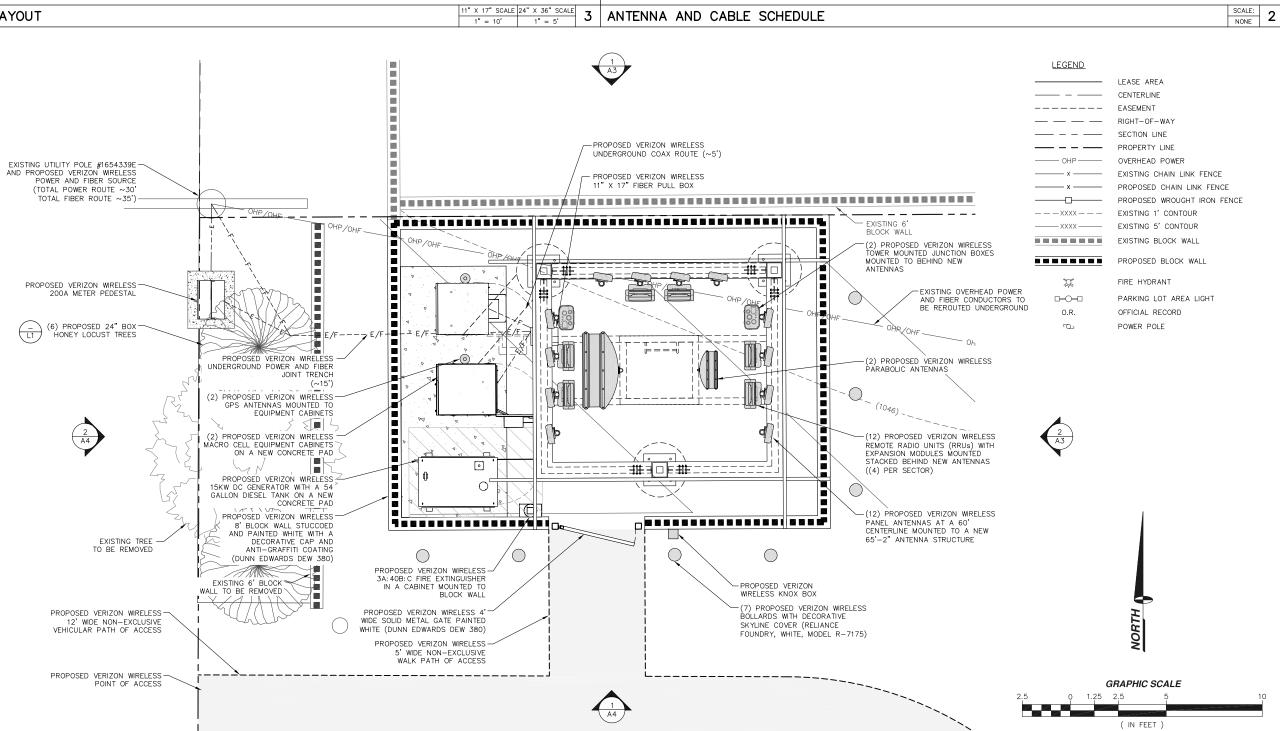

	ISSUE STATUS						
Ш	lſ	REV.	DATE	DESCRIPTION	BY		
		$\sqrt{1}$	07/07/15	100% ZONING	T.R.		
Ш	Iſ	\overline{A}	10 /01 /15	DI ANNINO DEVICIONI	р.с		

ı	REV.	DATE	DESCRIPTION	
l	$\sqrt{1}$	07/07/15	100% ZONING	T.R.
I	$\sqrt{2}$	10/21/15	PLANNING REVISION	R.S.
l	$\sqrt{3}$	09/26/16	PLANNING REVISION	R.C.
l	4	10/24/16	PLANNING REVISION	R.S.
١	5	12/14/16	PLANNING REVISION	R.C.
ı	6	02/14/17	PLANNING REVISION	R.C.

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SHEET TITLE: SITE DETAIL, ANTENNA & **CABLE SCHEDULE AND ANTENNA LAYOUT**


REVISION:

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A2

11" X 17" SCALE 24" X 36" SCALE

1" = 5' 1" = 2'-6"

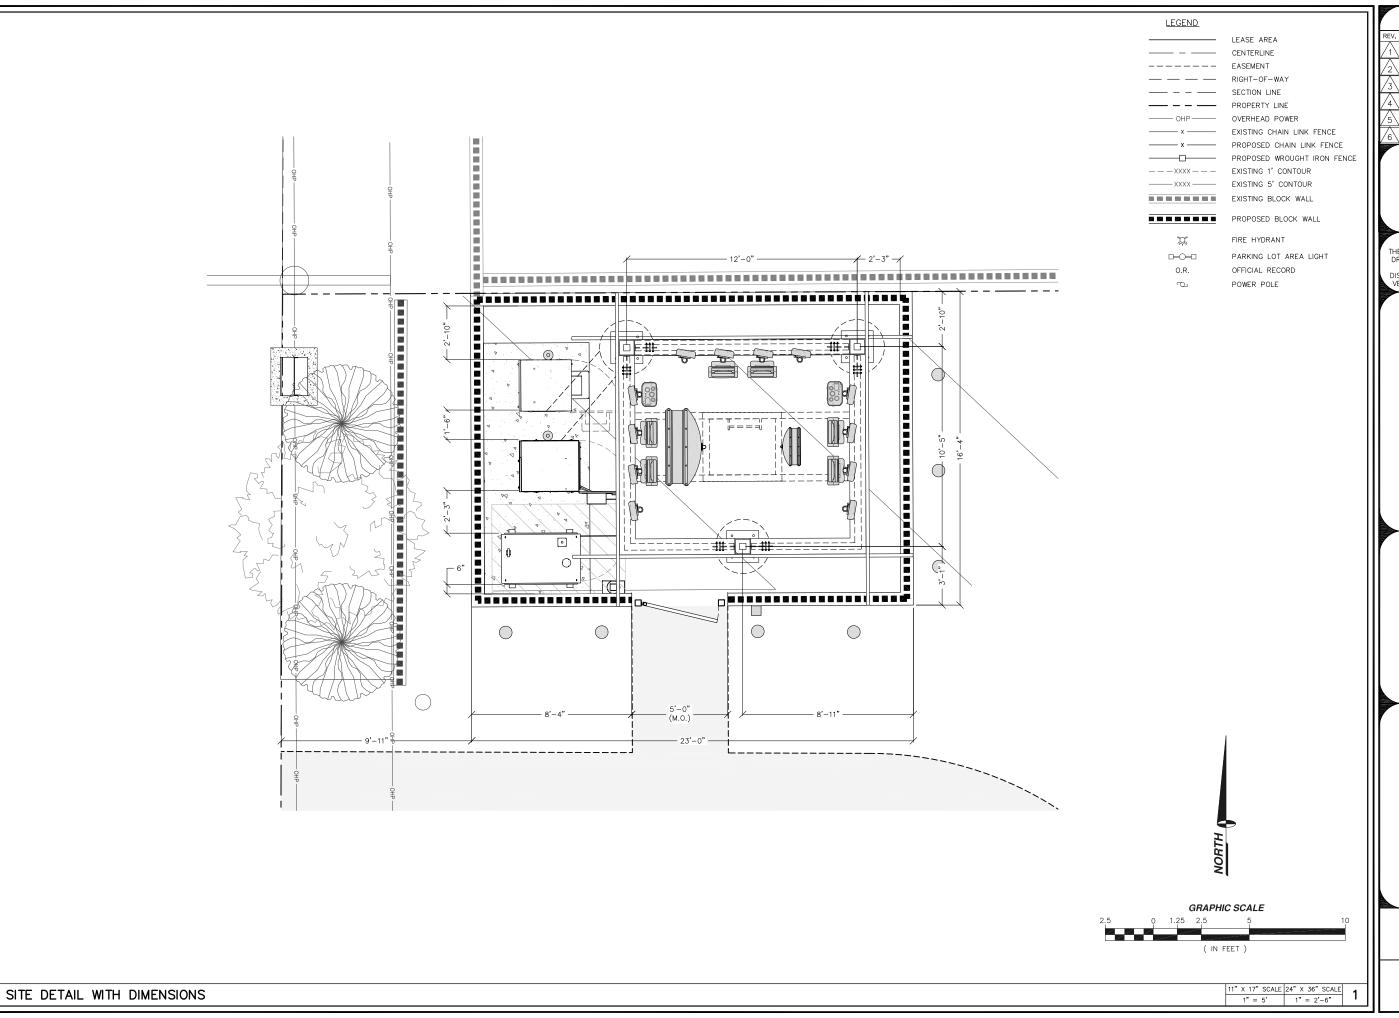

ISSUE STATUS

REV.	DATE	DESCRIPTION	BY
$\sqrt{1}$	07/07/15	100% ZONING	T.R.
$\sqrt{2}$	10/21/15	PLANNING REVISION	R.S.
$\sqrt{3}$	09/26/16	PLANNING REVISION	R.C.
4	10/24/16	PLANNING REVISION	R.S.
5	12/14/16	PLANNING REVISION	R.C.
6	02/14/17	PLANNING REVISION	R.C.

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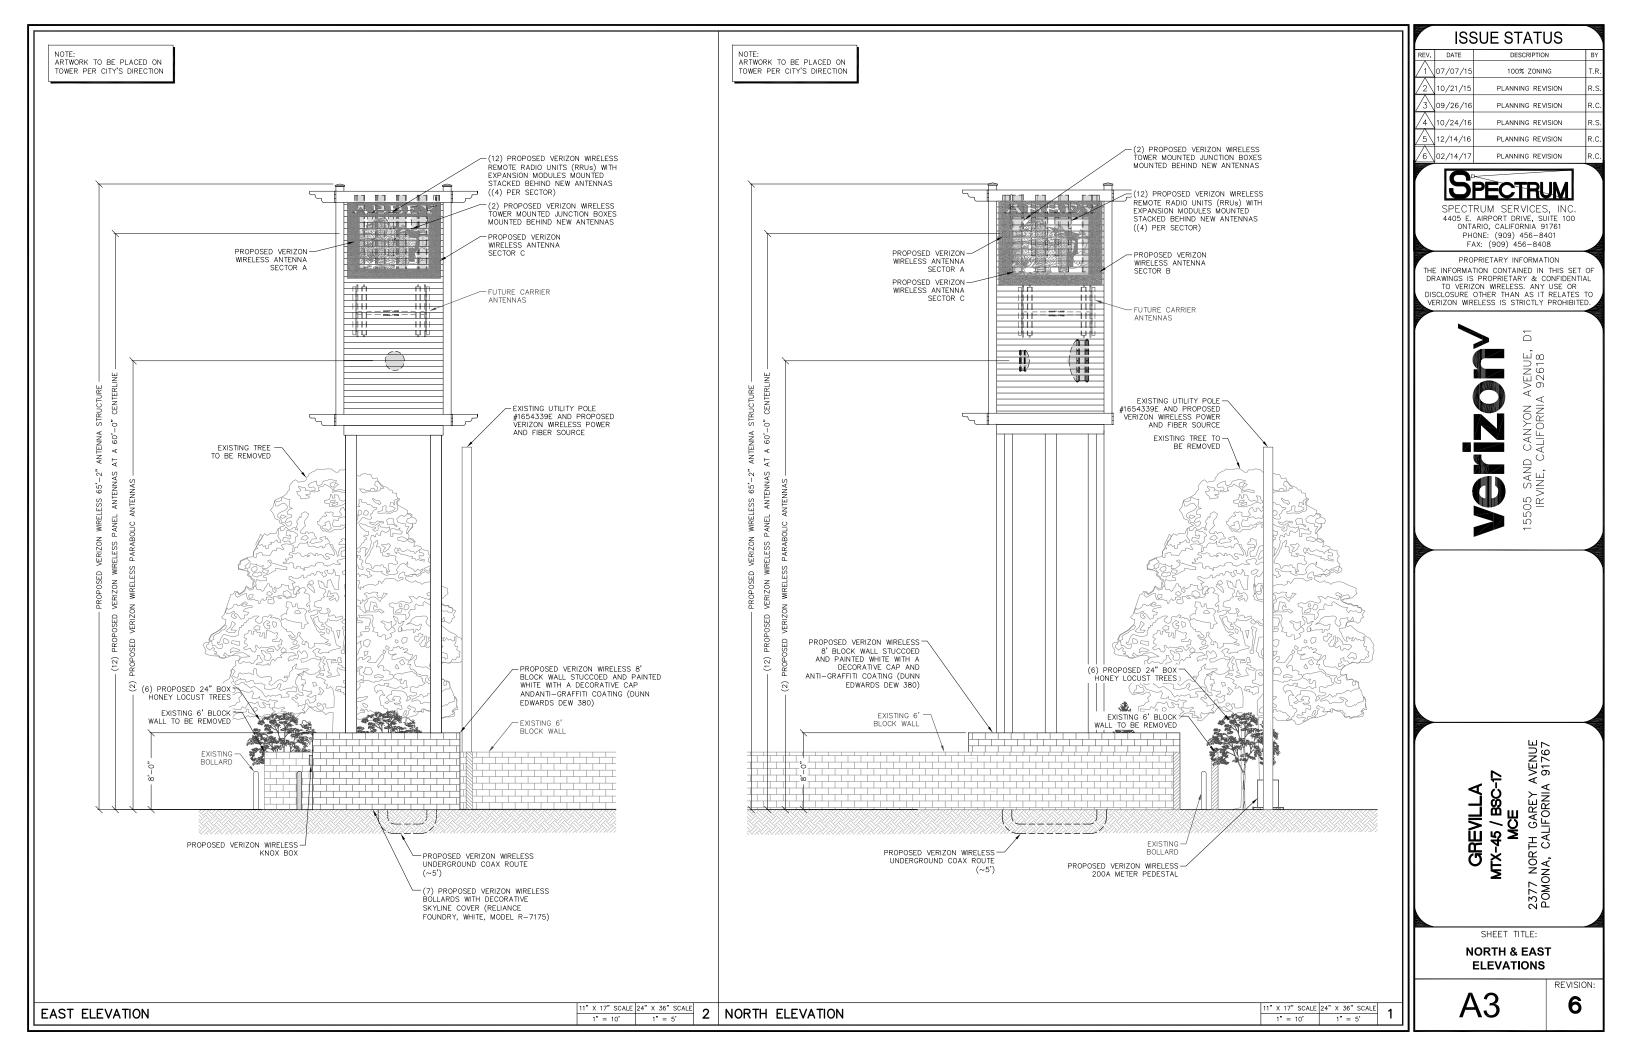
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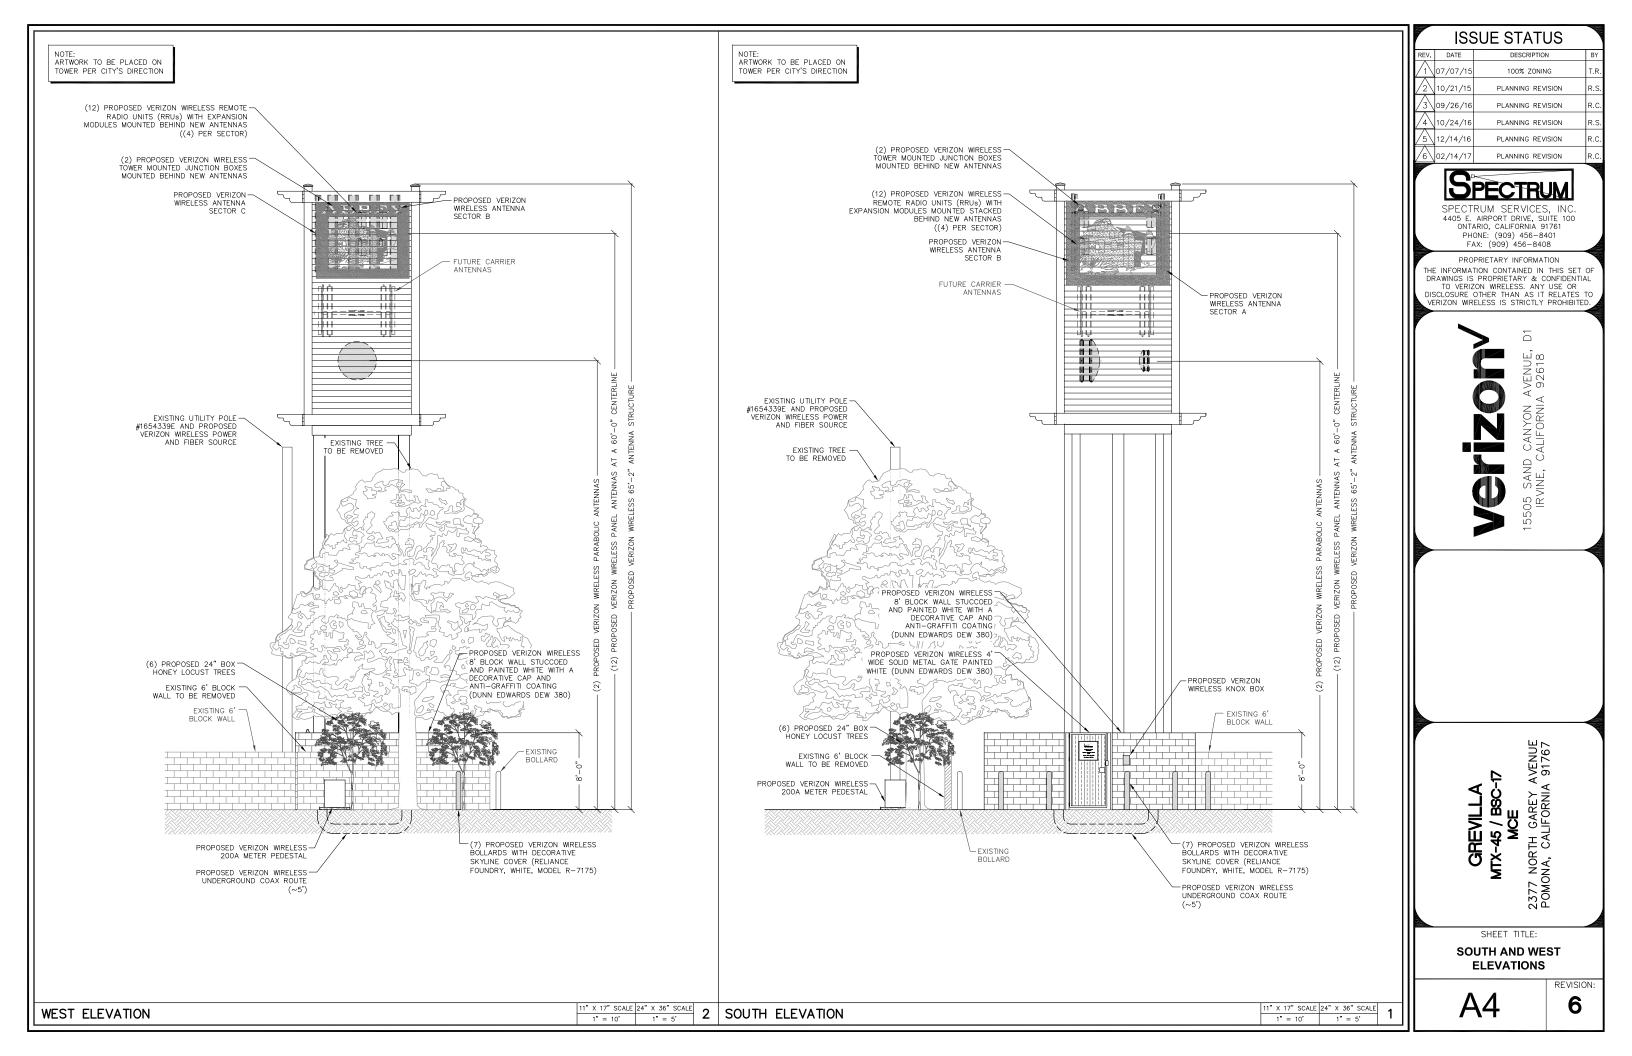
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SHEET TITLE:

SITE DETAIL WITH **DIMENSIONS**





PROJECT LANDSCAPE AREA: = 195 SQUARE FEET = $(ETo) (0.62)[(0.7 \times LA)+(0.3 \times SLA)]$ = $(47.5)(0.62)[(0.7 \times 195)+(0.3 \times 0)]$ MAXIMUM WATER BUDGET: = 4,020 (GALLONS/YEAR) = (ETo) $(0.62)[(PF \times LA/IE) + SLA]$ = $(47.5)(0.62)[(0.2 \times 150/0.85) + 0]$ ESTIMATED WATER USE TREES: = 1,040 (GALLONS/YEAR) = (ETo) $(0.62)[(PF \times LA/IE) + SLA]$ = $(47.5)(0.62)[(0.2 \times 45/0.85) + 0]$ ESTIMATED WATER USE SHRUBS: = 312 (GALLONS/YEAR)

,

= 2.668 (GALLONS/YEAR)

TOTAL LANDSCAPE AREA TOTAL SQ. FT. OF TREE FT. OF SHRUBS =

TOTAL ESTIMATED WATER USE:

PLANT MATERIAL LEGEND PLANT BOTANICAL COMMON PLANT PLANT SYMBOL QUANTITIES FACTOR NAME NAME SPACING SIZE (PF) GLEDITSIA TRIACANTHOS AS SHOWN 24" BOX LOCUST (LOW) HESPERALOE PARVIFLORA AS SHOWN YUCCA (LOW)


SOIL PREPARATION

1. BACKFILL MIX FOR USE OF PLANTING ALL SHRUBS/TREES

6 PARTS BY VOLUME ON SITE SOIL.
4 PARTS BY VOLUME ORGANIC AMENDMENT.
1 LB. 12-12-12 COMMERCIAL FERTILIZER PER CUBIC YARD.
1 LB. RON SULFATE PER CU. YD. OF MIX.
1E: THIS BACKFILL MIX IS FOR BIDDING PURPOSES ONLY. THE CONTRACTOR SHALL PROVIDE SOIL SAMPLES TO BE TESTED BY A SOIL AND PLANT LAB FOR ACTUAL BACKFILL AND SOIL AMENDMENT REQUIREMENTS.)

- 2. PLANT TABLE FOR ALL SHRUBS/TREES
 - 2-21 GRAM AGRIFORM FERTILIZER TABLETS PER 5 GALLON STOCK 8-21 GRAM AGRIFORM FERTILIZER TABLETS PER 24" BOX STOCK

SCALE: SCALE: 3 PLANTING NOTES AND PLANT MATERIAL LEGEND MAWA CALCULATIONS NONE

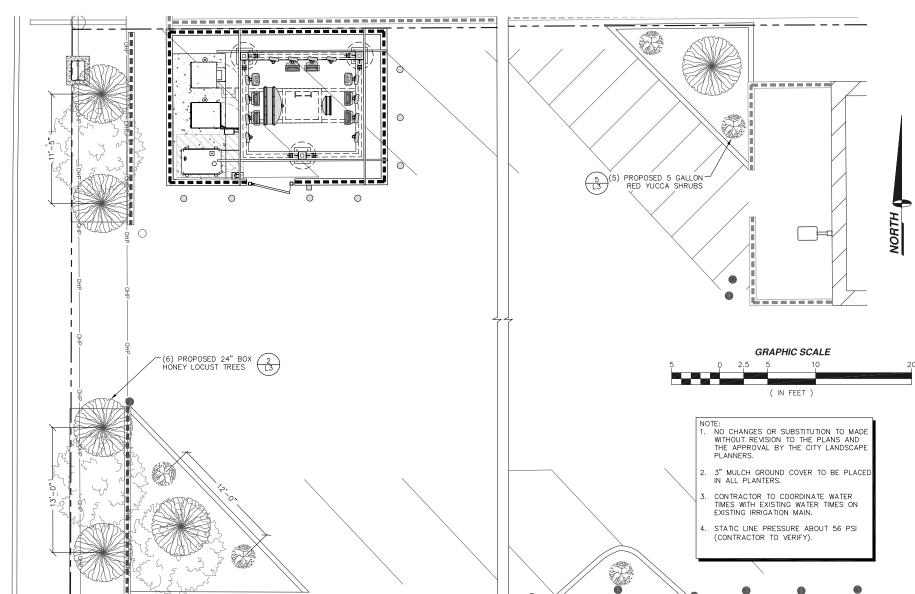

SCOPE OF WORK

THE WORK INCLUDED IN THESE SPECIFICATIONS SHALL CONSIST OF ALL LABOR, TOOLS,
MATERIALS, PERMITS, TAXES, AND ALL OTHER COSTS, FORESEEABLE AND UNFORESEEABLE AT
THE TIME OF CONTRACTING, NECESSARY AND APPROPRIATE FOR THE INSTALLATION OF THE LANDSCAPING AS HEREIN SPECIFIED ON THE ACCOMPANY DRAWINGS.

GENERAL CONDITIONS

- INTERPRETATION OF PLANS AND SPECIFICATIONS: THE LANDSCAPE ARCHITECT WILL INTERPRET THE MEANING OF ANY PART OF THE PLANS AND SPECIFICATIONS ABOUT WHICH ANY MISUNDERSTANDING MAY ARISE, AND THE DECISION WILL BE FINAL.
- <u>LICENSE REQUIREMENTS:</u> THE CONTRACTOR SHALL CARRY NECESSARY CALIFORNIA STATE CONTRACTORS LICENSE OR CERTIFICATE FOR TYPE OF WORK LISTED, SUCH AS C-27.
- 3. <u>INSURANCE COVERAGE:</u> THE CONTRACTOR SHALL CARRY ALL NECESSARY COMPENSATION AND LIABILITY INSURANCE TO COVER THE WORKMEN AND WORK TO FULLY PROTECT THE OWNER FROM ANY POSSIBLE SUIT OR LIEN.
- 4. KNOWLEDGE OF SITE: IT IS ASSUMED THAT THE CONTRACTORS HAVE VISITED THE SITE AND FAMILIARIZED THEMSELVES WITH SITE CONDITIONS, AND SHALL HAVE VERIFIED ALL DIMENSIONS AND OTHER FACTORS AFFECTING THE WORK
- 5. <u>INCREASED COSTS:</u> IF EXTRA WORK OR CHANGES WILL RESULT IN ANY INCREASED COSTS OVER THE CONTRACT FEE, THE OWNER SHALL SIGN THE CONTRACTOR'S WRITTEN REQUEST FOR SUCH ADDITIONAL FUNDS PRIOR TO ACTUALLY DOING THE WORK.
- LANDSCAPE DESIGN AND INSTALLATION TO INSURE PRACTICALITY AND FOR AESTHETIC REASONS, AT NO ADDITIONAL COSTS.
- GRADING: GRADE ALL AREAS BY FILLING AND/OR REMOVING SURPLUS SOIL AS NEEDED TO ENSURE PROPER GRADING AND DRAINAGE AS INDICATED ON THE PLANS. UNLESS OTHERWISE NOTED, FINISHED GRADES SHALL BE BELOW HARDSCAPE AS FOLLOWS: 2" IN GROUND COVER, 1" IN LAWN AREAS.

- 1. CONTAINER GROWN PLANTS TO BE PLANTED IN PLANT PITS TWO TIMES WIDER THAN PLANT CONTAINER AND A DEPTH OF THE HEIGHT OF ROOTBALL. PLANT CROWN TO BE SLIGHTLY HIGHER THAN ITS NATURAL GROWING HEIGHT AFTER SETTLEMENT. (SHRUBS
- 2. ALL PLANTS SHALL BE WATERED IMMEDIATELY, PRIOR TO BACKFILLING PLANTING PITS.
- 3. USE AGRIFORM 20-10-5, 21 GRAM TABLETS PER MAKER'S SPECIFICATIONS, WITH ALL SHRUBS AND TREES. 1 PER 1 GAL. 2 PER 5 GAL. 3 PER 15 GAL. AND 4 PER FOOT OF
- 4. PROVIDE A WATERING BASIN AROUND ALL 5 GALLON AND LARGER SIZE MATERIAL APPROX AS FOLLOWS:
- 5 GAL. 2" DEPTH X 1-1/2 TIMES CONTAINER
- 5. SCARIFY THE SIDES OF EACH ROOT BALL PRIOR TO PLANTING IF CIRCULAR ROOT GROWTH IS EVIDENT. IF CIRCULAR ROOTS EXIST, PLANTS WILL BE REJECTED

CLEAN UP

LEAN UP
UPON COMPLETION OF THE WORK, THE CONTRACTOR SHALL PROPERLY CLEAN AND
TIDY ALL WORK AND THE SURROUNDING AREAS USED BY THEM, AND REMOVE ANY OR
ALL EXCESS MATERIALS, DIRT, DEBRIS FROM THE SITE, OR DISPOSE OF SAME AS
DIRECTED BY OWNER, ARCHITECT OR LANDSCAPE ARCH.

MAINTENANCE

- MAINTENANCE PERIOD SHALL NOT BEGIN UNTIL ENTIRE INSTALLATION IS ACCEPTED BY THE OWNER FOLLOWING THE WALK—THRU.
- 2. MAINTENANCE PERIOD SHALL BE FOR THE FOLLOWING DURATION: 60 DAYS.
- 3. THE CONTRACTOR SHALL KEEP SITE WEED FREE, CLEAR OF DEBRIS, AND ADJUST IRRIGATION SYSTEM AS REQUIRED. LAWNS SHALL BE PROPERLY CUT AND ALL CUTINGS REMOVED FROM SITE, DEAD FOLIAGE REMOVED FROM PLANTS AND STAKING OF TREES SHALL BE ADJUSTED IF NECESSARY. IT IS THE OWNERS RESPONSIBILITY TO MAINTAIN PLANTING AFTER ONE YEAR.

LANDSCAPE NOTES

- GUARANTEE AND REPLACEMENTS

 1. CONTRACTOR SHALL GUARANTEE HEALTHY PLANT ESTABLISHMENT FOR A PERIOD OF 12 MONTHS AND SHALL NOT BE RESPONSIBLE FOR DAMAGE DUE TO EXTREME WIND OR EXCESSIVE RAIN RUN-OFF ON NEW PLANTED GROUND COVER AREAS. SUCH 'NATURAL DAMAGE' SHALL BE REPAIRED ON A TIME AND MATERIAL BASIS.
- ANY PLANT MATERIAL FAILING TO SURVIVE DUE TO CONTRACTOR'S IMPROPER INSTALLATION SHALL BE REPLACED BY CONTRACTOR AT NO ADDITIONAL COST TO OWNER.

SCALE:

11" X 17" SCALE 24" X 36" SCALE DETAILED LANDSCAPE PLAN 1" = 10'

ISSUE STATUS 07/07/ 100% ZONING 10/21/1 PLANNING REVISION 09/26/ 4 10/24/1 12/14/1 PLANNING REVISION

PLANNING REVISION

SPECTRUM SPECTRUM SERVICES. 4405 E. AIRPORT DRIVE, SUITE ONTARIO, CALIFORNIA 91761

6\02/14/17

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> \Box VENUE, 92618

2377 NORTH GAREY AVENUE POMONA, CALIFORNIA 91767 **BSC-17**

SHEET TITLE:

LANDSCAPE PLAN

1" = 5'


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	IRRIGATION L	EGEND	•					
SYMBOL	MANUFACTURER	DESCRIPTION	PATTERN	RADIUS	GРМ	PSI		
₩	HUNTER-MSBN-25Q	6" POP-UP BUBBLER	Н	1'	.25	30		
M	WATER METER							
	HUNTER MODEL IC-600-M, 6 STATION WITH SOLAR SYNC AND HUNTER RAIN-CLIK RAIN SENSOR							
	FEBCO MODEL 825Y RP BACKFLOW PREVENTER (OR EQUIVALENT)							
\bowtie	LINE SIZE BRASS BALL VALVE IN BOX BELOW GRADE NIBCO T-580							
•	HUNTER PGV REMOTE CONTROL VALVE IN PVC BOX BELOW GRADE, SIZE AS NOTED							
	PRESSURE MAINLINE, 2" PVC SCH 40, (SOLVENT WELD) BURY MIN. 18" BELOW GRADE							
	NON-PRESSURE LATERAL, F	PVC SCH 40, (SOLVENT WELD) BURY N	MIN. 12" BELOW	GRADE. SIZE	NOTED			

IRRIGATION LEGEND	SCALE:	1
I IRRIGATION LEGEND	NONE	4


- COMMON TRENCH WITH MAIN LINE WHERE POSSIBLE. PROVIDE 18" COVER.
- ALL PIPE UNDER PAVED AREAS TO HAVE SCH. 40 PVC SLEEVES INSTALLED PRIOR TO PAVING.

- 11. THE SYSTEM SHALL BE FULLY GUARANTEED FOR A PERIOD OF ONE YEAR. ANY DEFECTIVE MATERIAL OR POOR

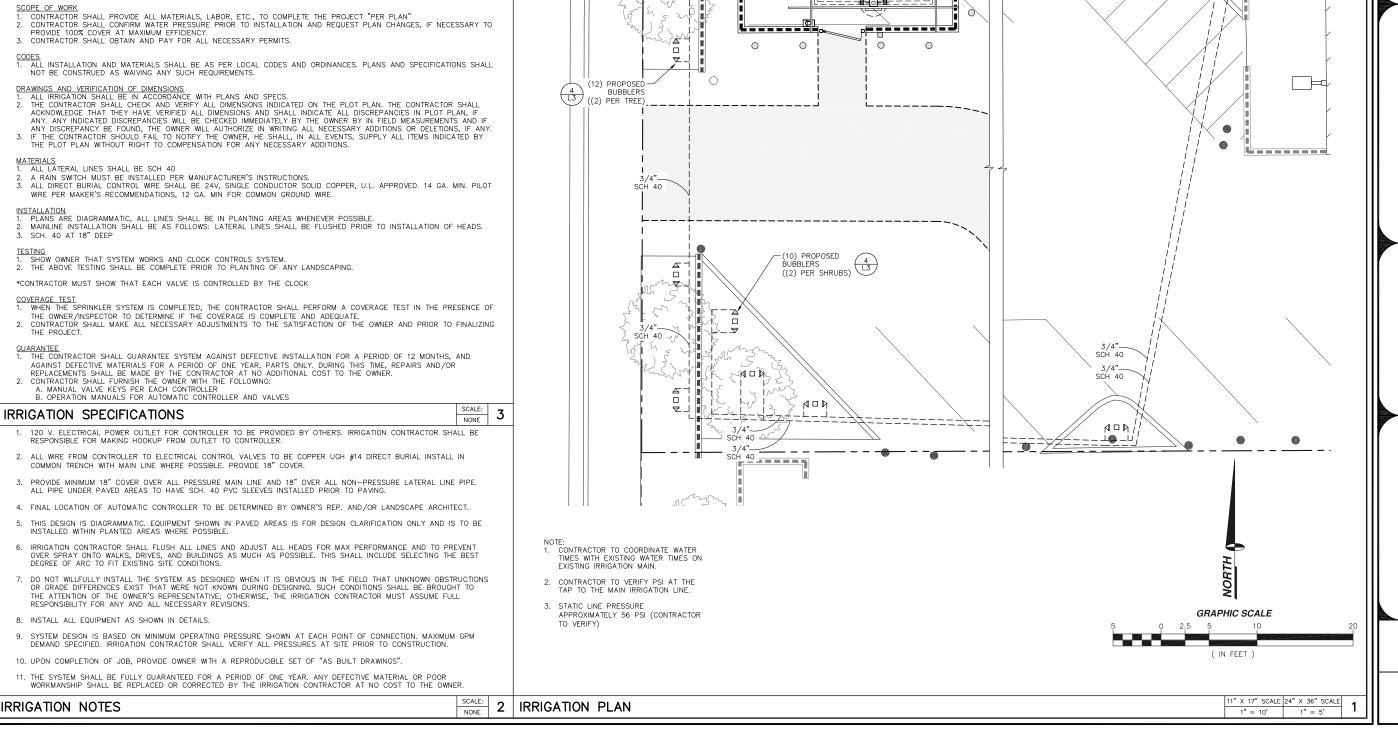

₫-

SCH 40

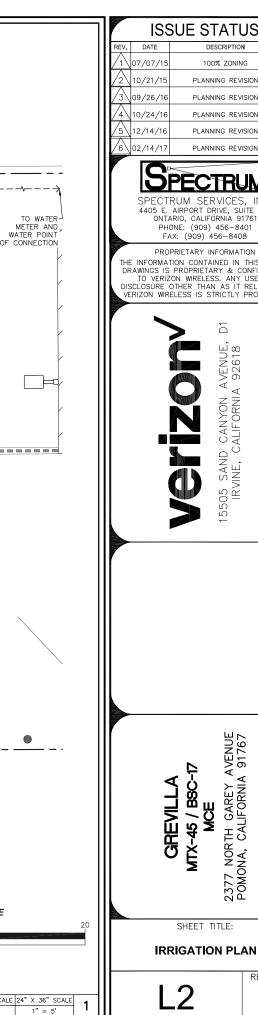

 $\left(\begin{array}{c} 9\\ \text{L3} \end{array}\right)$

○

PROPOSED BACKFLOW

PROPOSED REMOTE

PROPOSED REMOTE

PROPOSED SMART

8 CONTROLLER WITH RAIN SENSOR (TIME CLOCK)

4

<u>4</u> = <u>1</u>

 $\binom{6}{L3}$ PROPOSED BALL VALVE-

CONTROL VALVE #1 HUNTER PGV 1" (2.5 GPM.)

CONTROL VALVE #2 HUNTER PGV 1" (3.0 GPM.)

SCH 40

PREVENTER

ISSUE STATUS 100% ZONING PLANNING REVISION PLANNING REVISION

SPECTRUM SPECTRUM SERVICES.

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