

PROJECT DATA 35,190 SF (.81 AC)

LOT SQ. FT.: 8347-027-025 ZONING: PRIVATE OPEN SPACE LOW DENSITY MULTIPLE FAMILY CONSTRUCTION TYPE: TYPE - V - A 163 SF AT FIRST FLOOR PATIO DENSITY: 8-15 DU PER AC UNIT 3 164 SF AT FIRST FLOOR PATIO 15 DU x .81 AC = 12 UNITS (12 PROVIDED) • UNIT 4 I 63 SF AT FIRST FLOOR PATIO NUMBER OF STORIES: 2 STORIES (35'-0" MAX. HT.)

BUILDING DESCRIPTION • (12) SINGLE FAMILY UNITS COMPRISED OF (8) 3-BED/2.5-BATH 1,800 SF • UNIT 8 2-STORY UNITS \$ (4) 2-BED/2.5-BATH 1,800 SF EACH WITH AN

(2) PARKING SPACES PER UNIT

• (2) PROVIDED AT EACH UNIT (GARAGE) (I) VISITOR PARKING PER EACH 4 UNITS. • (4) PROVIDED; 3 STANDARD AND I VAN ACCESSIBLE.

ATTACHED 440 SF 2-CAR GARAGE

OPEN SPACE REQUIREMENTS

150 SF / UNIT REQUIRED PER UNIT UNIT I 100 SF AT FIRST FLOOR / 60 SF AT SECOND FLOOR DECK

I 64 SF AT FIRST FLOOR PATIO 100 SF AT FIRST FLOOR / 60 SF AT SECOND FLOOR DECK I 63 SF AT FIRST FLOOR PATIO UNIT 10 163 SF AT FIRST FLOOR PATIO

 UNIT 12 164 SF AT FIRST FLOOR PATIO 400 SF / UNIT (FOR 2-BR UNIT) (4) BEDROOM UNITS 1,600 SF

UNIT 11 163 SF AT FIRST FLOOR PATIO

SHEET INDEX

A-000 TITLE SHEET

A-100 SITE PLAN A-101 FENCE PLANS

A-102 EXISTING DEMO SITE PLAN

A-103 FIRST FLOOR PLAN (BUILDINGS A&C) A-104 FIRST FLOOR PLAN (BUILDINGS B & D)

A-105 SECOND FLOOR PLAN

A-106 TYPICAL ROOF PLAN

A-200 ELEVATIONS - BUILDINGS A & C

A-201 ELEVATIONS - BUILDINGS A & C A-202 ELEVATIONS - BUILDINGS B\$ D

A-203 ELEVATIONS - BUILDINGS B\$ D

A-400 SCHEDULES

A-500 DETAILS

C-I CONCEPTUAL GRADING PLAN

CONCEPTUAL GRADING PLAN

CONCEPTUAL LANDSCAPE PLAN






WHITE AVENUE 12-UNIT

WF Feron LLC 1452 WHITE AVENUE POMONA, CA • APN:8343-008-020 REVISIONS PROJECT NO.

DESIGN CONCEPT STUDIO

These drawings are rendered as inturuments of service and are the intelectual property of the designer.

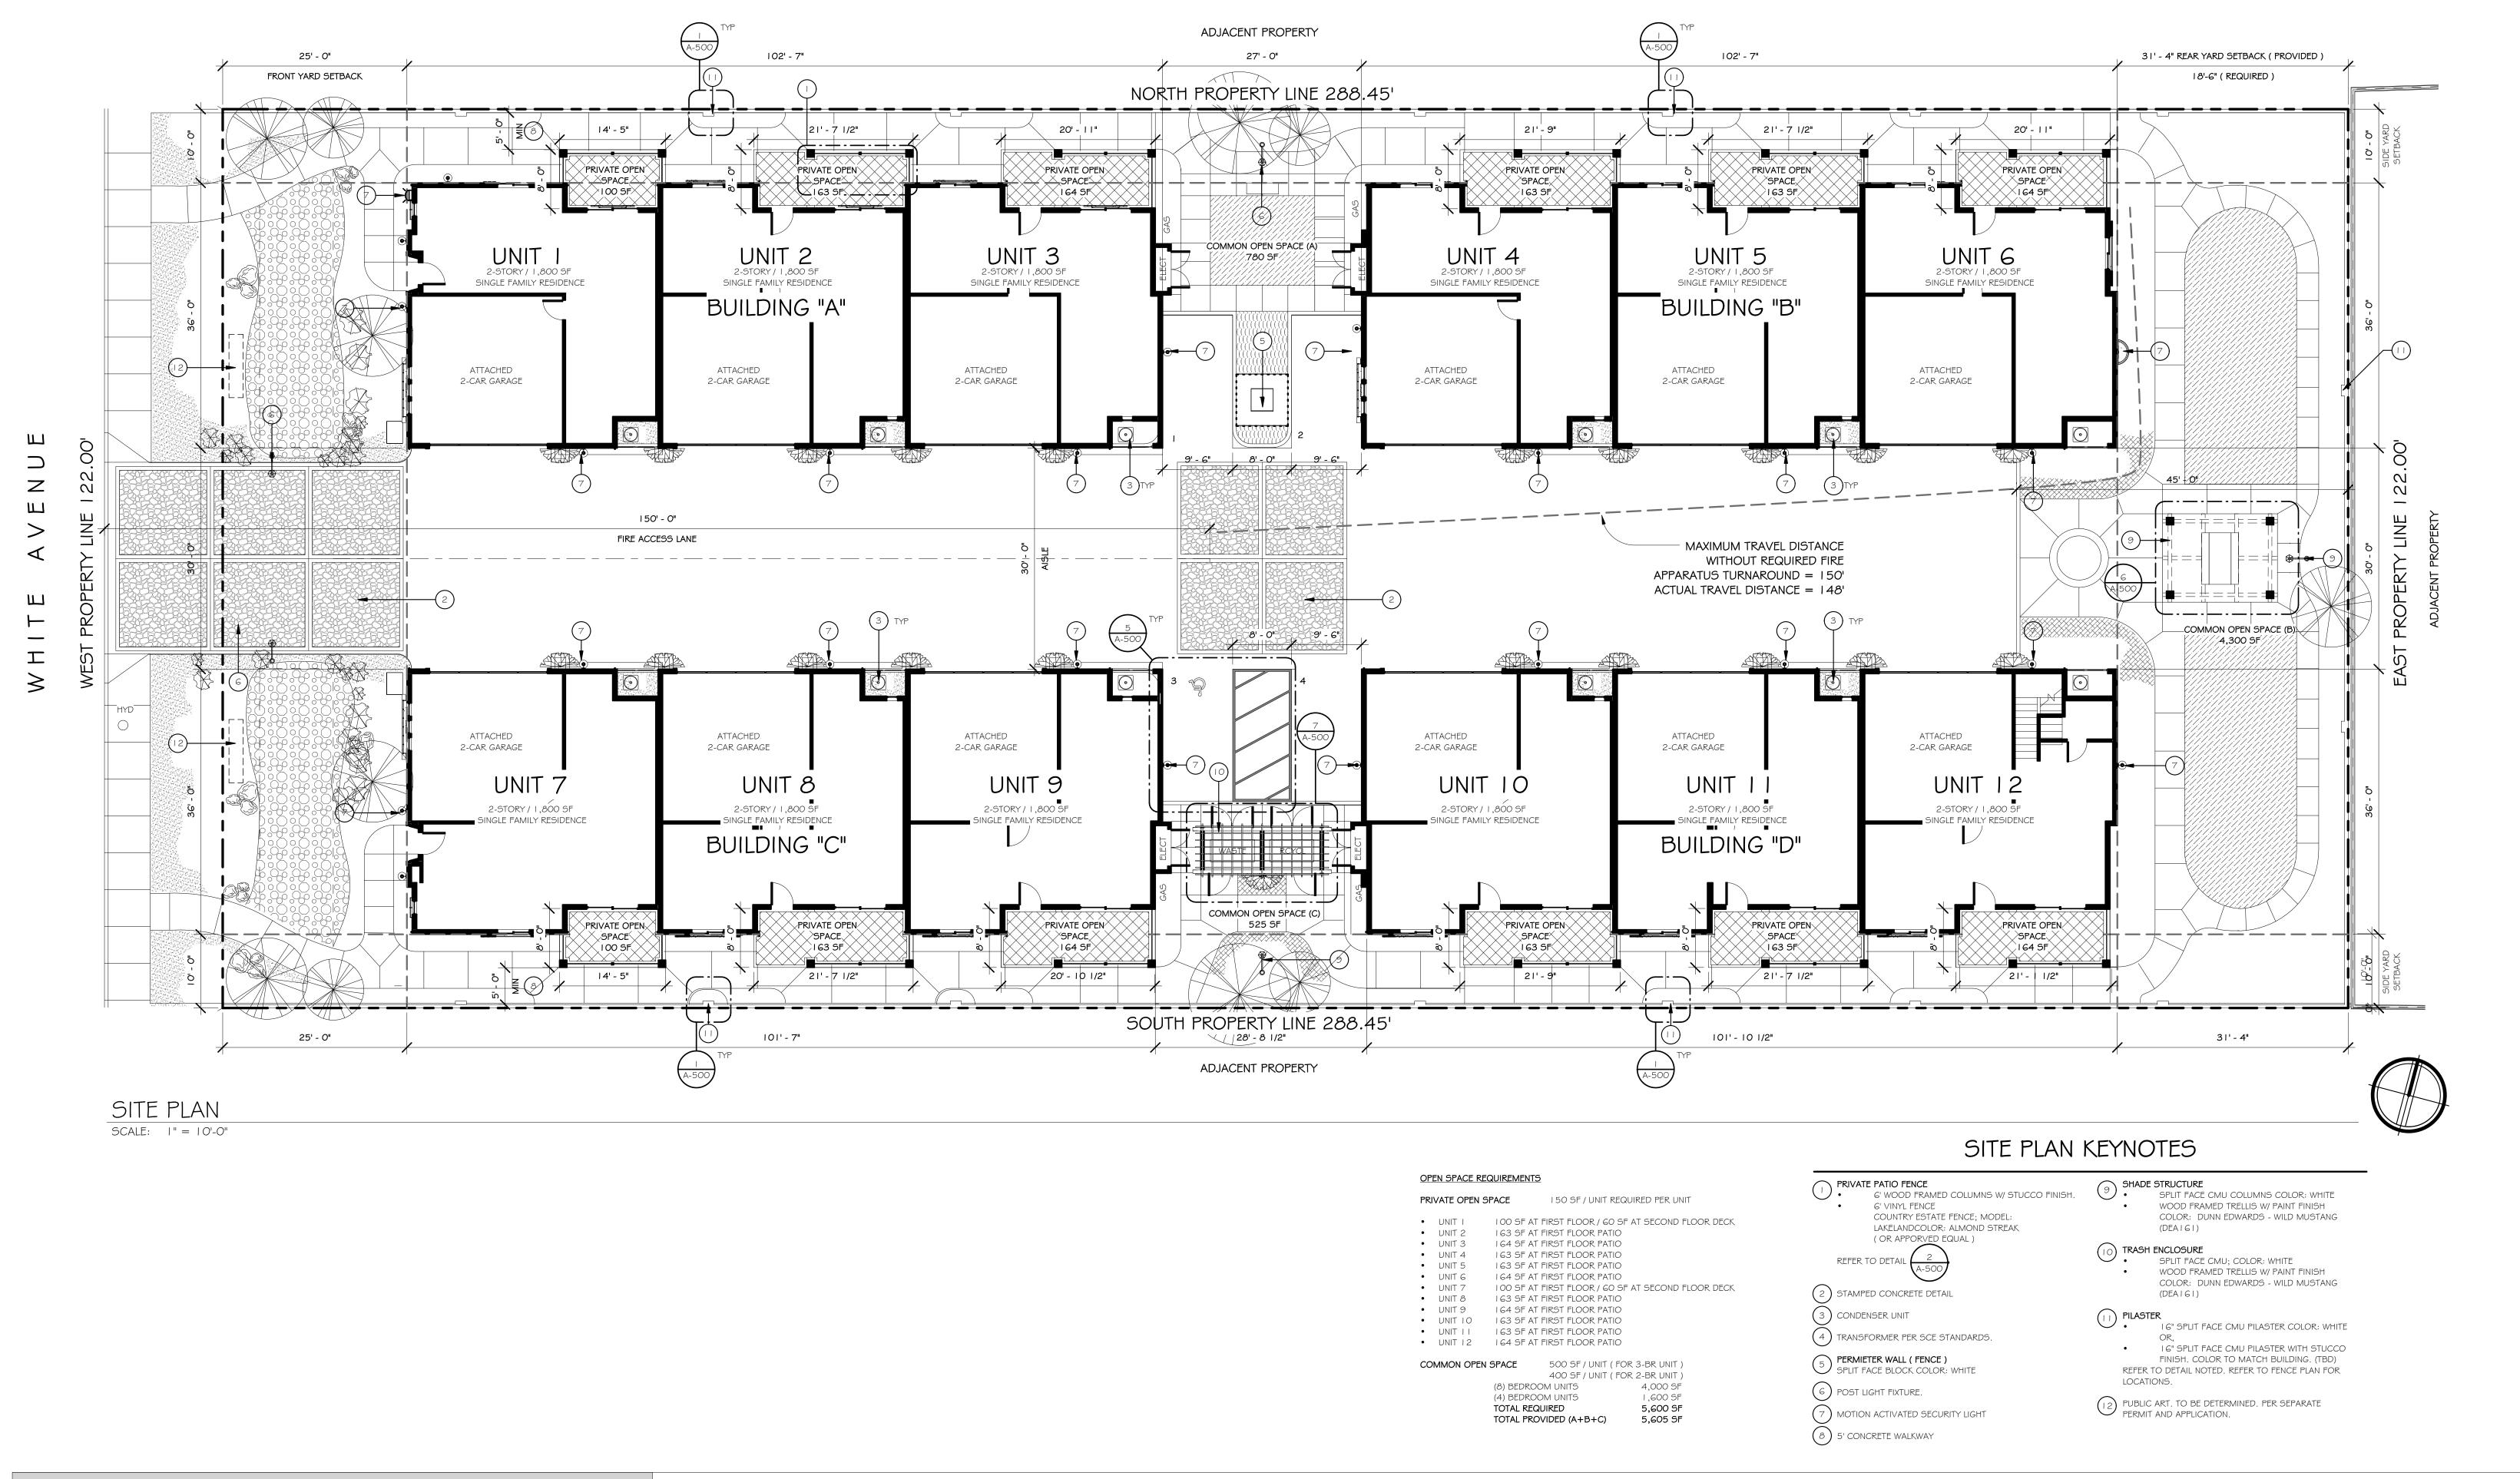

2844 E. THIRD STREET #204 • LONG BEACH, CA • 90814

These drawings are rendered as inturuments of service and are the intelectual property of the designer.

WHITE AVENUE I 2-UNIT

WF Feron LLC


1452 WHITE AVENUE POMONA, CA • APN:8343-008-020

 REVISIONS
 PROJECT NO.
 11810-14

 DRAWN BY
 VML

 DATE
 6/21/2017 9:40:41 PM

A-100

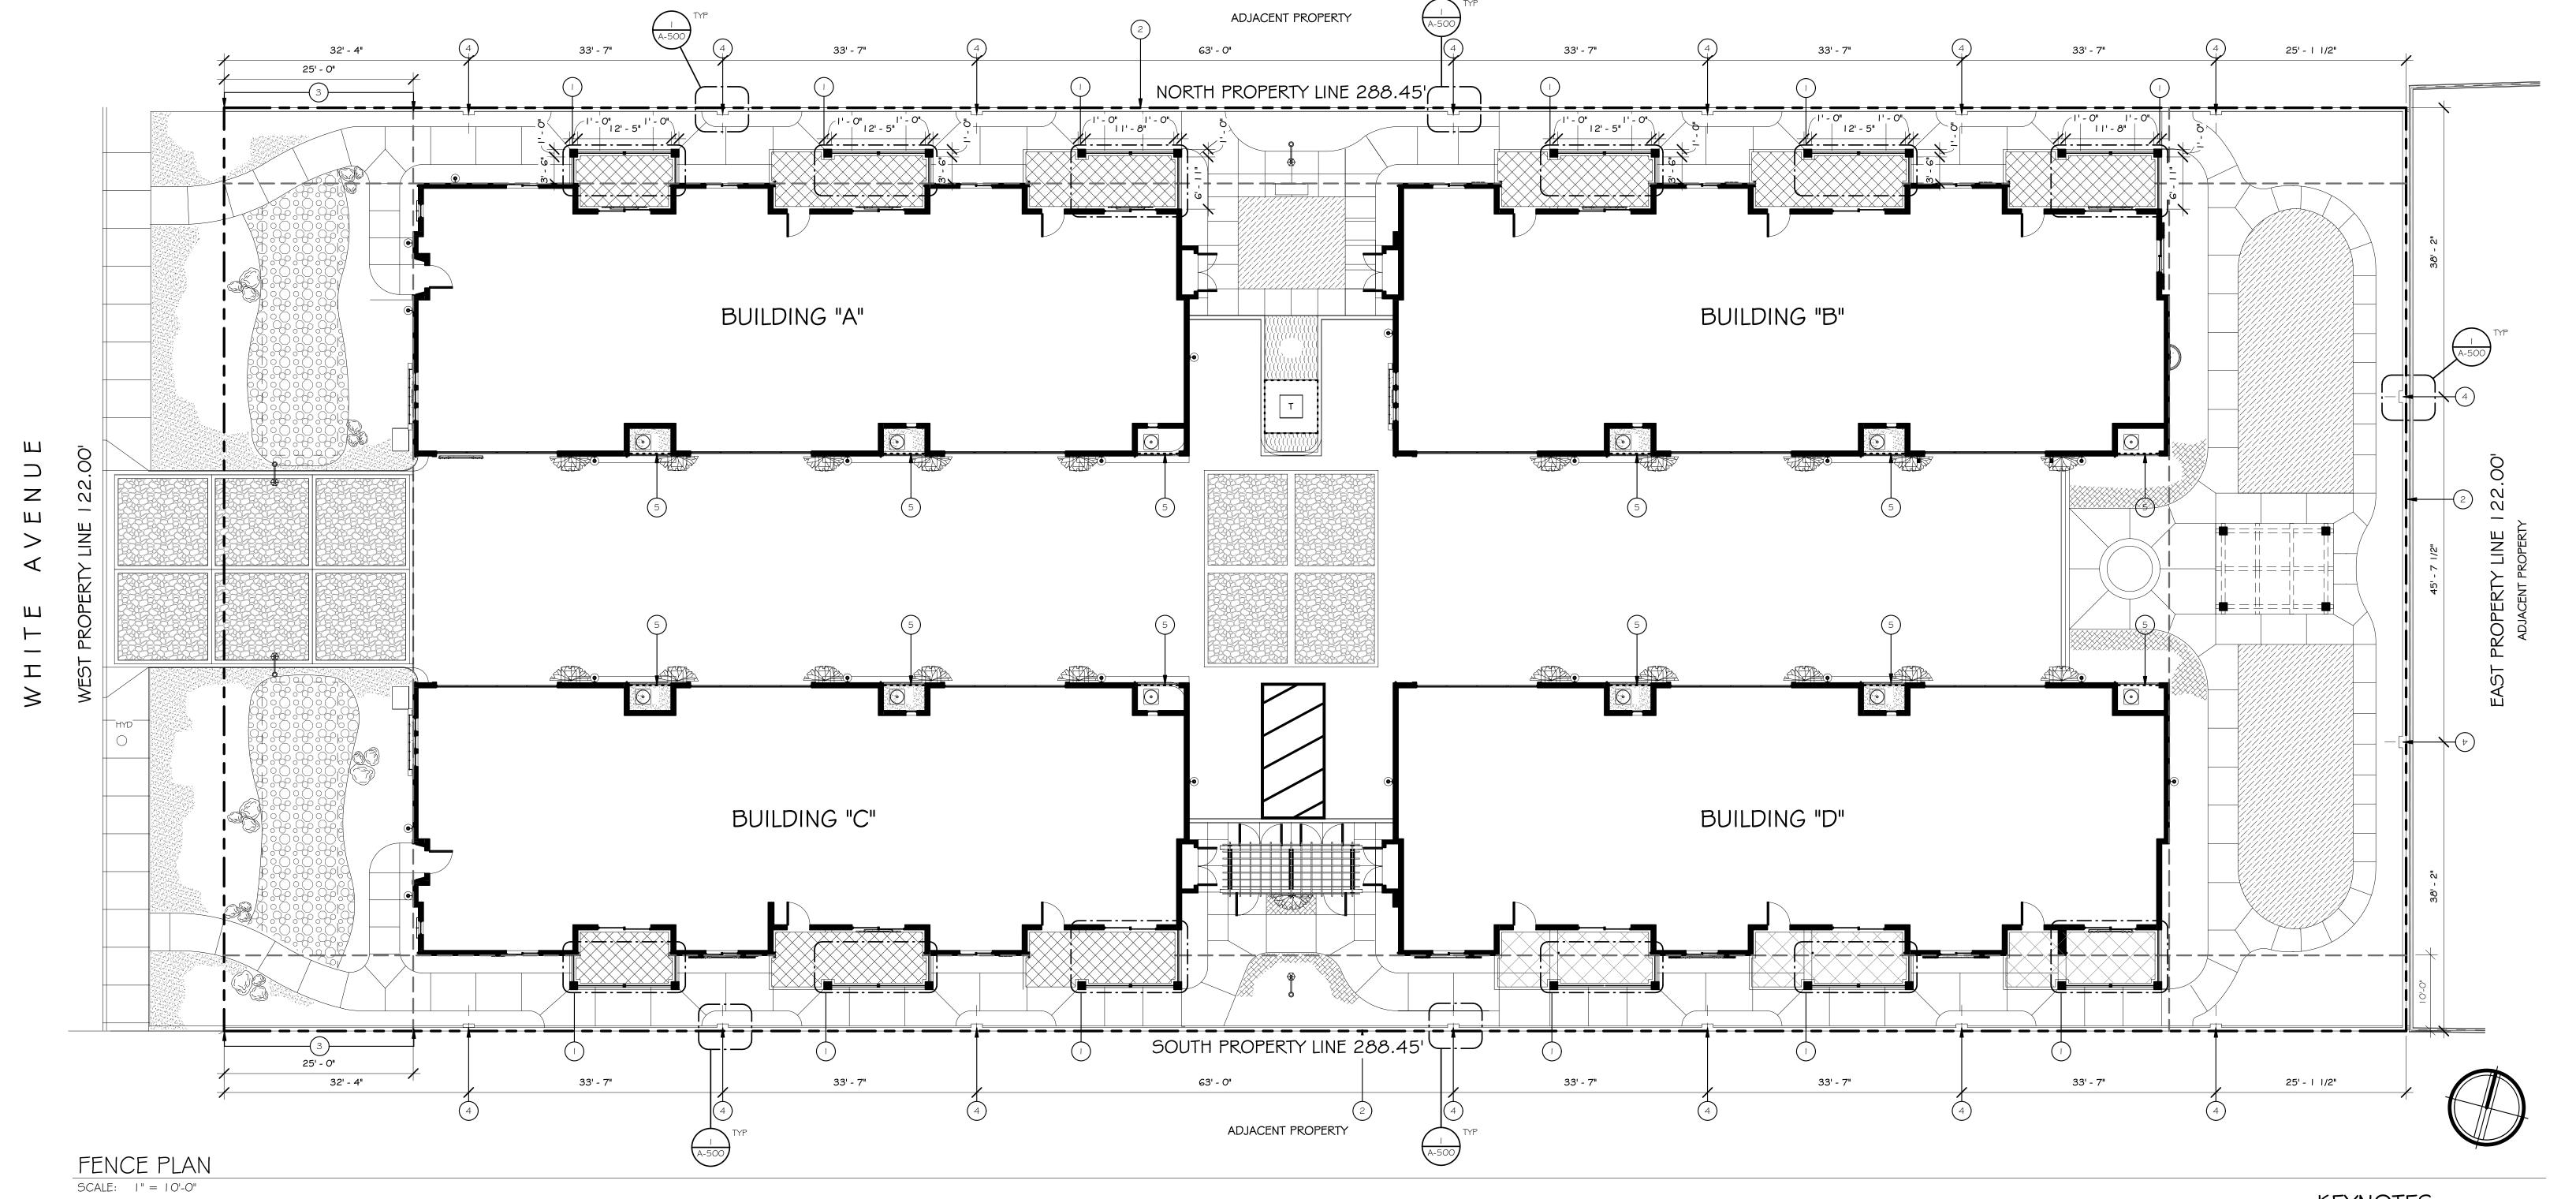

KEYNOTES

- PRIVATE PATIO FENCE

 I FT. SQ.6' WOOD FRAMED COLUMNS W/ STUCCO FINISH.

 G' VINYL FENCE
 COUNTRY ESTATE FENCE; MODEL: LAKELANDCOLOR:
 ALMOND STREAK (OR APPORVED EQUAL)

 REFER TO DETAIL

 2
- 2 PERMIETER WALL (FENCE)
 SPLIT FACE BLOCK COLOR: WHITE
- 3' HIGH CMU PERIMETER WALL. WITHIN 25' FRONT YARD SETBACK. SPLIT FACE BLOCK COLOR: WHITE
- PILASTER

 I 6" SPLIT FACE CMU PILASTER COLOR: WHITE OR,

 I 6" SPLIT FACE CMU PILASTER WITH STUCCO FINISH.

 COLOR TO MATCH BUILDING. (TBD)

 REFER TO DETAIL NOTED. REFER TO FENCE PLAN FOR LOCATIONS
- 6' VINYL FENCE AND 3' DOOR.
 COUNTRY ESTATE FENCE; MODEL: LAKELAND
 COLOR: ALMOND STREAK (OR APPORVED EQUAL)

DESIGN	CONCEPT	STIIDIO
DLJIGIN	CONCLI	

2844 E. THIRD STREET #204 • LONG BEACH, CA • 90814

These drawings are rendered as inturuments of service and are the intelectual property of the designer.

WHITE AVENUE 12-UNIT

WF Feron LLC


1452 WHITE AVENUE POMONA, CA • APN:8343-008-020

 REVISIONS
 PROJECT NO.
 11810-14

 DRAWN BY
 Author

 DATE
 6/21/2017 9:40:48 PM

A-101

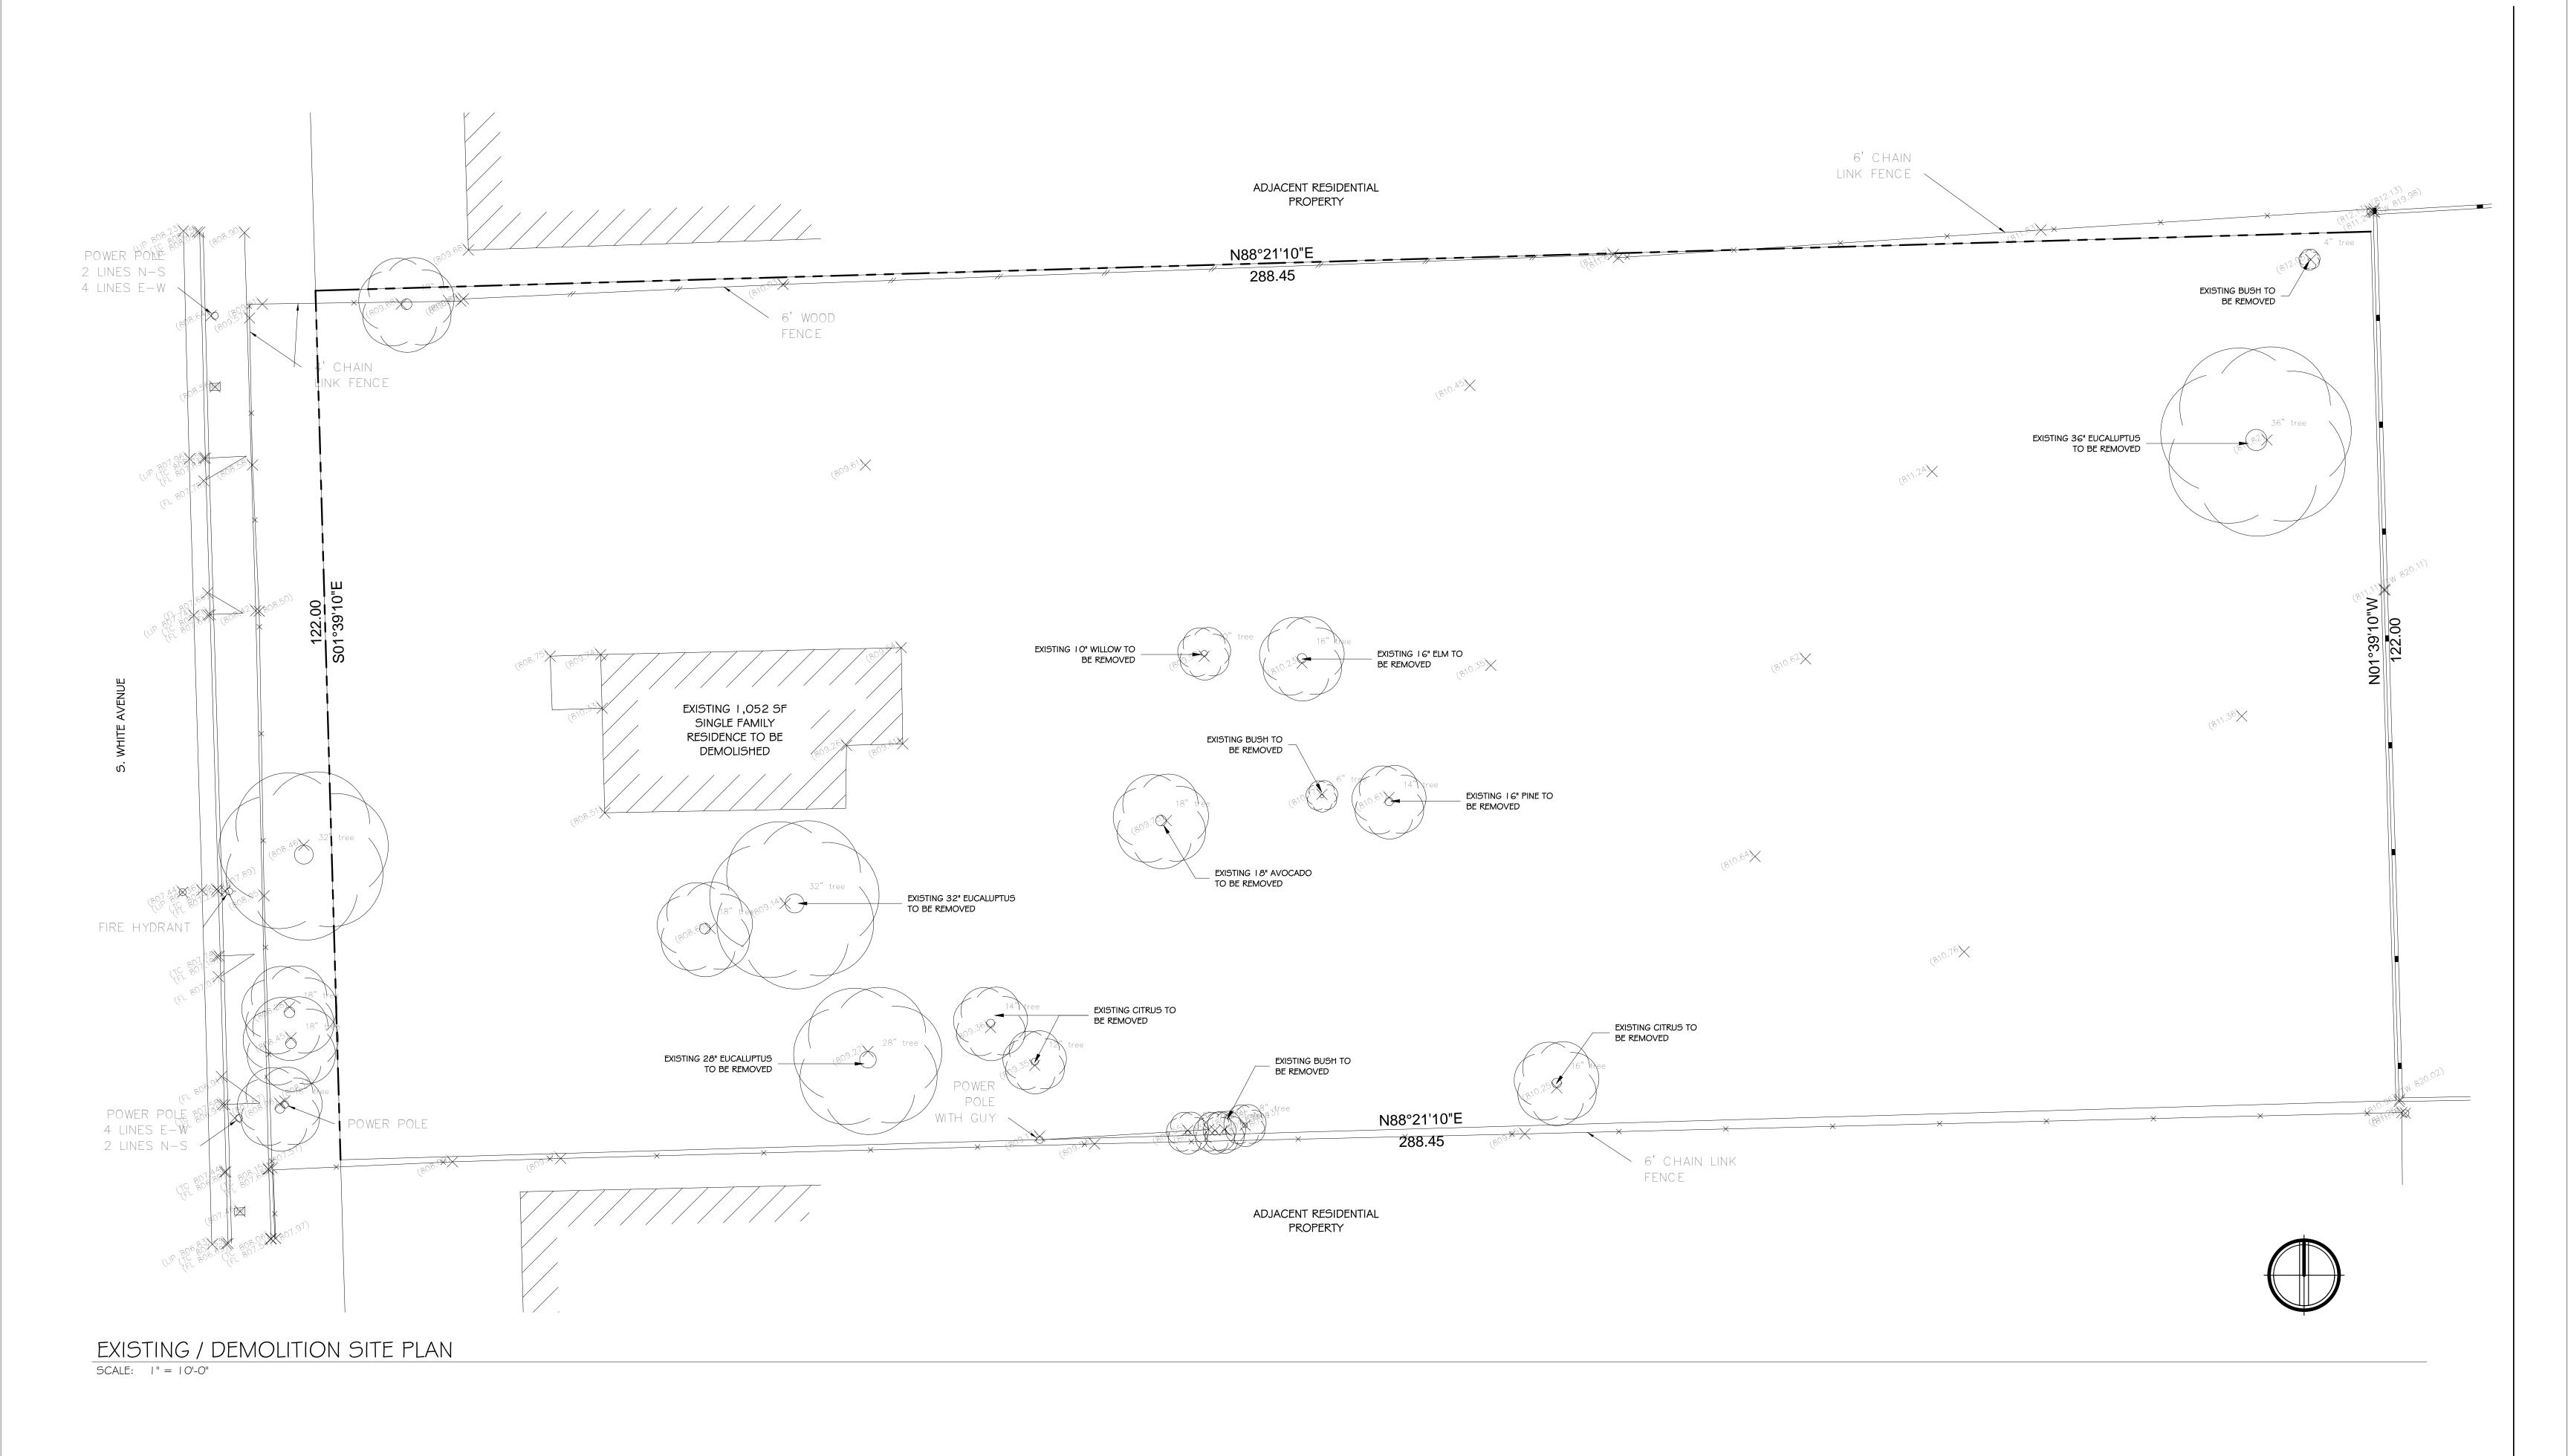


2844 E. THIRD STREET #204 • LONG BEACH, CA • 90814

These drawings are rendered as inturuments of service and are the intelectual property of the designer.


WHITE AVENUE 12-UNIT

WF Feron LLC 1452 WHITE AVENUE POMONA, CA • APN:8343-008-020

PROJECT NO. REVISIONS 11810-14 DRAWN BY

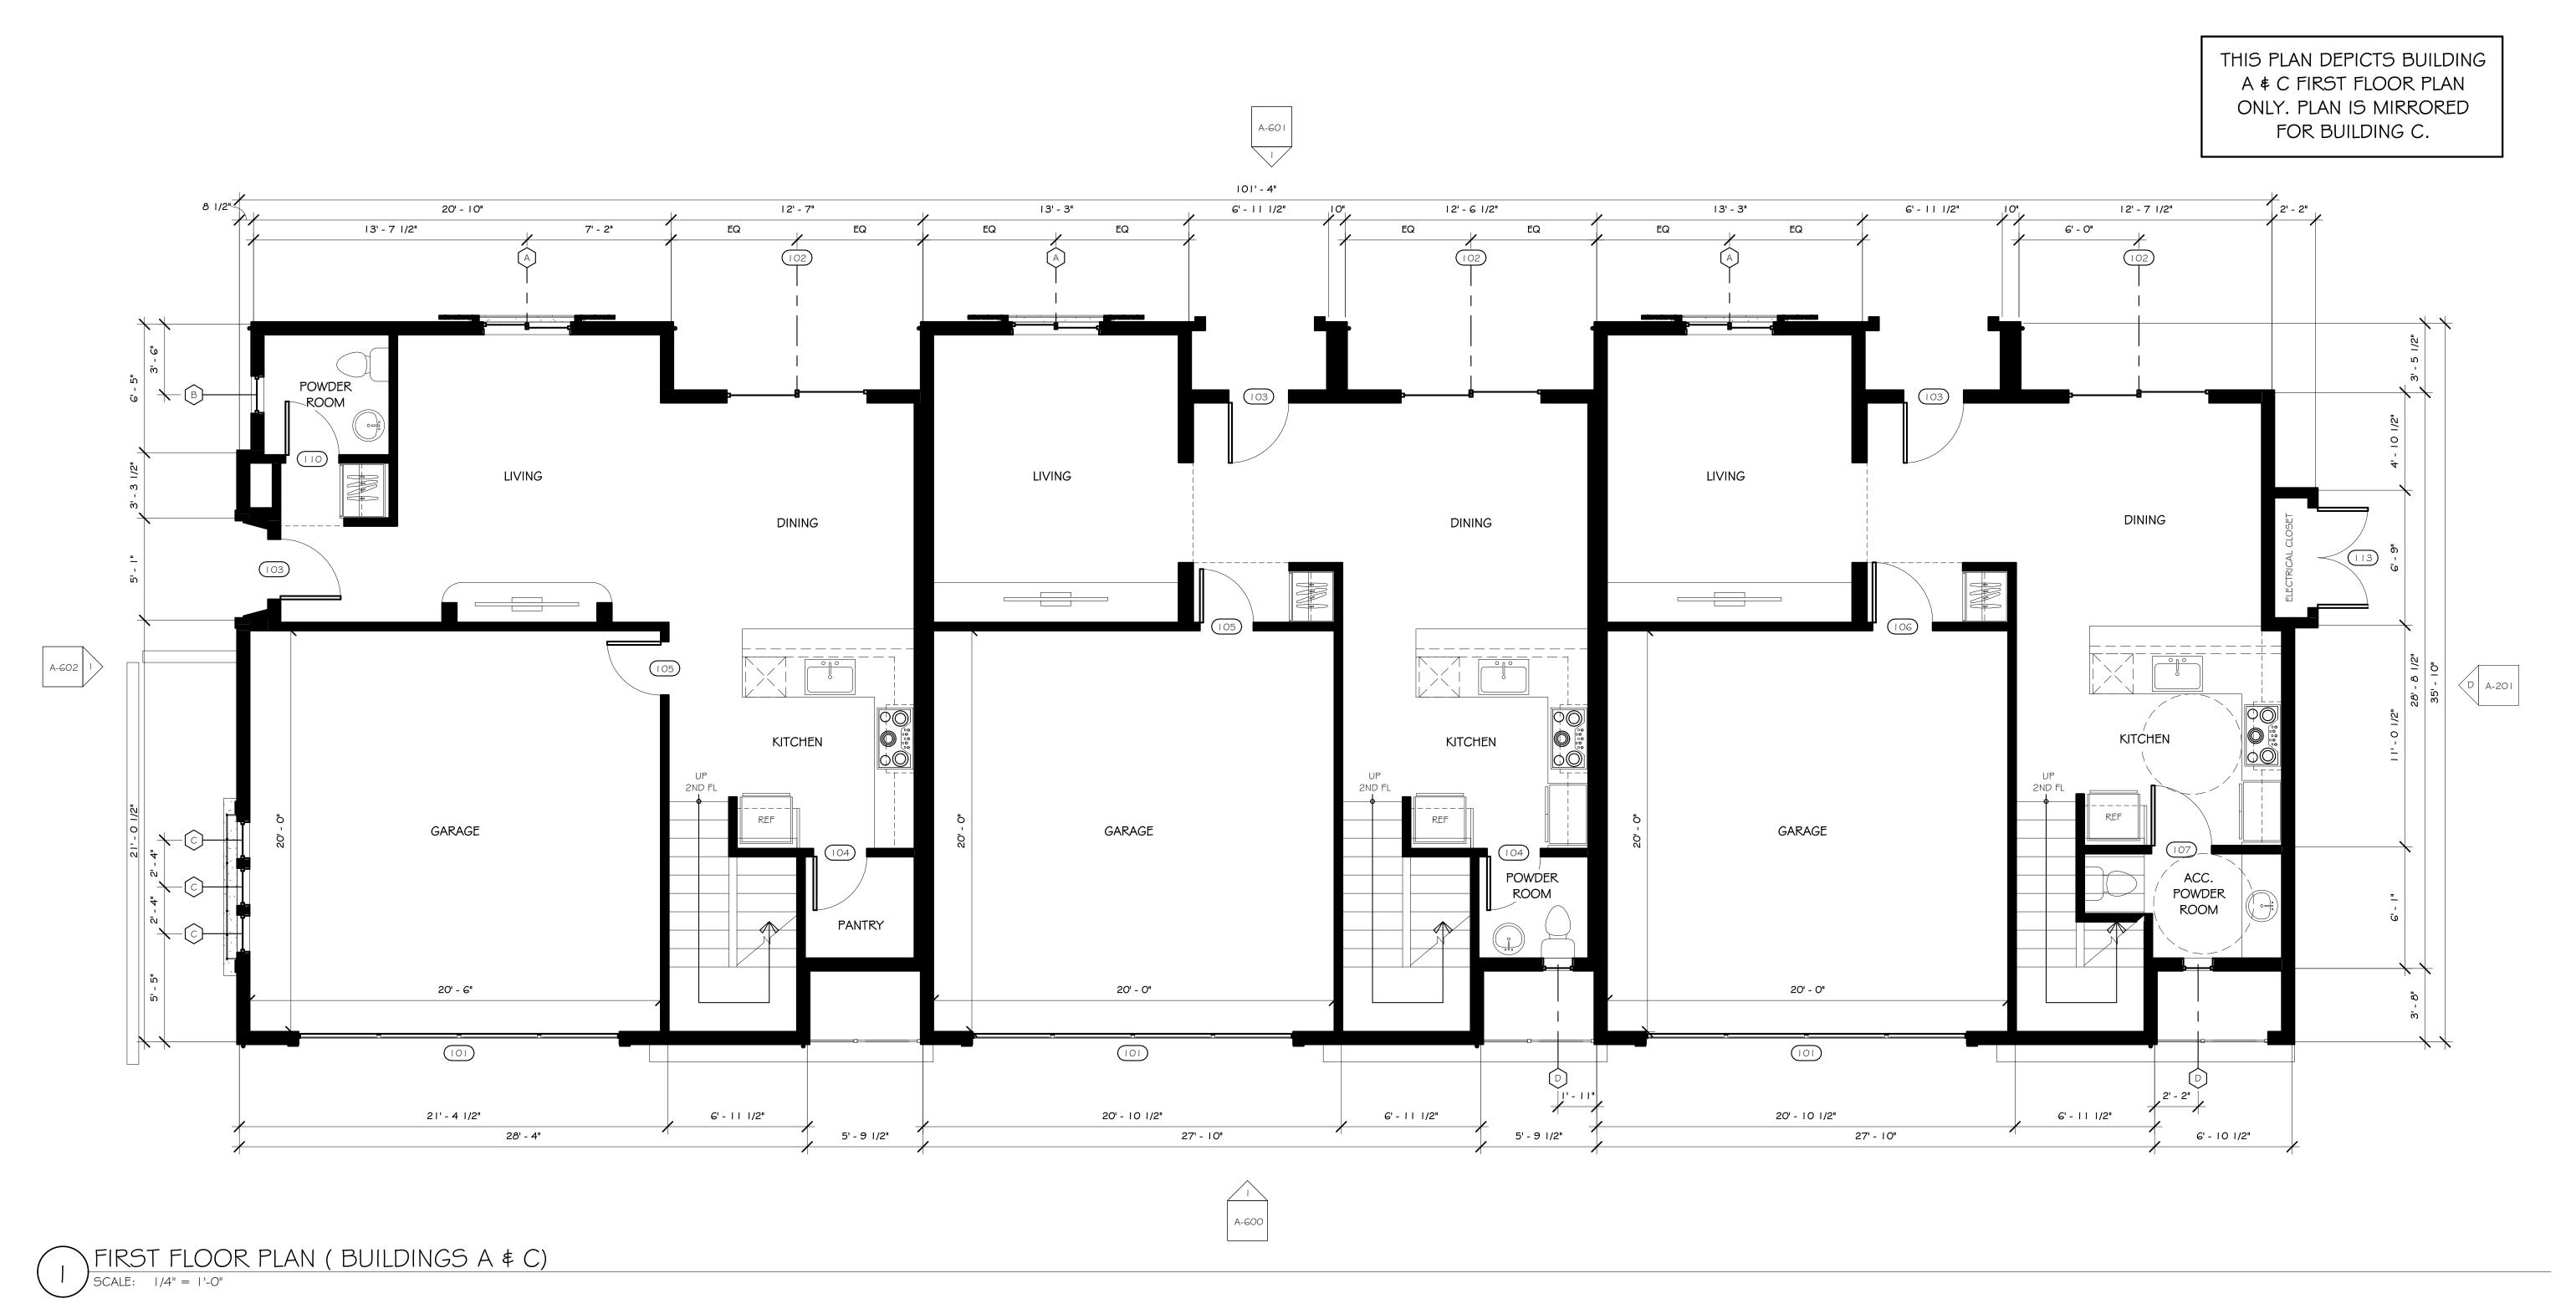



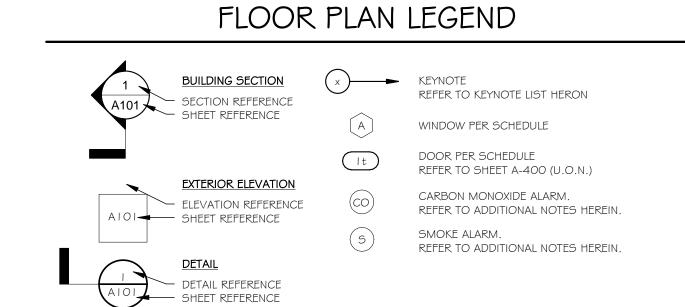

These drawings are rendered as inturuments of service and are the intelectual property of the designer.

2844 E. THIRD STREET #204 • LONG BEACH, CA • 90814

WHITE AVENUE 12-UNIT

WF Feron LLC

1452 WHITE AVENUE POMONA, CA • APN:8343-008-020


 REVISIONS
 PROJECT NO.
 11810-14

 DRAWN BY
 VML

 DATE
 6/21/2017 9:40:51 PM


A-103

THIS PLAN DEPICTS BUILDING B & D FIRST FLOOR PLAN ONLY. PLAN IS MIRRORED FOR BUILDING D.

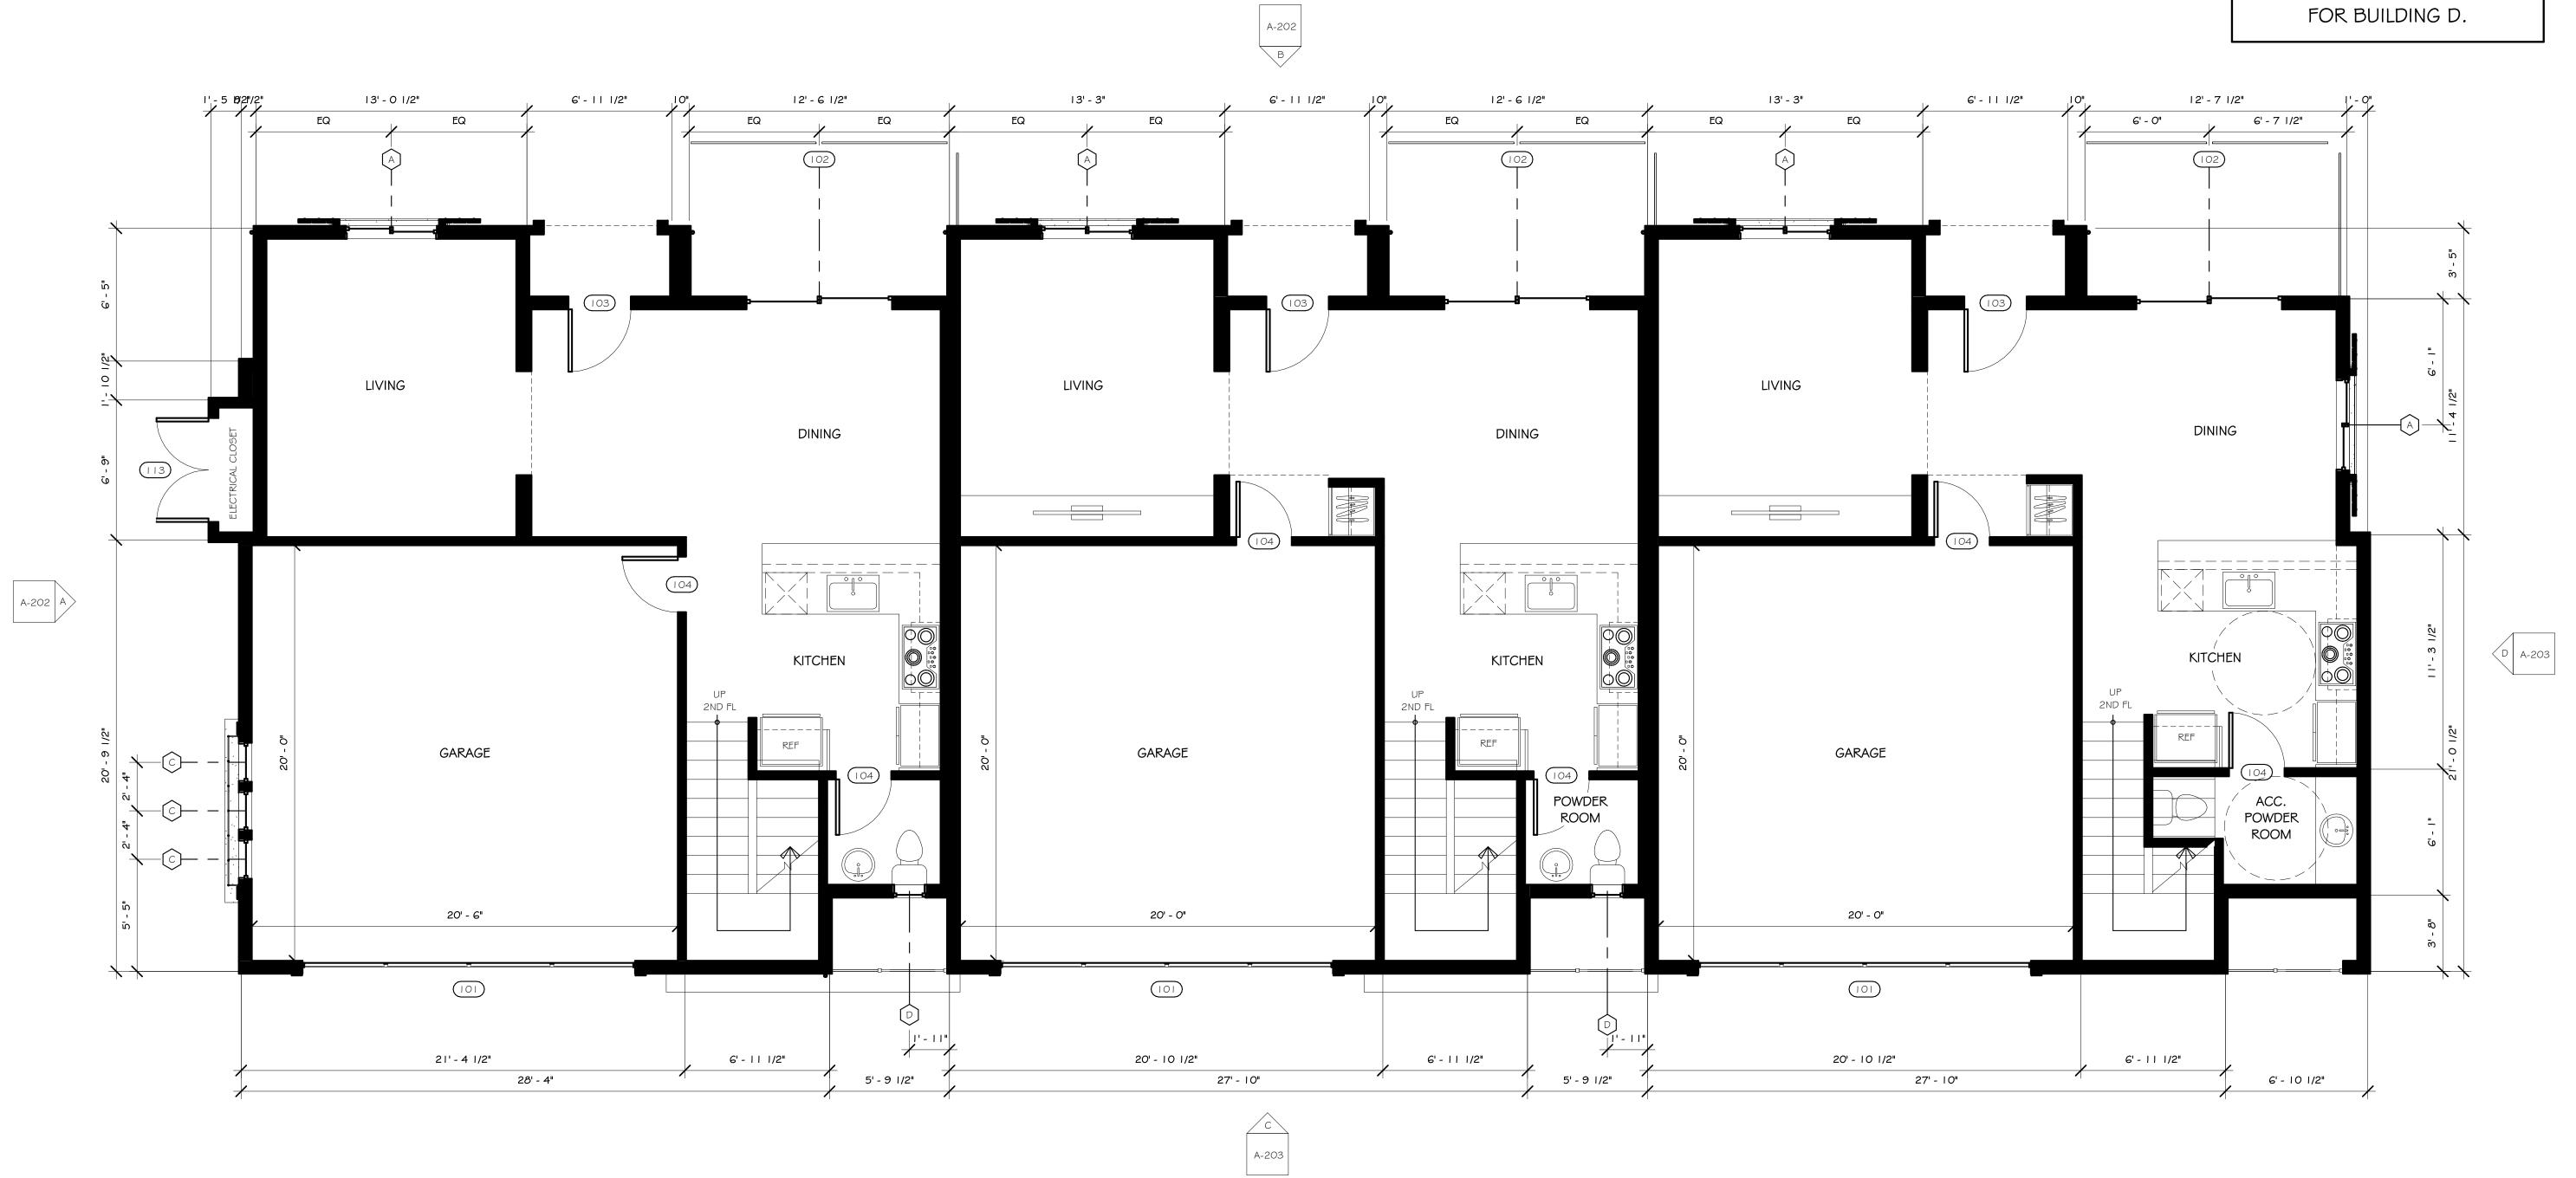

FIRST FLOOR PLAN (BUILDINGS B & D)

FLOOR PLAN LEGEND

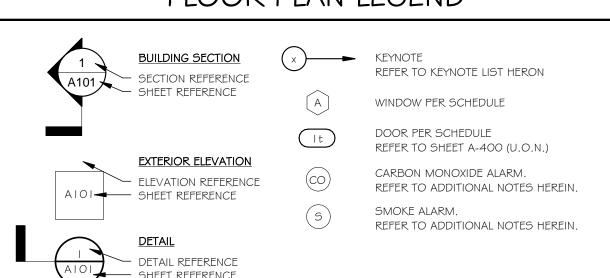

DESIGN CONCEPT STUDIO


2844 E. THIRD STREET #204 • LONG BEACH, CA • 90814

WHITE AVENUE 12-UNIT WF Feron LLC


1452 WHITE AVENUE POMONA, CA • APN:8343-008-020

PROJECT NO. REVISIONS 11810-14 DRAWN BY 6/21/2017 9:40:51 PM DATE

These drawings are rendered as inturuments of service and are the intelectual property of the designer.

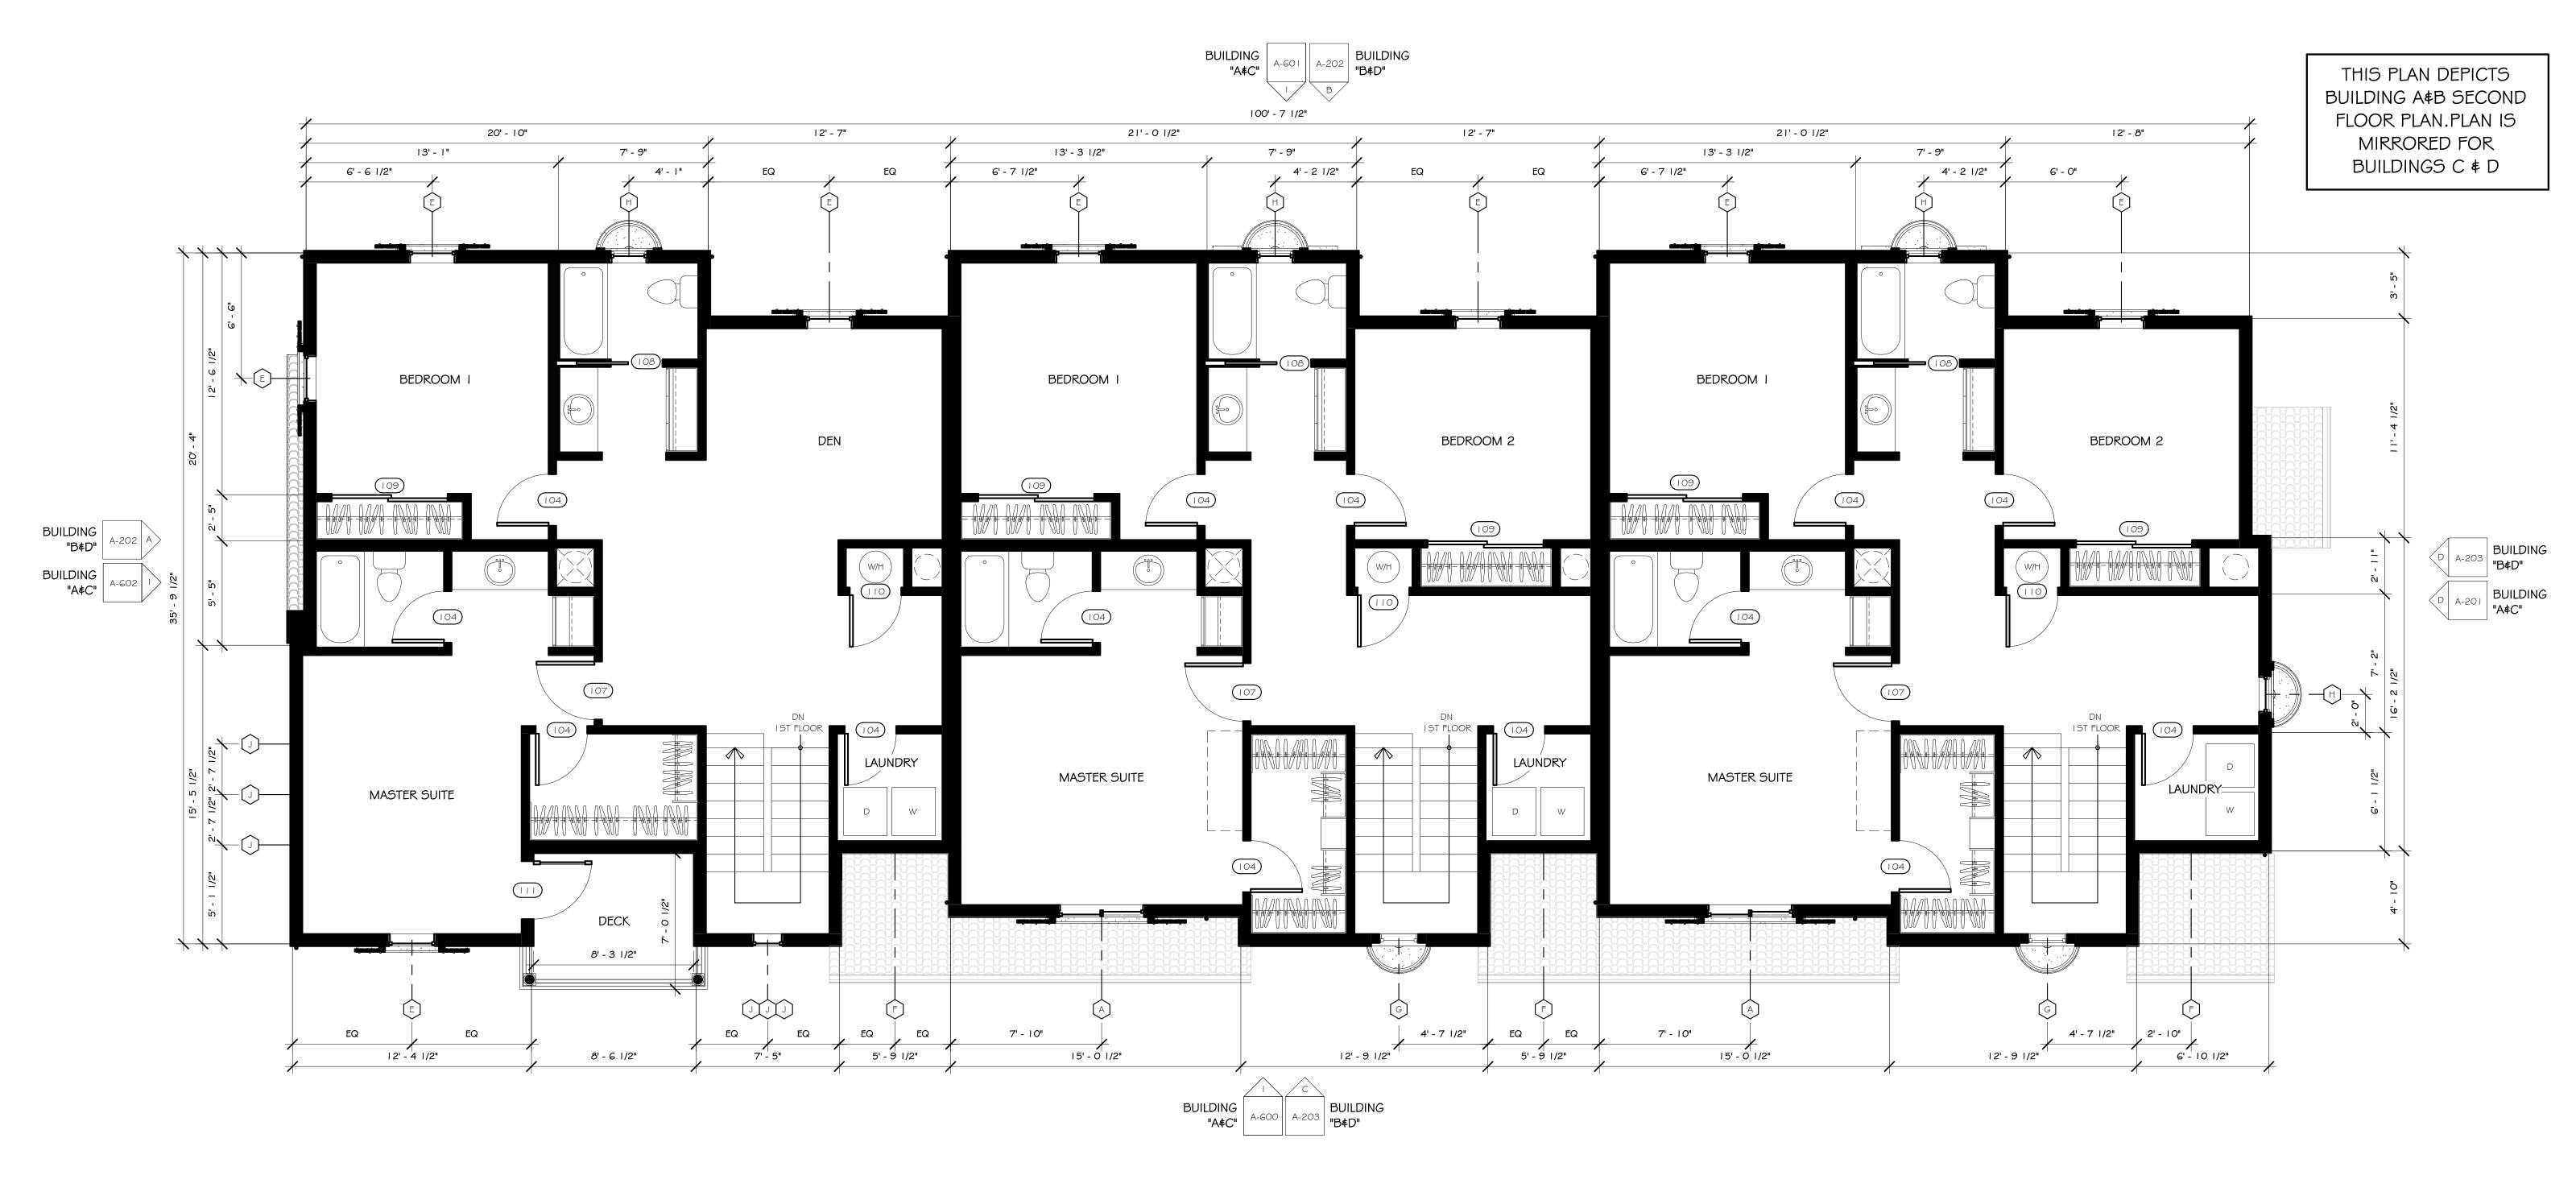

SECOND FLOOR PLAN SCALE: 1/4" = 1'-0"

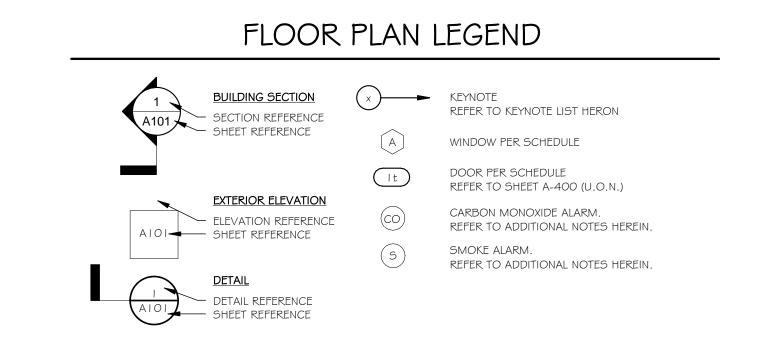

DESIGN CONCEPT STUDIO


2844 E. THIRD STREET #204 • LONG BEACH, CA • 90814


These drawings are rendered as inturuments of service and are the intelectual property of the designer.

WHITE AVENUE 12-UNIT


WF Feron LLC

1452 WHITE AVENUE POMONA, CA • APN:8343-008-020

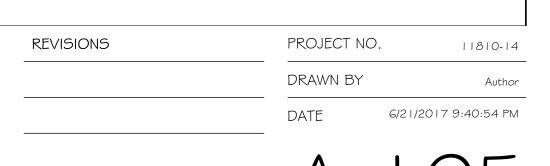

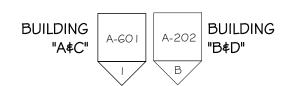

THIS PLAN DEPICTS BUILDING A & B ROOF PLAN ONLY. PLAN IS MIRRORED FOR BUILDINGS C & D.

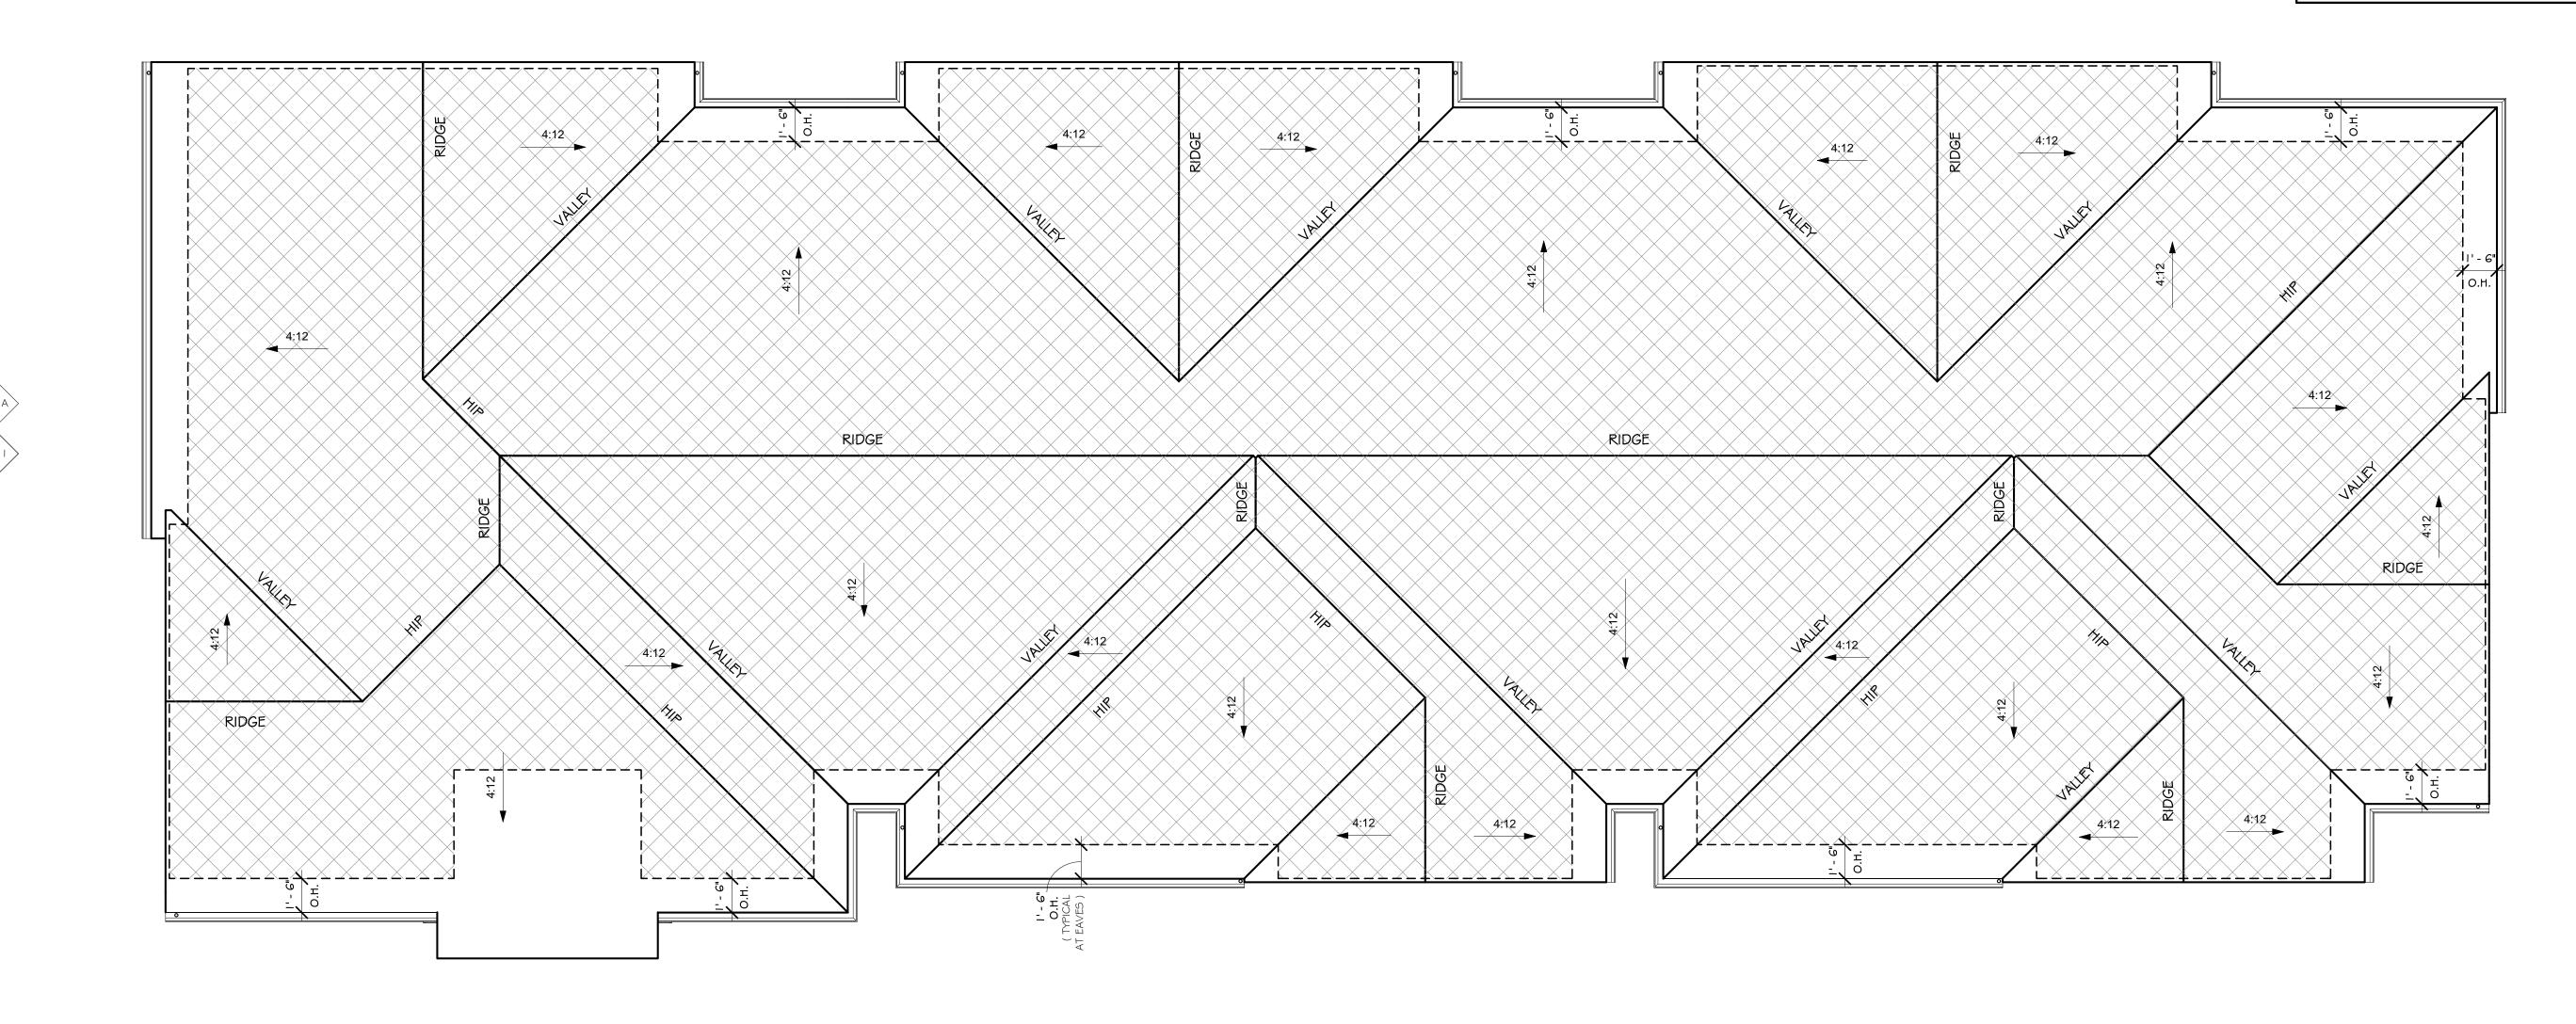

ROOF NOTES

ROOFING:

EAGLE ROOFING PRODUCTS BUILDER SELECT STANDARD WEIGHT ROOFING TILES STYLE: MALIBU COLOR: VALENCIA OR KONA RED RANGE (9.7 PSF; APPROX.) CLASS "A" TILE ROOFING; KINGS CANYON BLEND,

ATTIC VENTILATION:

ICC-ES ESR- I 900(OR EQUAL)

3,359 SQ. FT. OF ATTIC AREA X 1/150 = 22.4 SQ. FT. (3,325 SQ. IN.)

50% OF VENTILATION PROVIDED BY DORMER VENTS 3' ABOVE EAVE. 1,612.5 SQ. IN OF VENTILATION REQUIRED AT DORMER VENTS. DORMER VENTS SHALL BE 24" HALF ROUND METAL VENT LOUVERS PROVIDING 100 SQ. IN. OF VENTILATION. (17 VENTS REQUIRED) PAINT FINISH TO MATCH ROOFING COLOR.

50% OF VENTILATION PROVIDED BY EAVE VENTS. 1,612.5 SQ. IN OF VENTILATION REQUIRED AT EAVE VENTS. EAVE VENTS SHALL BE 6" X 14" PROVIDING 84 SQ. IN. OF VENTILATION. (20 VENTS REQUIRED) PAINT FINISH TO MATCH EAVE COLOR.

EAVE VENTS SHALL BE PROVIDED WITH A CORROSION RESISTANT WIRE MESH WITH 1/16" MIN TO 1/4" MAX. OPENINGS. A MIN. OF 1" AIRSPACE MUST BE MAINTAINED BETWEEN THE INSULATION AND THE ROOF SHEATHING AT LOCATIONS OF VENTS.

ALL VENTS SHALL BE COORDINATED TO PROVIDE PROPER CROOS VENTILATION AT ATTIC.

DESIGN CONCEPT STUDIO

BUILDING

BUILDING

ROOF PLAN (TYPICAL)

SCALE: 1/4" = 1'-0"

2844 E. THIRD STREET #204 • LONG BEACH, CA • 90814

These drawings are rendered as inturuments of service and are the intelectual property of the designer.


WF Feron LLC 1452 WHITE AVENUE POMONA, CA • APN:8343-008-020

WHITE AVENUE 12-UNIT

REVISIONS PROJECT NO. 11810-14 DRAWN BY 6/21/2017 9:40:54 PM

BUILDING

BUILDING

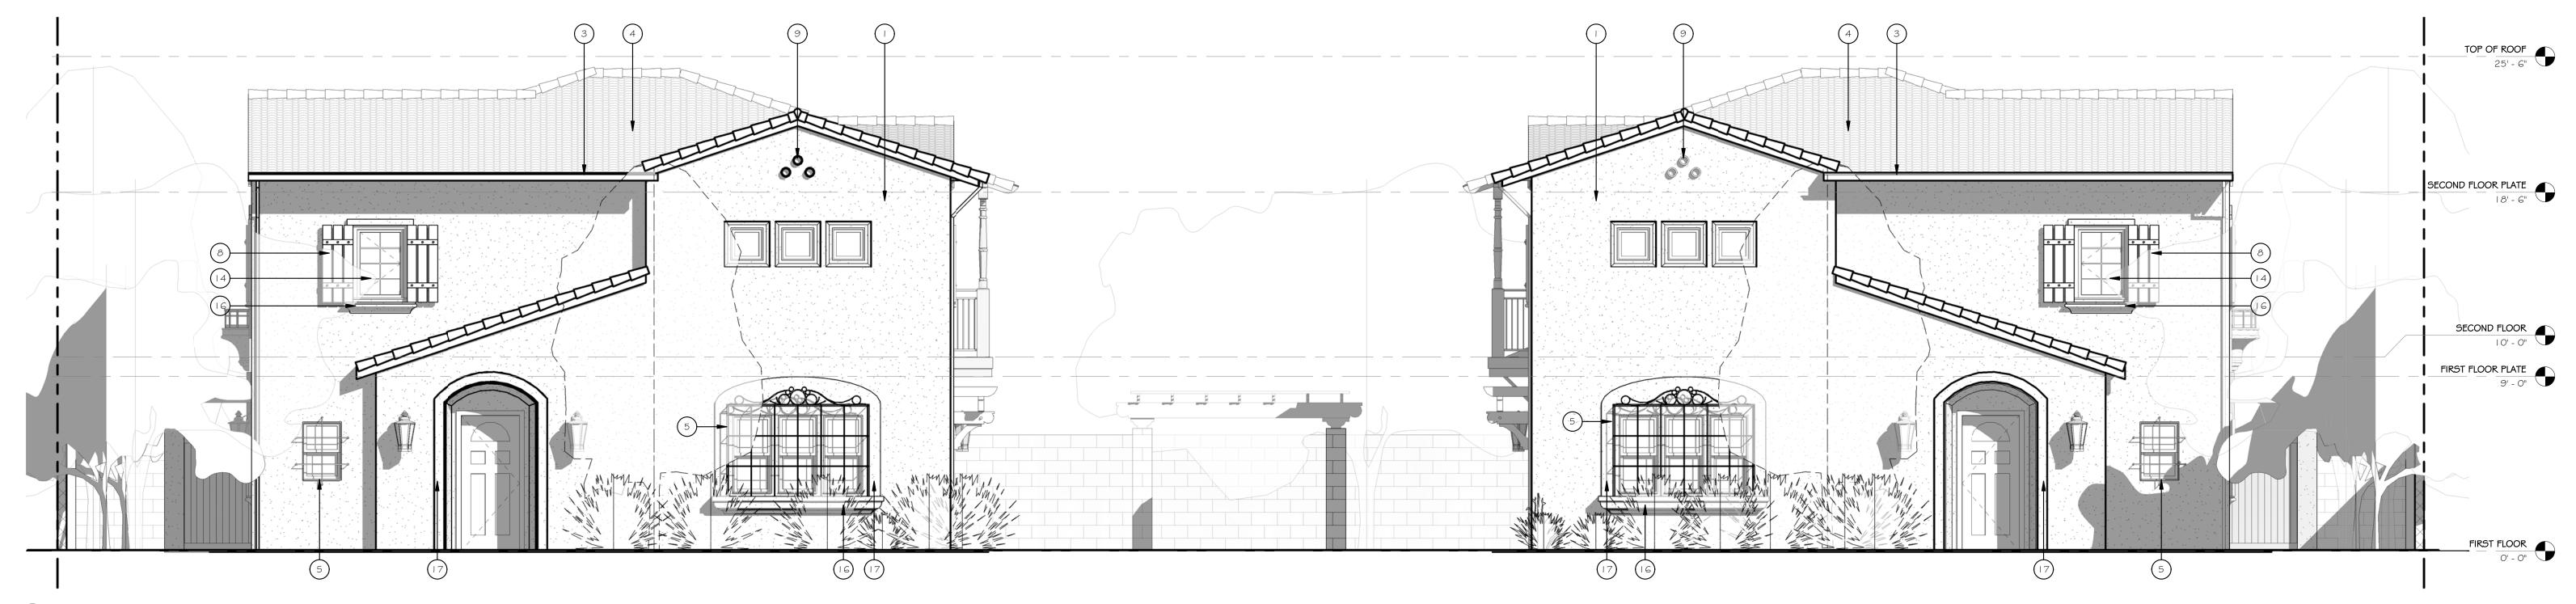

BUILDING A & C - WEST ELEVATION

NOT TO SCALE



EXTERIOR MATERIALS

- OMEGA STUCCO | 6/30 FINISH O/ METAL LATH. COLOR #10 (OR APPROVED EQUAL)

THIS ELEVATION DEPICTS

BUILDING A ONLY.

ELEVATION IS MIRRORED

FOR BUILDING C.

- WOOD TRIM W/ PAINT FINISH. COLOR: DUNN EDWARDS WILD MUSTANG (DEA I G I)
- PRE-FINISHED 5" ALUMINUM OGEE STYLE RAIN GUTTER W/ 2"X3" DOWNSPOUTS AND COLLECTOR BOX. COLOR: BROWN
- EAGLE STANDARD WEIGHT ROOFING TILES STYLE: MALIBU
 - VALENCIA KONA RED RANGE OR APPROVED EQUAL
 - TUBE STEEL METALWORK COLOR: DUNN EDWARDS - BLACK BEAN(DEG385)
- 6 WOOD FRAMED TRELLIS WITH PAINT FINISH.
 COLOR: DUNN EDWARDS WILD MUSTANG (DEA I G I)
- 7 G' VINYL FENCE COUNTRY ESTATE FENCE; MODEL: LAKELAND COLOR: ALMOND STREAK (OR APPORVED EQUAL)
- SHUTTERS HENNIS ENTERPRISES LOUVERED WITH TRIM (OR APPROVED EQUAL)
- PAINT FINISH.; COLOR: DUNN EDWARDS BLUE STEEL (DE6342)
- WOOD FRAMED COLUMN W/ STUCCO FINISH.
- COLOR TO MATCH BUILDING
- WALL SCONCE
- PREFENISHED SECTIONAL METAL GARAGE DOOR. COLOR: BROWN
- WOOD CORBEL W/ PAINT FINISH COLOR: DUNN EDWARDS - WILD MUSTANG (DEA 161)
- VINYL WINDOWS
- COLOR: TAN (TYPICAL)
- FOAM PROFILE WITH STUCCO FINISH COLOR TO MATCH BUILDING
- 42" HIGH TUBE STEEL GUARDRAIL
- COLOR: DUNN EDWARDS BLACK BEAN(DE6385) WOOD PROFILE WITH STUCCO FINISH
- TURN POST DETAIL WITH PAIN FINISH COLOR: DUNN EDWARDS WILD MUSTANG (DEA I G I)

DESIGN CONCEPT STUDIO

2844 E. THIRD STREET #204 • LONG BEACH, CA • 90814

These drawings are rendered as inturuments of service and are the intelectual property of the designer.


WHITE AVENUE 12-UNIT

WF Feron LLC

1452 WHITE AVENUE POMONA, CA • APN:8343-008-020

REVISIONS PROJECT NO. 11810-14 DRAWN BY

THIS ELEVATION DEPICTS BUILDING A ONLY. ELEVATION IS MIRRORED FOR BUILDING C.

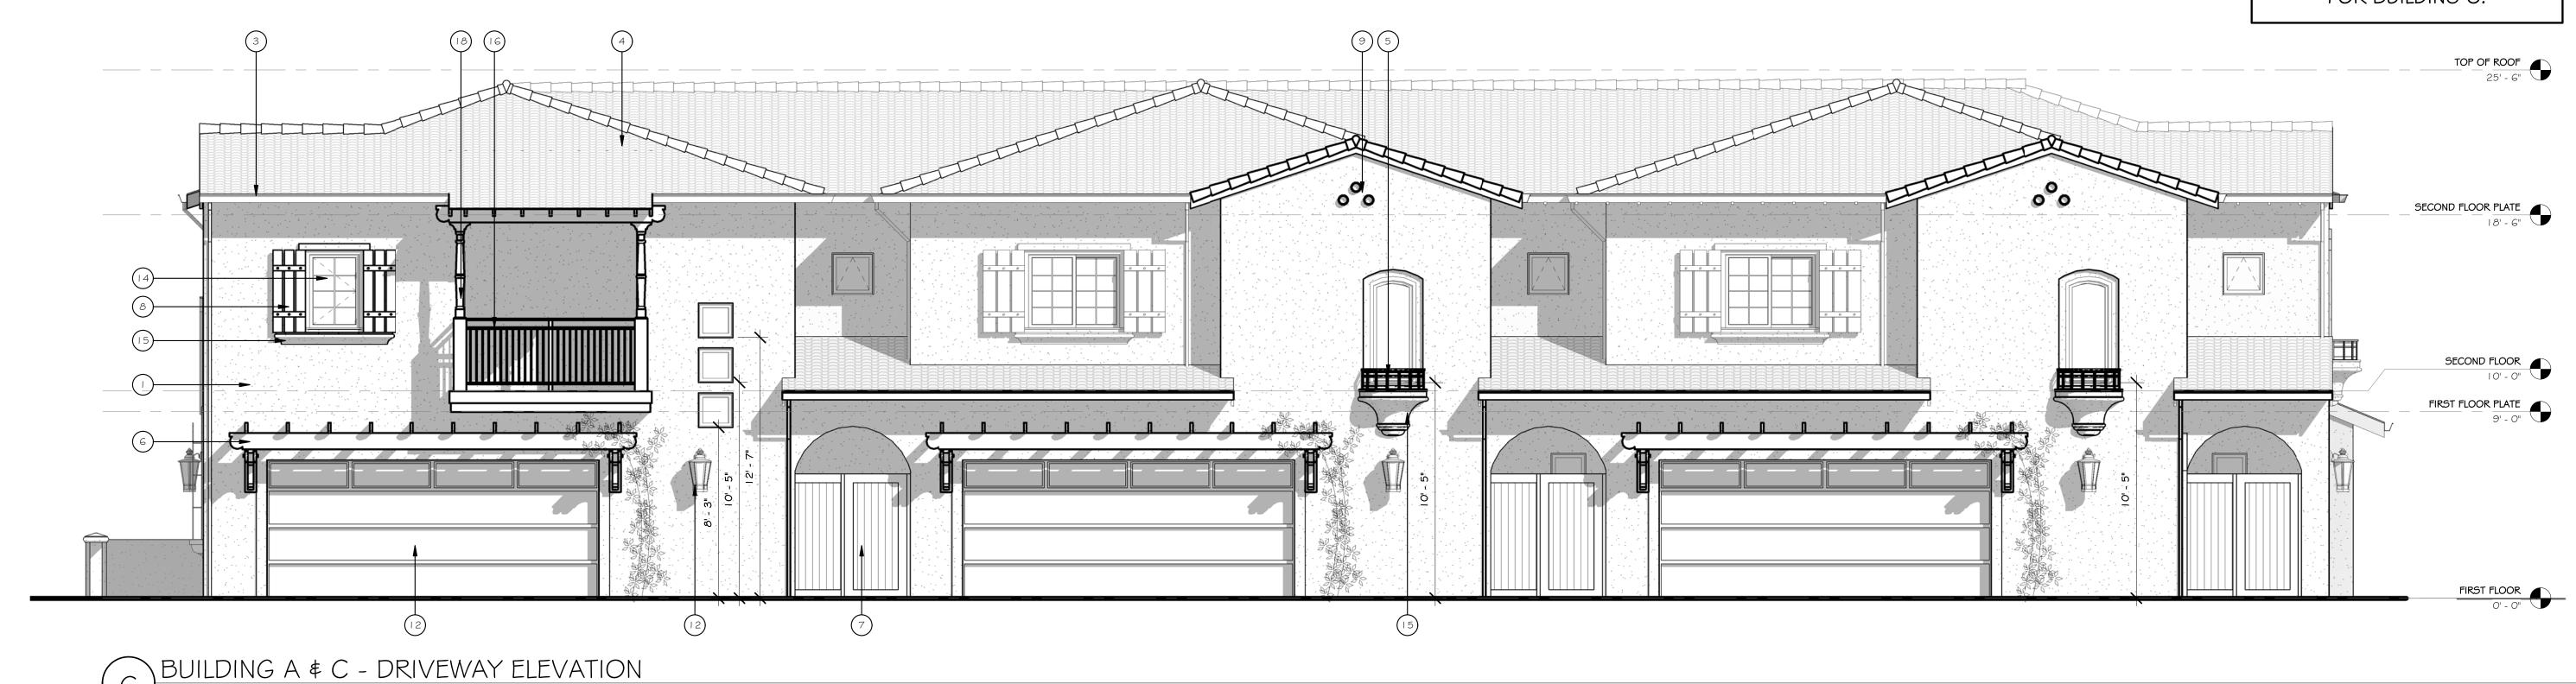

THIS ELEVATION DEPICTS BUILDING A ONLY. ELEVATION IS MIRRORED FOR BUILDING C. (1) (9)TOP OF ROOF ROOF DECK SECOND FLOOR PLATE SECOND FLOOR FIRST FLOOR PLATE
9' - O" FIRST FLOOR

EXTERIOR MATERIALS

- OMEGA STUCCO 16/30 FINISH O/ METAL LATH. COLOR #10 (OR APPROVED EQUAL)
- WOOD TRIM W/ PAINT FINISH.
 COLOR: DUNN EDWARDS WILD MUSTANG (DEA | 6 |)
- PRE-FINISHED 5" ALUMINUM OGEE STYLE RAIN GUTTER W/ 2"X3" DOWNSPOUTS AND COLLECTOR BOX. COLOR: BROWN
- EAGLE STANDARD WEIGHT ROOFING TILES STYLE: MALIBU
 - COLOR: KONA RED RANGE
- OR APPROVED EQUAL

8 SHUTTERS - HENNIS ENTERPRISES
LOUVERED WITH TRIM (OR APPROV

- TUBE STEEL METALWORK COLOR: DUNN EDWARDS - BLACK BEAN(DE6385)
- WOOD FRAMED TRELLIS WITH PAINT FINISH. COLOR: DUNN EDWARDS - WILD MUSTANG (DEA | 6 |)
- COUNTRY ESTATE FENCE; MODEL: LAKELAND COLOR: ALMOND STREAK (OR APPORVED EQUAL)

LOUVERED WITH TRIM (OR APPROVED EQUAL)

PAINT FINISH.; COLOR: DUNN EDWARDS - BLUE STEEL (DEG342)

PREFENISHED SECTIONAL METAL GARAGE DOOR.
COLOR: BROWN WOOD CORBEL W/ PAINT FINISH
COLOR: DUNN EDWARDS - WILD MUSTANG (DEA | 6 |)

(II) WALL SCONCE

- VINYL WINDOWS
 COLOR: TAN (TYPICAL)
- FOAM PROFILE WITH STUCCO FINISH FOAM PROFILE WITH STOCKS (15) COLOR TO MATCH BUILDING

WOOD FRAMED COLUMN W/ STUCCO FINISH.
COLOR TO MATCH BUILDING

- 42" HIGH TUBE STEEL GUARDRAIL
 COLOR: DUNN EDWARDS BLACK BEAN(DEG385)
- (17) WOOD PROFILE WITH STUCCO FINISH
- TURN POST DETAIL WITH PAIN FINISH
 COLOR: DUNN EDWARDS WILD MUSTANG (DEA | 6 |)

BUILDING A & C - EAST ELEVATION

SCALE: 1/4" = 1'-0"

DESIGN CONCEPT STUDIO

2844 E. THIRD STREET #204 • LONG BEACH, CA • 90814

SCALE: 1/4" = 1'-0"

These drawings are rendered as inturuments of service and are the intelectual property of the designer.

WHITE AVENUE 12-UNIT

WF Feron LLC

1452 WHITE AVENUE POMONA, CA • APN:8343-008-020

REVISIONS PROJECT NO. 11810-14 DRAWN BY 6/21/2017 9:41:47 PM


ELEVATION IS MIRRORED FOR BUILDING D. TOP OF ROOF 25' - 6" SECOND FLOOR PLATE SECOND FLOOR FIRST FLOOR PLATE 9' - 0"

EXTERIOR MATERIALS

- OMEGA STUCCO 16/30 FINISH O/ METAL LATH. COLOR #10 (OR APPROVED EQUAL)
- WOOD TRIM W/ PAINT FINISH.
 COLOR: DUNN EDWARDS WILD MUSTANG (DEA | 6 |)
- PRE-FINISHED 5" ALUMINUM OGEE STYLE RAIN GUTTER W/ 2"X3" DOWNSPOUTS AND COLLECTOR BOX.
- EAGLE STANDARD WEIGHT ROOFING TILES STYLE: MALIBU COLOR:
- VALENCIA KONA RED RANGE OR APPROVED EQUAL
- TUBE STEEL METALWORK COLOR: DUNN EDWARDS - BLACK BEAN(DE6385)
- WOOD FRAMED TRELLIS WITH PAINT FINISH. COLOR: DUNN EDWARDS - WILD MUSTANG (DEA | 6 |)
- COUNTRY ESTATE FENCE; MODEL: LAKELAND COLOR: ALMOND STREAK (OR APPORVED EQUAL)
- 8 SHUTTERS HENNIS ENTERPRISES LOUVERED WITH TRIM (OR APPROVED EQUAL) PAINT FINISH.; COLOR: DUNN EDWARDS - BLUE STEEL (DE6342)

- WOOD FRAMED COLUMN W/ STUCCO FINISH.
 COLOR TO MATCH BUILDING
- (II) WALL SCONCE
- PREFENISHED SECTIONAL METAL GARAGE DOOR.
 COLOR: BROWN
- WOOD CORBEL W/ PAINT FINISH
 COLOR: DUNN EDWARDS WILD MUSTANG (DEA | 6 |)
- VINYL WINDOWS
 COLOR: TAN (TYPICAL)
- FOAM PROFILE WITH STUCCO FINISH COLOR TO MATCH BUILDING
- 42" HIGH TUBE STEEL GUARDRAIL COLOR: DUNN EDWARDS BLACK BEAN(DEG385)
- WOOD PROFILE WITH STUCCO FINISH
- TURN POST DETAIL WITH PAIN FINISH
 COLOR: DUNN EDWARDS WILD MUSTANG (DEA | 6 |)

THIS ELEVATION DEPICTS BUILDING B ONLY. ELEVATION IS MIRRORED FOR BUILDING D.

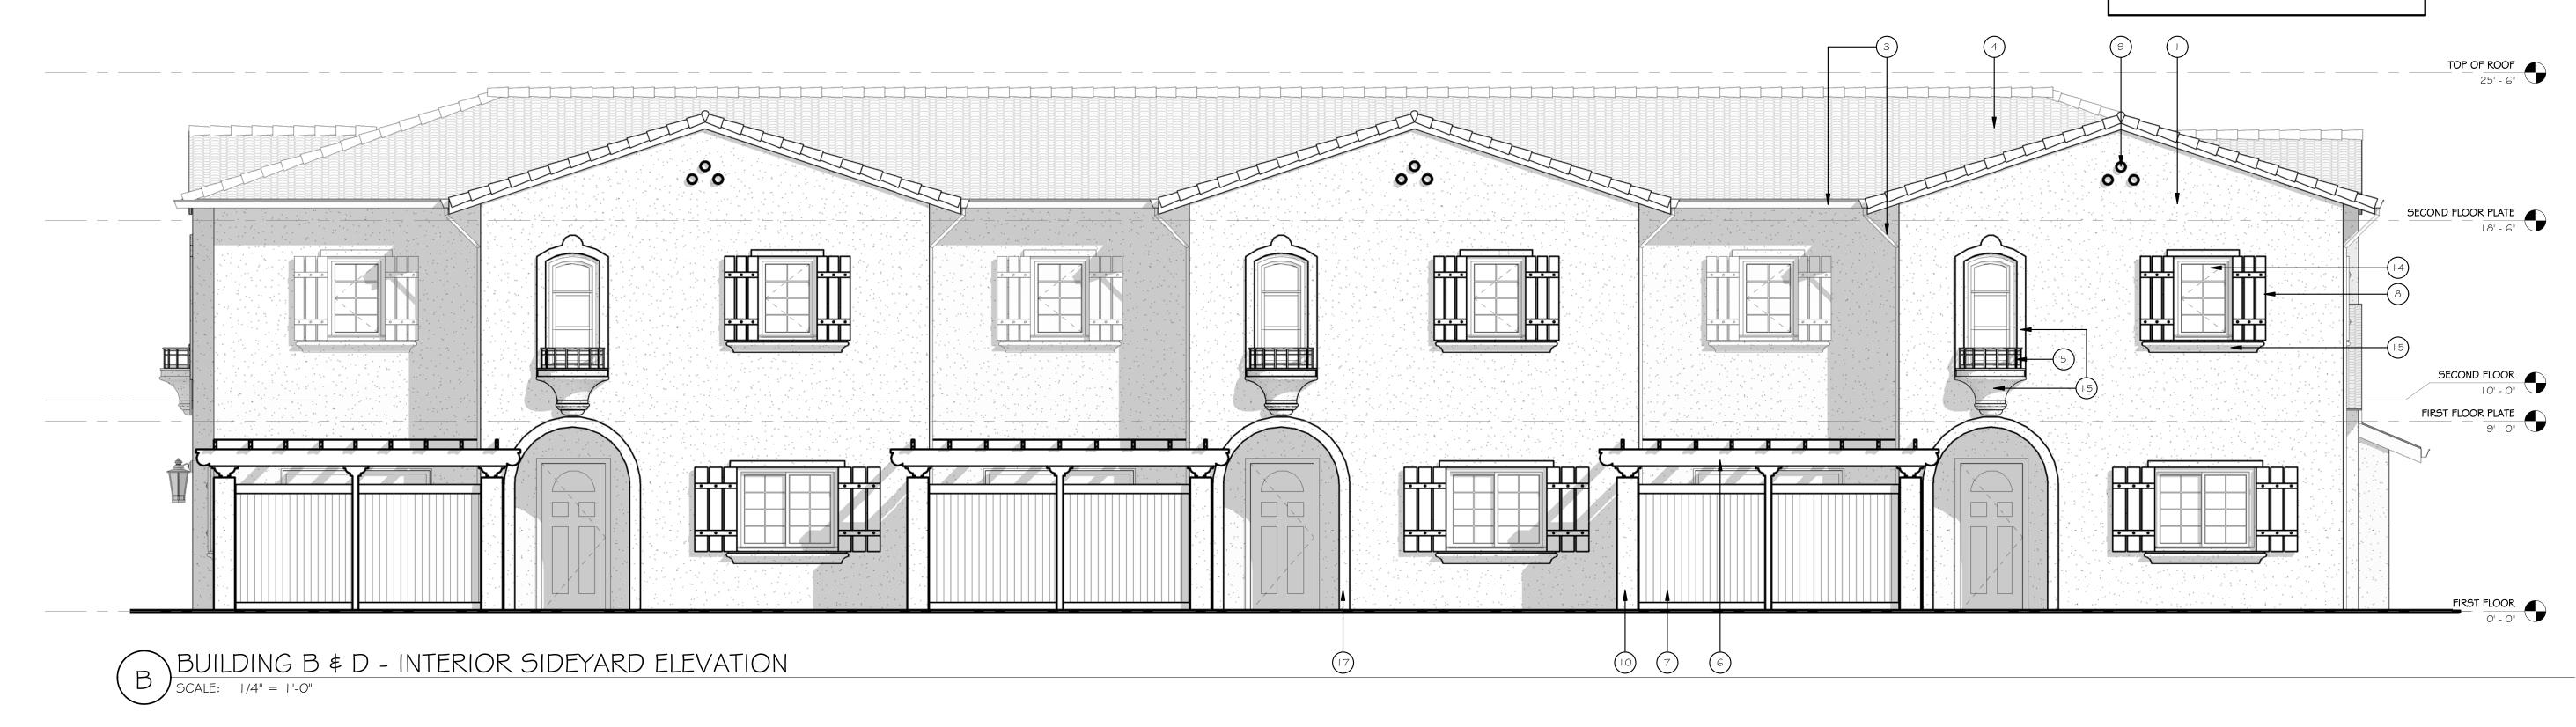

FIRST FLOOR
O' - O"

THIS ELEVATION DEPICTS

BUILDING B ONLY.

DESIGN CONCEPT STUDIO

BUILDING B & D - WEST ELEVATION

SCALE: 1/4" = 1'-0"

2844 E. THIRD STREET #204 • LONG BEACH, CA • 90814

These drawings are rendered as inturuments of service and are the intelectual property of the designer.


WHITE AVENUE 12-UNIT


WF Feron LLC

1452 WHITE AVENUE POMONA, CA • APN:8343-008-020

PROJECT NO. REVISIONS

THIS ELEVATION DEPICTS BUILDING B ONLY. ELEVATION IS MIRRORED FOR BUILDING D.

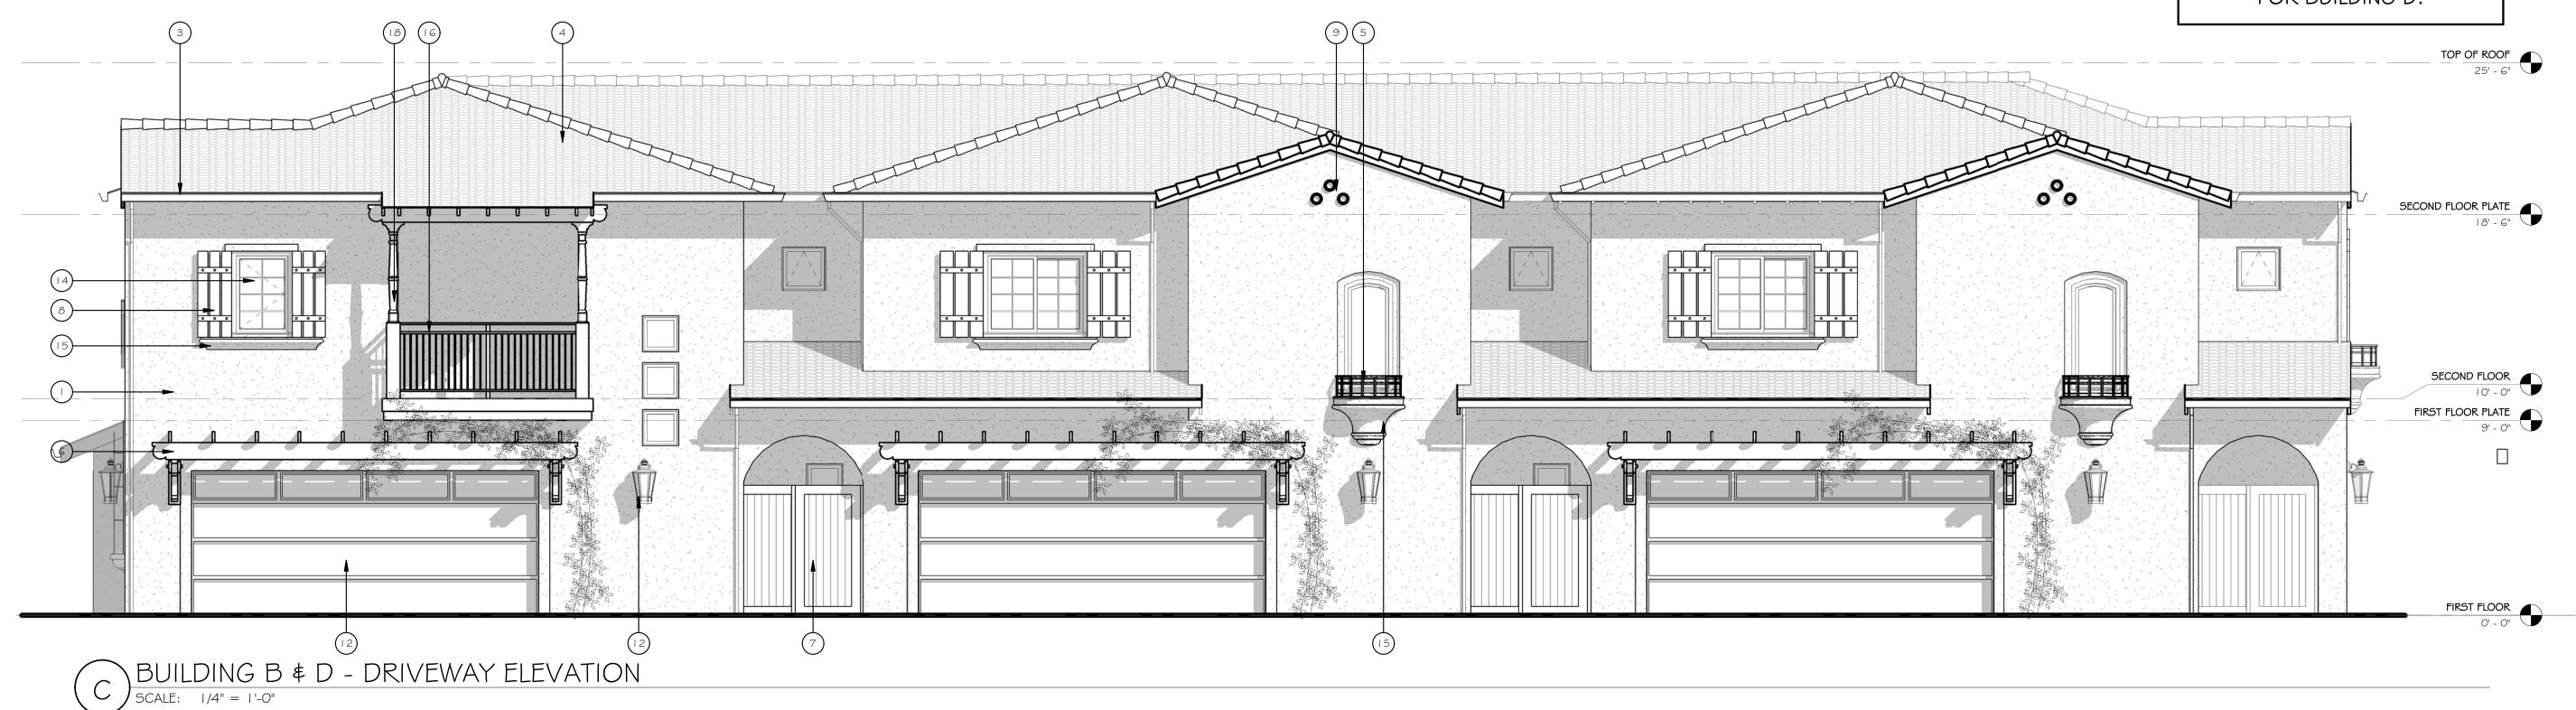

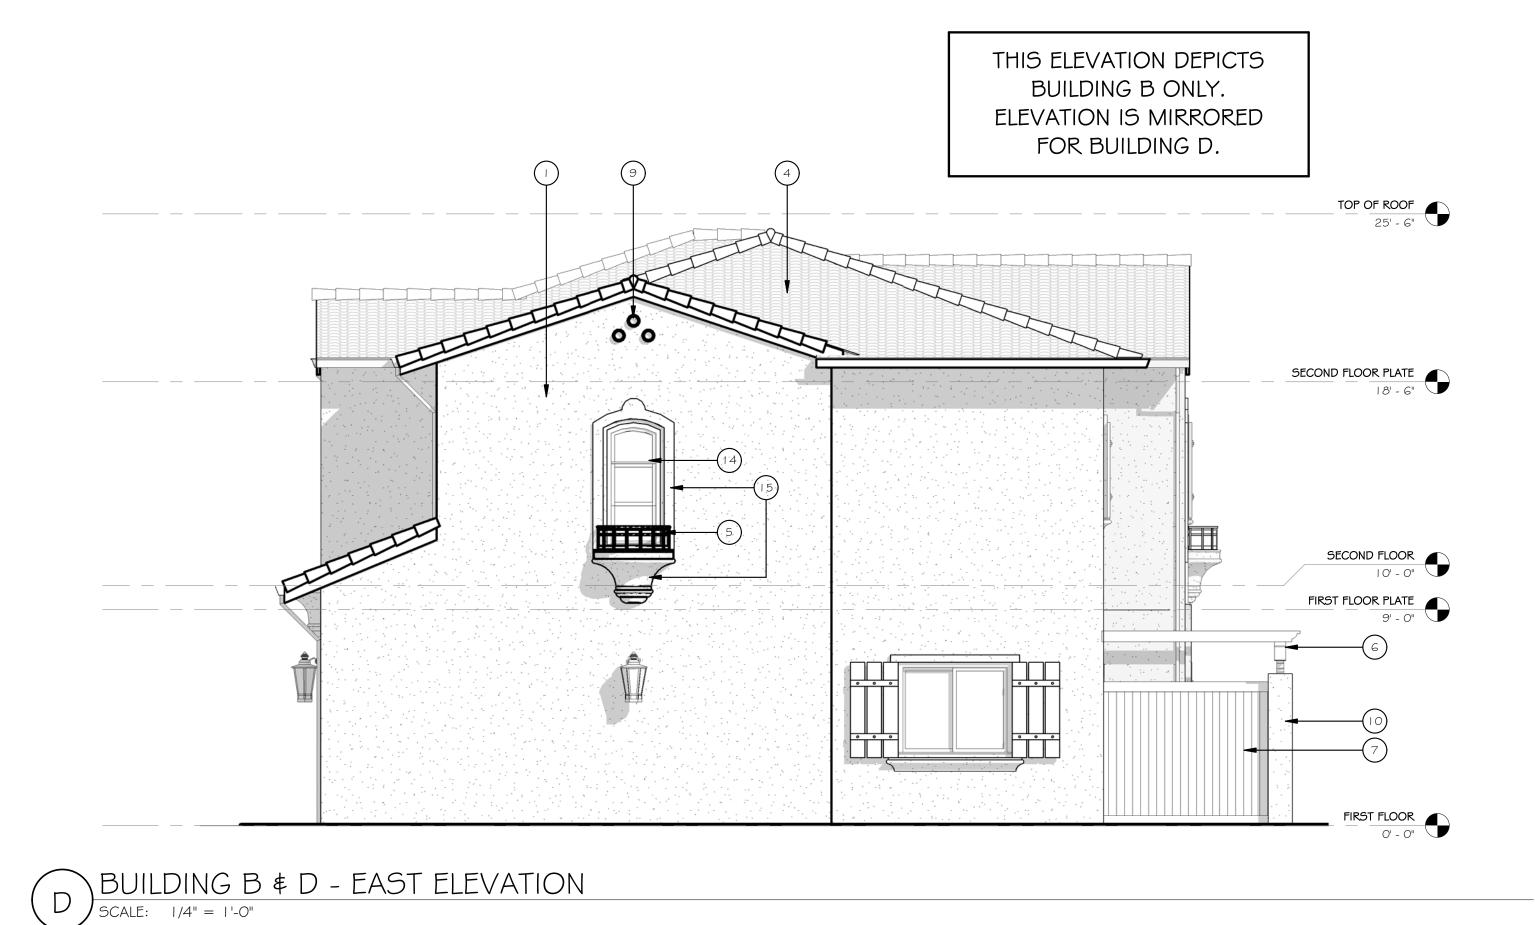

EXTERIOR MATERIALS

- OMEGA STUCCO I 6/30 FINISH O/ METAL LATH. COLOR #10 (OR APPROVED EQUAL)
- WOOD TRIM W/ PAINT FINISH.
 COLOR: DUNN EDWARDS WILD MUSTANG (DEA I G I)
- PRE-FINISHED 5" ALUMINUM OGEE STYLE RAIN GUTTER W/ 2"X3" DOWNSPOUTS AND COLLECTOR BOX.
- EAGLE STANDARD WEIGHT ROOFING TILES STYLE: MALIBU
- COLOR: VALENCIA
- KONA RED RANGE OR APPROVED EQUAL
- TUBE STEEL METALWORK COLOR: DUNN EDWARDS - BLACK BEAN(DEG385)
- WOOD FRAMED TRELLIS WITH PAINT FINISH. COLOR: DUNN EDWARDS - WILD MUSTANG (DEA | 6 |)
- 6' VINYL FENCE COUNTRY ESTATE FENCE; MODEL: LAKELAND
- COLOR: ALMOND STREAK (OR APPORVED EQUAL) SHUTTERS - HENNIS ENTERPRISES LOUVERED WITH TRIM (OR APPROVED EQUAL)

PAINT FINISH.; COLOR: DUNN EDWARDS - BLUE STEEL (DE6342)

- 9 CLAY PIPE
- WOOD FRAMED COLUMN W/ STUCCO FINISH.
 COLOR TO MATCH BUILDING
- WALL SCONCE
- PREFENISHED SECTIONAL METAL GARAGE DOOR.
 COLOR: BROWN
- WOOD CORBEL W/ PAINT FINISH
 COLOR: DUNN EDWARDS WILD MUSTANG (DEA 1 6 1)
- VINYL WINDOWS
 COLOR: TAN (TYPICAL)
- FOAM PROFILE WITH STUCCO FINISH COLOR TO MATCH BUILDING
- 42" HIGH TUBE STEEL GUARDRAIL
 COLOR: DUNN EDWARDS BLACK BEAN(DE6385)
- WOOD PROFILE WITH STUCCO FINISH
- TURN POST DETAIL WITH PAIN FINISH TURN POST DETAIL WITH PAIN FINISH
 COLOR: DUNN EDWARDS - WILD MUSTANG (DEA I 6 I)

DESIGN CONCEPT STUDIO

2844 E. THIRD STREET #204 • LONG BEACH, CA • 90814

These drawings are rendered as inturuments of service and are the intelectual property of the designer.

WHITE AVENUE 12-UNIT

WF Feron LLC

1452 WHITE AVENUE POMONA, CA • APN:8343-008-020

REVISIONS PROJECT NO. 11810-14 DRAWN BY 6/21/2017 9:42:15 PM

2844 E. THIRD STREET #204 • LONG BEACH, CA • 90814

These drawings are rendered as inturuments of service and are the intelectual property of the designer.

WHITE AVENUE 12-UNIT

WF Feron LLC

1452 WHITE AVENUE POMONA, CA • APN:8343-008-020

WINDOW SCHEDULE

	SIZE							
NO.	WIDTH	HEIGHT	STYLE	TYPE	GLAZING	MATERIAL	COLOR	COMMENTS
А	4' - 6"	3' - 8"	SLIDER			VINYL	TAN	
В	2' - 0"	3' - 0"	SINGLE HUNG		TEMPERED	VINYL	TAN	
С	2' - 0"	4' - 0"	SINGLE HUNG			VINYL	TAN	
D	1' - 8"	4' - 0"	CASEMENT			VINYL	TAN	
E	2' - 6"	3' - 8"	CASEMENT			VINYL	TAN	EGRESS
F	2' - 0"	2' - 0"	AWNING			VINYL	TAN	
G	2' - 0"	5' - 0"	FIXED ARCHTOP			VINYL	TAN	
Н	2' - 0"	5' - 0"	SINGLE HUNG ARCHTOP			VINYL	TAN	
J	1' - 8"	1' - 8"	FIXED			VINYL	TAN	
М	2' - 0"	3' - 6"	SINGLE HUNG			VINYL	TAN	

DOOR SCHEDULE


NO.	WIDTH	HEIGHT	STYLE	COMMENTS
	_			
101	16' - 0"	6' - 8"	SECTIONAL GARAGE DOOR	REMOTE OPERATED
102	7' - 0"	6' - 8"	SLIDING GLASS	
103	3' - 0"	6' - 8"	HINGED PANEL	
104	2' - 8"	6' - 8"	HINGED PANEL	
105	2' - 8"	6' - 8"	HINGED PANEL	SELF-CLOSING, 20-MIN DOOR
106	3' - 0"	6' - 8"	HINGED PANEL	SELF-CLOSING, 20-MIN DOOR
107	3' - 0"	6' - 8"	HINGED PANEL	
108	2' - 8"	6' - 8"	POCKET	
109	6' - 0"	6' - 8"	WARDROBE BYPASS	
110	2' - 8"	6' - 8"	HINGED PANEL	100 SQ. IN. OF VENTILATION
111	3' - 0"	6' - 8"	HINGED PANEL	
112	5' - 8"	6' - 8"	DOUBLE METAL DOOR	
113	5' - 0"	6' - 8"	DOUBLE METAL DOOR	

PROJECT NO. 11810-14

DRAWN BY Author

DATE 6/21/2017 9:42:16 PM

A - 4 O O

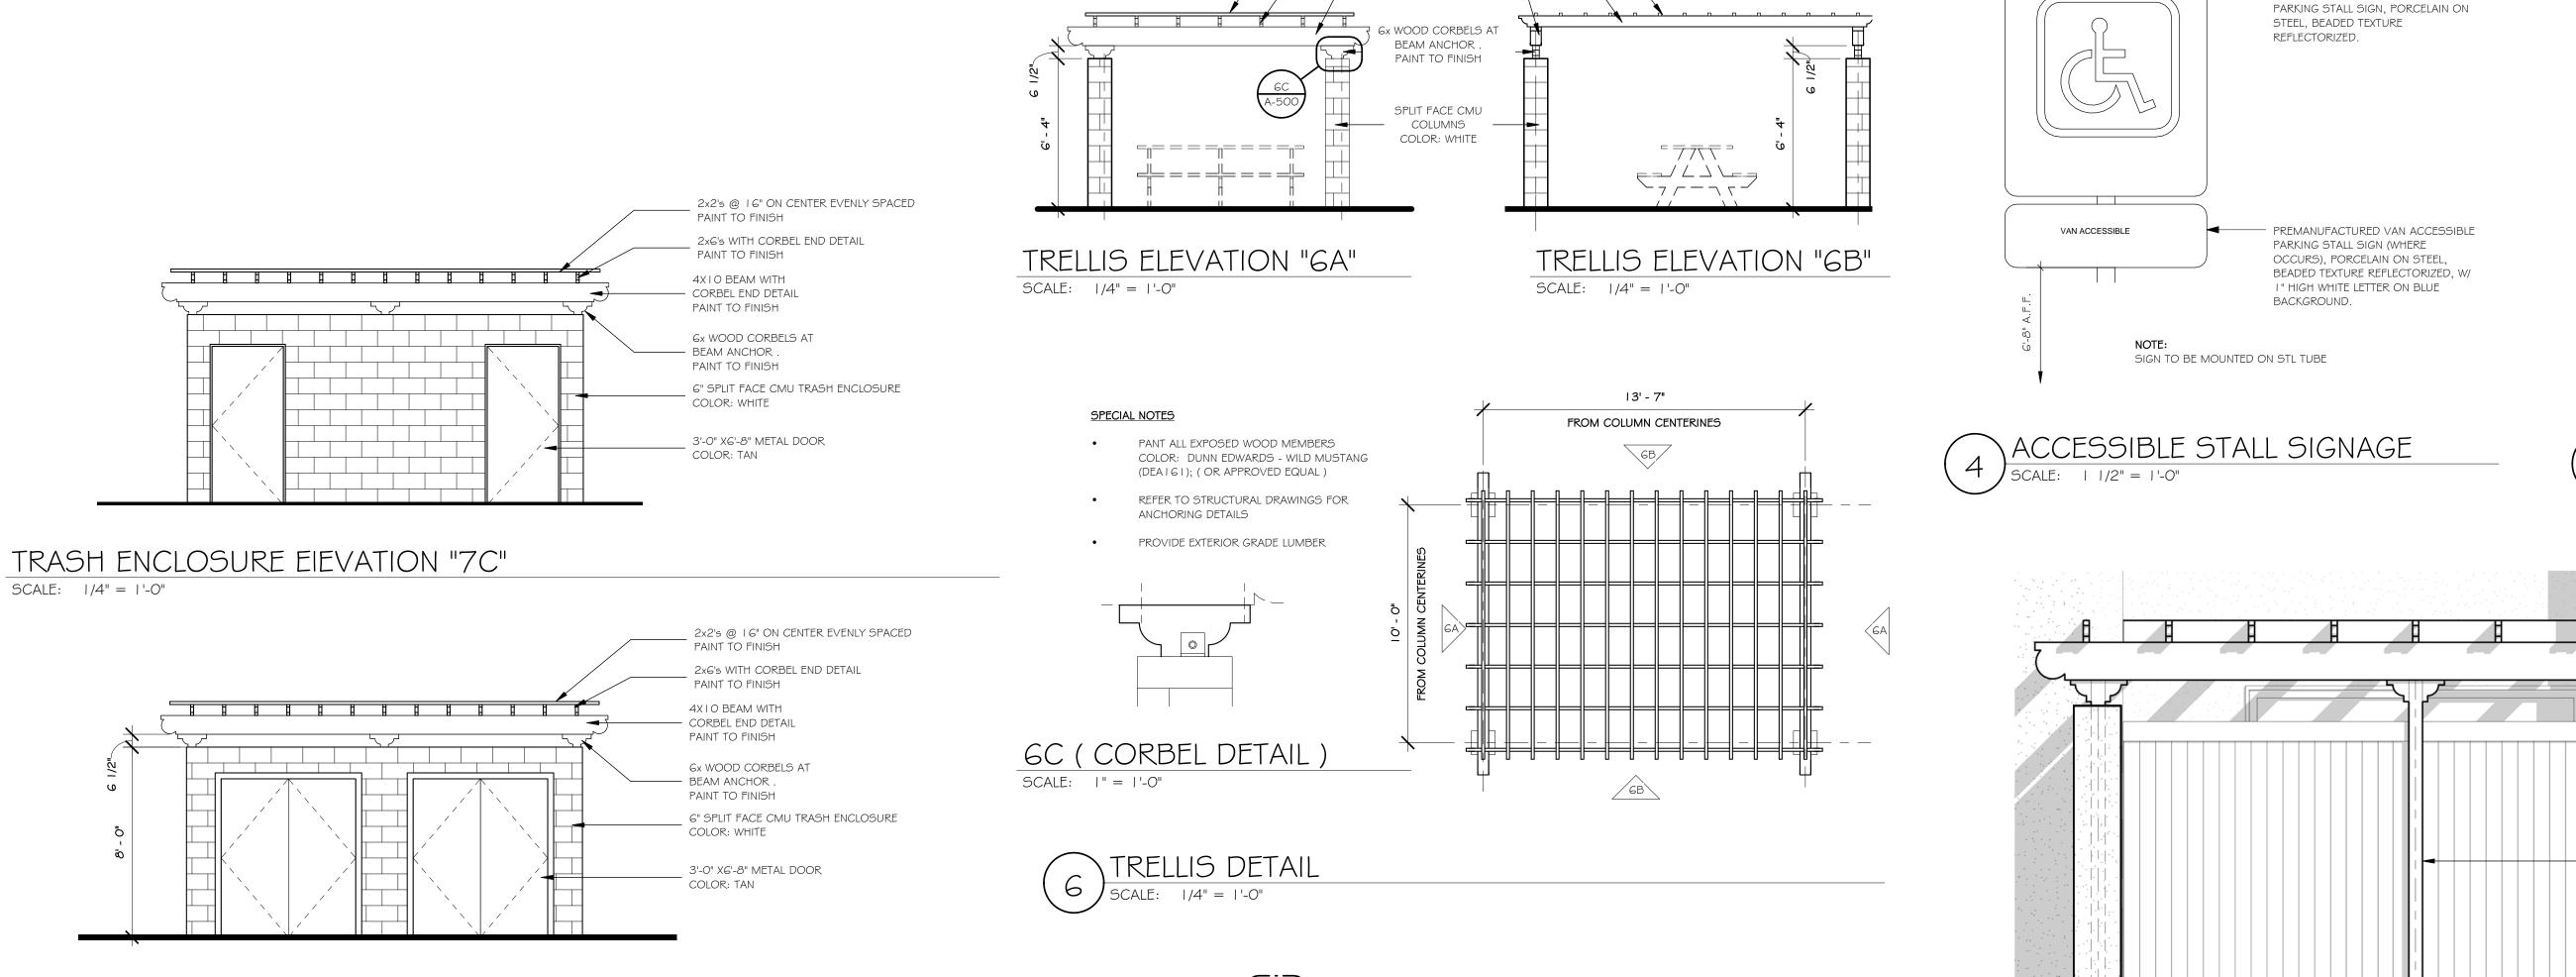


Ix's @ 12" MIN EVENLY SPACED _ PAINT TO FINISH

2x6's WITH CORBEL END DETAIL PAINT TO FINISH

4XIO BEAM WITH

CORBEL END DETAIL PAINT TO FINISH

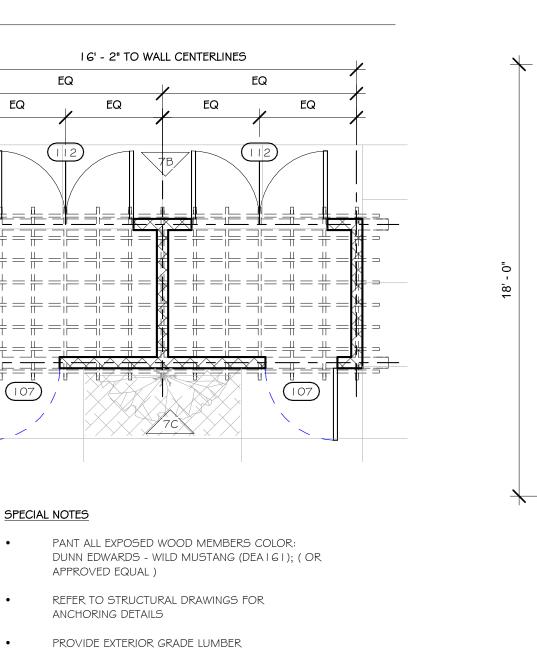


16' - 2" TO WALL CENTERLINES


SPECIAL NOTES

APPROVED EQUAL)

REFER TO STRUCTURAL DRAWINGS FOR

PROVIDE EXTERIOR GRADE LUMBER

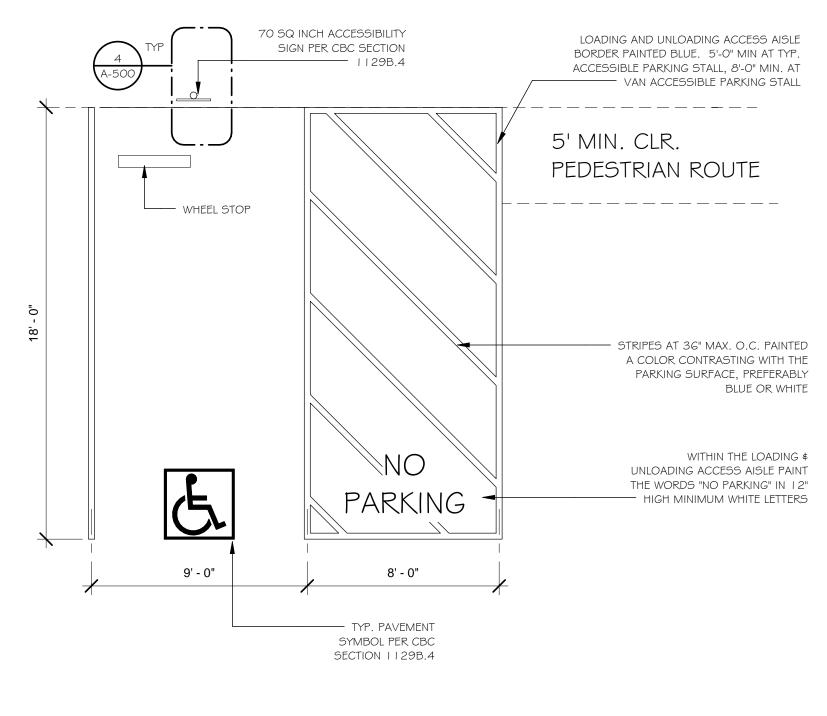

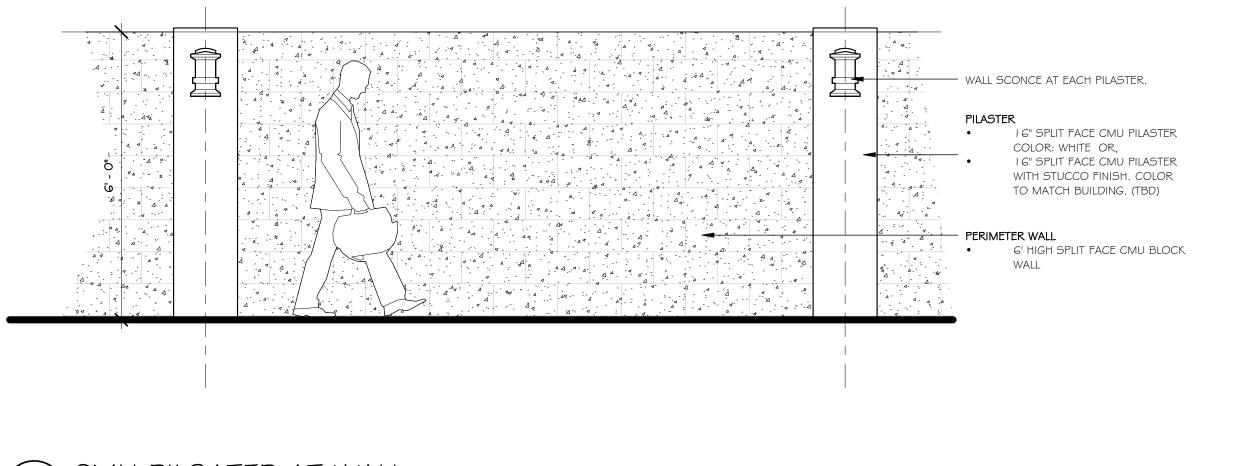

PER PLAN

PREMANUFACTURED ACCESSIBLE

PRIVATE PATIO FENCE





DESIGN CONCEPT STUDIO

TRASH ENCLOSURE ELEVATION "7B"

TRASH ENCLOSURE ELEVATION "7A"

TRASH ENCLOSURE PLAN

SCALE: 1/4" = 1'-0"

SCALE: 1/4" = 1'-0"

2844 E. THIRD STREET #204 • LONG BEACH, CA • 90814

These drawings are rendered as inturuments of service and are the intelectual property of the designer.

WHITE AVENUE 12-UNIT

WF Feron LLC

1452 WHITE AVENUE POMONA, CA • APN:8343-008-020

REVISIONS PROJECT NO. 11810-14 DRAWN BY 6/21/2017 9:42:22 PM

2x WOOD FRAMED COLUMN BASE

(SEE PLANS)

— 1/2" DIA. x10" A.B.

POST WHERE OCCURS

- 2x4 P.T.D.F. SILL PLATE

STUCCO OR VENEER

--- 2x4 P.T.D.F. SILL PLATE --- STUCCO SCREED

- SEE ELEVS.

— 1/2" DIA. x10" A.B.

CONCRETE DECK

PER STRUCTURAL

4x6 LEDGED LAGBOLTED TO WALL WITH

- PAINT TO FINISH ; REFER TO ELEVATIONS

GX I O BEAM WITH CORBEL END DETAIL PAINT TO FINISH; REFER TO ELEVATIONS

COLOR AND FINISH TO MATCH BUILDING

COUNTRY ESTATE FENCE; MODEL: LAKELAND COLOR: ALMOND STREAK (OR APPORVED EQUAL) RETURN BACK TO WALL WHERE OCCURS PER FENCE PLAN

REFER TO ELEVATIONS FOR COLORS

PANT ALL EXPOSED WOOD MEMBERS

COLOR: DUNN EDWARDS - WILD MUSTANG (DEA I 6 I);

I'FT. SQ. WOOD FRAMED COLUMN WITH STUCCO FINISH

G.I. METAL WATER TABLE

ELEVATIONS

PAINT TO FINISH; REFER TO

2X6's WITH CORBEL END DETAIL

2X6 WOOD CORBELS AT POST PARALLEL TO BEAM (TYPICAL AT POSTS)

- POST PER STRUCTURAL

4x POST; PAINT TO FINISH

(OR APPROVED EQUAL)

SEE PLANS

PRIVATE ENGINEER'S NOTICE TO CONTRACTORS:

THE EXISTENCE AND APPROXIMATE LOCATION OF UNDERGROUND UTILITIES OR STRUCTURES SHOWN ON THESE PLANS WERE DETERMINED BY A SEARCH OF THE AVAILABLE PUBLIC RECORDS. TO THE BEST OF OUR KNOWLEDGE THERE ARE NO EXISTING UNDERGROUND UTILITIES OR STRUCTURES EXCEPT AS SHOWN ON PLAN THE CONTRACTOR IS REQUIRED TO TAKE DUE PRECAUTIONARY MEASURES TO PROTECT THE UTILITIES OR STRUCTURES SHOWN AND ANY OTHER UTILITIES OR STRUCTURES NOT OF RECORD OR NOT SHOWN ON THESE PLANS. ESTIMATED PROJECT START DATE: 12/01/17 ESTIMATED COMPLETION DATE: 12/01/18

GENERAL NOTES

- A. SUPERVISION OF CONSTRUCTION SHOWN ON THIS PLAN, INCLUDING GRADES. EARTHWORK OPERATION, PAVING AND DRAINAGE FACILITIES, WILL BE PERFORMED BY__ GRADING PERMIT AND THE APPROVED GRADING PLAN SHALL BE MAINTAINED AT THE SITE AT ALL TIMES WHEN WORK IS IN
- B. PROVISIONS SHALL BE MADE FOR CONTRIBUTORY DRAINAGE AT ALL TIMES. THE SOILS ENGINEER SHALL OBSERVE, INSPECT AND TEST ALL EARTHWORK OPERATIONS INCLUDING, BUT NOT LIMITED TO, CLEARING AND GRUBBING, SUBGRADE PREPARATION, STRUCTURAL AND TRENCH EXCAVATION AND BACKFILL, AND PLACEMENT AND COMPACTION OF FILL.
- D. AFTER COMPLETION OF THE GRADING OPERATION, AND PRIOR TO REQUEST FOR FINAL INSPECTION THE SOILS ENGINEER SHALL SUBMIT TO THE REGISTERED CIVIL ENGINEER OF RECORD. A COPY OF DENSITY REPORTS, TOGETHER WITH HIS WRITTEN VERIFICATION THAT THE COMPLETED WORK CONFORMS TO THE INTENT OF THE PLANS, SPECIFICATIONS.
- E. ALL FILL SLOPE FACES SHALL BE COMPACTED. IF THE SLOPE IS TO BE LANDSCAPED, THE SURFACE SIX INCHES MAY BE LEFT UNCOMPACTED FOR PLANTING. AND SAFETY.
- CONTRACTOR SHALL PROVIDE PROTECTIVE MEASURES AND TEMPORARY DRAINAGE AND DESILTING FACILITIES TO PROTECT ADJOINING PROPERTIES FROM STORM WATERS ORIGINATING ON OR DIVERTED FROM CONSTRUCTION SITE.
- G. GRADE SHEETS FOR ALL CONCRETE CURB AND GUTTERS. CURBS. "V" GUTTERS, SLABS, STORM DRAINS AND SEWERS SHALL BE PREPARED BY THE ENGINEER OF RECORD. COPIES OF THE GRADE SHEETS SHALL BE MAINTAINED AT THE JOB SITE FOR THE CITY ENGINEER'S REVIEW. H. GRADE STAKES SHALL BE SET AT 12.5' INTERVALS FOR ALL "V"
- GUTTERS, CURB AND GUTTER, AND DRAINAGE SYSTEMS WITH FLOW LINE SLOPES OF LESS THAN 0.4%. CONTRACTOR SHALL PROVIDE GRADE SHEETS TO CITY ENGINEER'S OFFICE FOR ACCEPTANCE 48 HOURS PRIOR TO POURING CONCRETE.
- FXISTING CONTOURS AND OTHER EXISTING TOPOGRAPHIC FEATURES ARE A TRUE REPRESENTATION OF SITE CONDITION ON_____ PROVIDED BY _____AL_THELWELL, LS 6999
- THE CONTRACTOR SHALL KEEP ALL ADJACENT STREETS AND HAUL ROUTES CLEAR OF DIRT AND DEBRIS ORIGINATING FROM THE CONSTRUCTION SITE OR RESULTING FROM THE PROJECT WORK. K. THE CONTRACTOR WILL BE RESPONSIBLE FOR MAINTAINING LOW LEVELS
- OF NOISE AND DUST. L. THE CONTRACTOR SHALL SECURE ALL NECESSARY EXCAVATION AND CONSTRUCTION PERMITS FROM THE CITY OF POMONA FOR ALL WORK
- WITHIN THE PUBLIC RIGHT-OF-WAY AND ASSOCIATED EASEMENTS. M. RETAINING WALLS REQUIRE A SEPARATE BUILDING PERMIT. N. ANY MODIFICATIONS OF OR CHANGES TO THIS PLAN MUST BE APPROVED BY THE CITY ENGINEER PRIOR TO THE INSTITUTION OF SAID
- MODIFICATION OR CHANGE. O. THE REGISTERED CIVIL ENGINEER OF RECORD CERTIFIES THAT HIS PLAN WAS PREPARED UNDER HIS SUPERVISION AND THAT THE PLAN DOES COMPLY WITH CITY OF POMONA ORDINANCES. HE WILL, UPON COMPLETION OF THE PROJECT AND PRIOR TO REQUEST FOR FINAL ACCEPTANCE, SUBMIT TO THE CITY ENGINEER WRITTEN VERIFICATION
- P. ALL WORK WITHIN STREET RIGHT-OF-WAY SHALL BE DONE IN ACCORDANCE WITH THE CITY OF POMONA'S STANDARDS AND SPECIFICATIONS. Q. ALL EXISTING P.C.C. TO BE REMOVED SHALL BE SAW-CUT. R. ALL INTERFERING UTILITIES SHALL BE RELOCATED AT THE DEVELOPER'S EXPENSE.

THAT THE COMPLETED WORK DOES CONFORM TO THIS PLAN.

S. OBTAIN SEWER PERMIT FROM THE ENGINEERIING DIVISION PRIOR TO CONNECTION TO THE CITY SEWER MAIN LINE. NOTE: SEWER PERMITS CAN NOT BE ISSUED UNTILL THE DEVELOPER HAS PAID ALL FEES

REQUIRED BY THE COUNTY SANITATION DISTRICT NO. 21 OF LOS ANGELES COUNTY, AND PRESENTS A RECEIPT TO THE ENGINEERING DIVISION AT THE TIME PERMITS ARE REQUESTED

STANDARD GRADING NOTES

1. ALL WORK SHALL BE IN ACCORDANCE WITH THE CITY OF POMONA ORDINANCE NO. 3444 AND THE LATEST STATE CODES AS MANDATED TO BE ENFORCED BY THE CITY AND STANDARD SPECIFICATIONS FOR PUBLIC WORKS CONSTRUCTION, LATEST EDITION, PLUS ANY SUPPLEMENTS. ** A BOND IS REQUIRED PER SECTION 3311 OF UNIFORM BUILDING CODE 2. AN APPROVED SET OF PLANS SHALL BE ON THE JOB AT ALL TIMES. 3. NO WORK SHALL BE STARTED WITHOUT FIRST NOTIFYING THE BUILDING DIVISION AT

4. ADEQUATE BARRICADES, LIGHTS, FLAGMEN, SIGNS AND OTHER SAFETY DEVICES SHALL BE PROVIDED AS SPECIFIED BY THE TRAFFIC MANUAL PUBLISHED BY THE STATE OF CALIFORNIA DEPARTMENT OF TRANSPORTATION.

5. EXISTING CITY STREETS SHALL BE KEPT CLEAN OF ALL MATERIALS RESULTING FROM THE GRADING OPERATIONS. THE STREET RIGHT-OF-WAY SHALL BE CLEANED UP DAILY AND AS NECESSARY TO MAINTAIN PEDESTRIAN AND VEHICULAR PASSAGE OVER THE PUBLIC RIGHT-OF-WAY AT ALL TIMES. 6. THE PERMITTEE OR HIS AGENT SHALL NOTIFY THE BUILDING OFFICIAL AT LEAST 24 HOURS BEFORE THE GRADING OPERATION IS READY FOR EACH OF THE FOLLOWING: a. PRE-GRADE MEETING: WHEN THE PERMITTEE IS READY TO BEGIN WORK AND BEFORE ANY GRADING OR BRUSHING IS STARTED. THE FOLLOWING PEOPLE MUST BE PRESENT — OWNER, GRADING CONTRACTOR, DESIGN CIVIL ENGINEER, SOILS ENGINEER, GEOLOGIST, BUILDING OFFICIAL OR THEIR REPRESENTATIVE. b. Toe inspection: After the natural ground is exposed and PREPARED TO RECEIVE FILL AND BEFORE ANY FILL IS PLACED. c. EXCAVATION INSPECTION: AFTER THE EXCAVATION IS STARTED AND BEFORE THE DEPTH OF EXCAVATION EXCEEDS 10 FEET. d. FILL INSPECTION: AFTER THE AREA TO RECEIVE FILL HAS BEEN PREPARED AND INSPECTED BY THE SOILS ENGINEER. e. DRAINAGE DEVICE INSPECTION: AFTER FORMS, STEEL AND PIPE ARE IN PLACE, AND BEFORE ANDY CONCRETE IS POURED. f. ROUGH GRADING: WHEN ALL ROUGH GRADING HAS BEEN COMPLETED. . FINAL INSPECTION: WHEN ALL WORK, INCLUDING INSTALLATION OF ALL DRAINAGE STRUCTURES AND OTHER PROTECTIVE DEVICES HAS BEEN COMPLETED AND THE "AS-GRADED" PLAN AND REQUIRED REPORTS HAVE BEEN SUBMITTED AND APPROVED.

THE PERMITTEE SHALL WAIT FOR APPROVAL BY THE INSPECTOR BEFORE PROCEEDING WITH THE WORK.

7. SUFFICIENT TESTS OF SOIL PROPERTIES, INCLUDING SOIL TYPES AND SHEAR STRENGTH SHALL BE MADE DURING THE GRADING OPERATIONS TO VERIFY COMPLIANCE WITH DESIGN CRITERIA. THE RESULTS OF SUCH TESTING SHALL BE FURNISHED TO THE BUILDING OFFICIAL UPON COMPLETION OF GRADING OPERATIONS OR WHEN NECESSITATED BY FIELD CONDITIONS UPON REQUEST OF THE BUILDING OFFICIAL. 8. THE GRADING CONTRACTOR SHALL SUBMIT A WRITTEN STATEMENT VERIFYING THAT WORK DONE UNDER HIS DIRECTION WAS PERFORMED IN ACCORDANCE WITH THE APPROVED PLANS AND REQUIREMENTS OF CHAPTER 33 OF THE UNIFORM BUILDING CODE OR DESCRIBING ALL VARIANCES FROM THE APPROVED PLANS AND REQUIREMENTS OF THE

9. THE LOCATION AND PROTECTION OF ALL UTILITIES IS THE RESPONSIBILITY OF THE 10. DUST SHALL BE CONTROLLED BY WATERING. 11. SANITARY FACILITIES SHALL BE MAINTAINED ON THE SITE FROM THE BEGINNING TO

COMPLETION OF GRADING OPERATIONS. 12. ALL GRADING SHALL CONFORM TO THE RECOMMENDATIONS IN THE APPROVED GEOTECHNICAL REPORT BY

13. THE CONTRACTOR SHALL INCORPORATE EROSION CONTROL MEASURES TO BE USED DURING AND AFTER CONSTRUCTION. SEPARATE PLANS FOR DRAINAGE AND EROSION CONTROL MEASURES TO BE USED DURING AND AFTER CONSTRUCTION ARE TO BE IN COMPLIANCE WITH ALL APPLICABLE STORM WATER POLLUTION REQUIREMENTS. 14. THE ENGINEERING GEOLOGIST SHALL INSPECT AND APPROVE ALL CUT SLOPES. 15. PRIOR TO ISSUANCE OF THE BUILDING PERMITS, A SOIL EXPANSION TEST PERFORMED IN ACCORDANCE WITH THE PROCEDURES OF UNIFORM BUILDING CODE STANDARD NO. 18-2 IS REQUIRED. 16. PRIOR TO PLACING COMPACTED FILL, THE SURFACE SHALL BE STRIPPED

OF VEGETATION AND THE SURFACE SCARIFIED TO A DEPTH OF 12 INCHES OR AS SPECIFIED BY THE SOILS ENGINEER AND APPROVED BY THE BUILDING OFFICIAL, BROUGHT TO OPTIMUM MOISTURE CONTENT, RECOMPACTED TO 90% MAXIMUM DENSITY AND INSPECTED BY THE GRADING INSPECTOR AND THE SOIL TESTING AGENCY. 17. CUT SLOPES SHALL BE NO STEEPER THAN 2 HORIZONTAL TO 1 VERTICAL.

1. ALL WORK SHALL CONFORM TO THE LATEST EDITION OF STANDARD SPECIFICATIONS FOR PUBLIC WORKS CONSTRUCTION (THE

2. APPLICATION FOR EXCAVATION AND INSPECTION IN CONNECTION WITH WORK SHOWN ON THIS PLAN MUST BE COMPLETED BY

3. WORK IN PUBLIC STREETS ONCE BEGUN SHALL BE PROSECUTED WITHOUT DELAY SO AS TO PROVIDE MINIMUM INCONVENIENCE

6. CONTRACTOR SHALL PROTECT EXISTING IRRIGATION LINES AND SPRINKLER HEADS BEHIND EXISTING CURB. THE CONTRACTOR

7. CONTRACTOR SHALL REPLACE TRAFFIC STRIPES, LEGENDS, LOOP DETECTORS AND MARKINGS DAMAGED DURING THE CONSTRUCTION OF THIS PROJECT. TRAFFIC STRIPES, PAVEMENT LEGENDS, RAISED PAVEMENT MARKERS AND LOOP DETECTORS SHALL BE PER THE 2014 CALIFORNIA MUTCD, CALTRANS STANDARD PLANS AND CALTRANS STANDARD SPECIFICATIONS 84,

8. REFLECTORIZE ALL STRIPES AND LEGENDS. PAVEMENT MARKINGS SHALL BE THERMOPLASTIC AND SHALL MATCH CITY

11. CONTRACTOR SHALL RE-STRIPE EXISTING STRIPING, MARKING ALL INTERSECTING, AND JOINING STREETS WITHIN 100' OF

12. TYPE DB 2-WAY BLUE REFLECTIVE MARKERS SHALL BE INSTALLED ADJACENT TO EXISTING FIRE HYDRANTS WITHIN THE

14. CONTRACTOR SHALL NOTIFY ALL AFFECTED RESIDENCES IN WRITING AT LEAST TWO (2) FULL WORKING DAYS BEFORE ANY

15. CONTRACTOR SHALL CONTACT UNDERGROUND SERVICE ALBERT (DIG ALERT) AT 811, TWO (2) FULL WORKING DAYS PRIOR TO START OF WORK. THE CONTRACTOR MUST OBTAIN AND MAINTAIN VALID DIG ALERT REFERENCE NUMBER THROUGH THE

18. THE LOCATION OF EXISTING UTILITIES IS SHOWN IN AN APPROXIMATE WAY ONLY. THE CONTRACTOR SHALL DETERMINE THE EXACT LOCATION OF ALL EXISTING UTILITIES PRIOR COMMENCING WORK. THE CONTRACTOR SHALL BE FULLY RESPONSIBLE FOR ANY AND ALL DAMAGES, WHICH MIGHT BE OCCASIONED BY THE FAILURE TO EXACTLY LOCATE AND PRESERVE ANY AND ALL

19. CONTRACTOR SHALL USE BEST MANAGEMENT PRACTICES (BMP'S) TO CONTROL EROSION AND SEDIMENT AND PRESERVE

10. STRIPING SHALL BE CAT-TRACKED AND APPROVED BY THE CITY TRAFFIC ENGINEER PRIOR TO FINAL INSTALLATION.

13. AS BUILTS OF THE COMPLETED PROJECT SHALL BE SUBMITTED FOR APPROVAL OF THE CITY ENGINEER.

16. CONTRACTOR SHALL PROJECT ALL CENTERLINE SURVEY MONUMENT AND CENTERLINE TIES AS SPECIFIED.

17. EXISTING STRIPES AND MARKINGS TO BE REMOVED SHALL BE DONE BY WET SANDBLASTING.

THE CONTRACTOR AT LEAST TWENTY-FOUR (24) HOURS PRIOR TO STARTING ANY WORK.

4. TRAFFIC CONTROL SHALL BE MAINTAINED IN ACCORDANCE WITH THE CALIFORNIA MUTCD.

SHALL REPLACE ANY DAMAGED LINES AND SPRINKLER HEADS AT HIS OWN EXPENSE.

GREENBOOK), STANDARD PLANS FOR PUBLIC WORKS CONSTRUCTION (A.P.W.A. STANDARDS), AND STANDARDS OF THE CITY

18. FILLS SHALL BE COMPACTED THROUGHOUT TO 90% OF MAXIMUM DENSITY AS DETERMINED BY UNIFORM BUILDING CODE SECTION 3313, LATEST EDITION ADOPTED BY THE CITY, AND CERTIFIED BY THE SOILS ENGINEER. NOT LESS THAN ONE FIELD DENSITY TEST WILL BE MADE FOR EACH 2 FEET OF VERTICAL LIFT OF FILL NOR LESS THAN ONE SUCH TEST FOR EACH 1,000 CUBIC YARDS OF MATERIAL PLACED. AT LEAST ONE—HALE OF THE REQUIRED TESTS SHALL BE MADE AT THE LOCATION OF THE FINAL FILL SLOPE.

TO ADJACENT PROPERTY OWNERS AND THE TRAVELING PUBLIC.

9. TRAFFIC STRIPES AND MARKINGS SHALL BE THERMOPLASTIC.

LIMITS OF CONSTRUCTION PER STATE AND CITY STANDARDS.

LIFE OF THE PROJECT AS NECESSARY FOR CONSTRUCTION.

WATER QUALITY TO THE MAXIMUM EXTENT POSSIBLE.

5. CONTRACTOR SHALL IMPLEMENT DUST CONTROL MEASURES AT ALL TIMES.

GENERAL STREET CONSTRUCTION NOTES:

85. AND 86. LATEST EDITIONS.

LIMITS OF PROJECT.

STENCILS, OR CALTRANS STANDARDS.

START OF CONSTRUCTION AS SPECIFIED.

OF POMONA PUBLIC WORKS DEPARTMENT.

19. FILL SLOPES SHALL BE NO STEEPER THAN 2 HORIZONTAL TO I VERTICAL AND SHALL BE COMPACTED TO NO LESS THAN 90% OF MAXIMUM DENSITY OUT TO THE FINISHED SURFACE. ALL FILL SLOPES GREATER THAN 5 FEET IN VERTICAL HEIGHT SHALL BE GRID ROLLED TO COMPACT THE OUTER 6" TO 8" TO AT LEAST 90% OF MAXIMUM DENSITY. 20. NO ROCK OR SIMILAR MATERIAL GREATER THAN 12 INCHES IN DIMENSION WILL BE PLACED IN THE FILL UNLESS RECOMMENDATIONS FOR SUCH PLACEMENT HAVE BEEN SUBMITTED BY THE SOILS ENGINEER IN ADVANCE AND APPROVED BY THE BUILDING OFFICIAL.

21. NO FILL SHALL BE PLACED UNTIL STRIPPING OF VEGETATION, REMOVAL OF UNSUITABLE SOILS AND INSTALLATION OF SUBDRAINS (IF REQUIRED) HAVE BEEN INSPECTED AND APPROVED BY THE SOILS ENGINEER AND THE CITY GRADING INSPECTOR. 22. CONTINUOUS INSPECTION BY THE SOILS ENGINEER OR HIS RESPONSIBLE REPRESENTATIVE WILL BE PROVIDED

DURING ALL FILL PLACEMENT AND COMPACTION OPERATIONS. 23. ALL EXISTING FILLS SHALL BE APPROVED BY THE SOILS ENGINEER AND THE BUILDING OFFICIAL OR HIS REPRESENTATIVE BEFORE ANY ADDITIONAL FILLS ARE ADDED. 24. ALL TRENCH BACKFILLS SHALL BE TESTED AND CERTIFIED BY THE SOILS ENGINEER. 25. ALL CONCRETE STRUCTURES THAT COME IN CONTACT WITH THE ONSITE SOILS SHALL BE CONSTRUCTED WITH TYPE 5 SIX (6) SACK CEMENT UNLESS SULFATE-CONTENT TESTS CONDUCTED BY THE SOIL'S ENGINEER SHOW IS TO

26. THE CIVIL ENGINEER SHALL PROVIDE PROFESSIONAL INSPECTION WITHIN SUCH ENGINEER'S AREA OF TECHNICAL SPECIALTY, WHICH SHALL CONSIST OF OBSERVATION AND REVIEW AS TO THE ESTABLISHMENT OF LINE, GRADE AND SURFACE DRAINAGE OF THE DEVELOPMENT AREA. 27. THE SOILS ENGINEER SHALL PROVIDE SUFFICIENT INSPECTION DURING THE PREPARATION OF NATURAL GROUND AND PLACEMENT OF COMPACTION TO VERIFY THAT SUCH WORK IS BEING PERFORMED IN ACCORDANCE WITH THE CONDITIONS OF THE APPROVED PLAN AND THE REQUIREMENTS OF TH UNIFORM BUILDING CODE SECTION 3317.3 LATEST EDITION ADOPTED BY THE CITY. REVISED RECOMMENDATIONS RELATING TO CONDITIONS DIFFERING FROM THE APPROVED SOILS ENGINEERING REPORT SHALL BE SUBMITTED TO THE PERMITTEE. THE BUILDING OFFICIAL. AND THE CIVIL ENGINEER. 28. THE ENGINEERING GEOLOGIST SHALL PROVIDE A PROFESSIONAL INSPECTION OF THE BEDROCK EXCAVATION TO DETERMINE IF CONDITIONS ENCOUNTERED ARE IN ACCORDANCE WITH THE APPROVED REPORTS, THE PLANS, SPECIFICATIONS AND CODE WITHIN THEIR PURVIEW, IN ACCORDANCE

ADOPTED BY THE CITY. 29. THE PERMITTEE SHALL BE RESPONSIBLE FOR THE WORK TO BE PERFORMED IN ACCORDANCE WITH THE APPROVED PLANS AND SPECIFICATIONS AND IN CONFORMANCE WITH THE PROVISIONS OF THE UNIFORM BUILDING CODE SECTION 3317.5, AND THE PERMITTEE SHALL ENGAGE CONSULTANTS, IF REQUIRED, TO PROVIDE PROFESSIONAL INSPECTIONS ON A TIMELY BASIS. THE PERMITTEE SHALL ACT AS A COORDINATOR BETWEEN THE CONSULTANTS, THE CONTRACTOR AND THE BUILDING OFFICIAL IN THE EVENT OF CHANGED CONDITIONS, THE PERMITTEE SHALL BE RESPONSIBLE FOR INFORMING THE BUILDING OFFICIAL OF SUCH CHANGE AND SHALL PROVIDE REVISED PLANS FOR APPROVAL

31. PRIOR TO FINAL APPROVAL OF ROUGH GRADING THE CIVIL ENGINEER


WITH THE UNIFORM BUILDING CODE SECTION 3317.4. LATEST EDITION


30. ANY REVISION MADE IN THE APPROVED GRADING AS SHOWN ON THE GRADING PLAN MUST BE SPECIFICALLY APPROVED BY THE BUILDING OFFICIAL OR HIS DESIGNATED REPRESENTATIVE.


SHALL SUBMIT AN "AS-BUILT" GRADING PLAN, IN ACCORDANCE WITH SECTION 3318.1 FOR APPROVAL BY THE BUILDING OFFICIAL. THIS PLAN SHALL SHOW ORIGINAL GROUND SURFACE AND AS-GRADED GROUND SURFACE ELEVATIONS, ALL FEATURES SHOWN ON THE APPROVED GRADING PLAN, FINAL PAD GRADES, THE ACTUAL LOCATIONS AND ELEVATIONS OF ALL SUBDRAINS, ROCK DISPOSAL SITES, KEYWAYS, BUTTRESS OR STABILITY FILLS AND ANY OTHER REMEDIAL GRADING, ANY VARIANCES BETWEEN THE FINISHED WORK AND THE APPROVED PLANS, ACTUAL YARDAGE MOVED (INCLUDING REMEDIAL GRADING) AND A CERTIFICATION THAT THE "AS-BUILT" PLANS SHOWS THE ABOVE ITEMS. ROUGH GRADING WILL NOT BE APPROVED UNTIL AFTER THE "AS-BUILT" GRADING PLAN. 32. FOR ROUGH GRADING THE CONTRACTOR SHALL CONSTRUCT BERMS AT THE TOP OF ALL MANUFACTURED SLOPES AS SHOWN PER DETAIL ON THIS PLAN. 33. FINISH GRADING WILL BE COMPLETED AND APPROVED AND SLOPE PLANTING AND IRRIGATION SYSTEM INSTALLED BEFORE OCCUPANCY OF ANY BUILDING AND BEFORE RELEASE OF ANY GRADING BONDS. 34. ALL CUT AND FILL SLOPES OVER 5 FEET IN VERTICAL HEIGHT SHALL BE PLANTED AND PROVIDED WITH AN RRIGATION SYSTEM IN ACCORDANCE WITH AN APPROVED LANDSCAPE PLAN. 35. ALL REQUIREMENTS OF THE APPROVAL OF THE TENTATIVE TRACT NO. TBD APPLICABLE TO THE FINAL

OWNER:

36. ALL REQUIREMENTS OF THE PLANNING COMMISSION RESOLUTION NO. TBD SHALL BE MET.

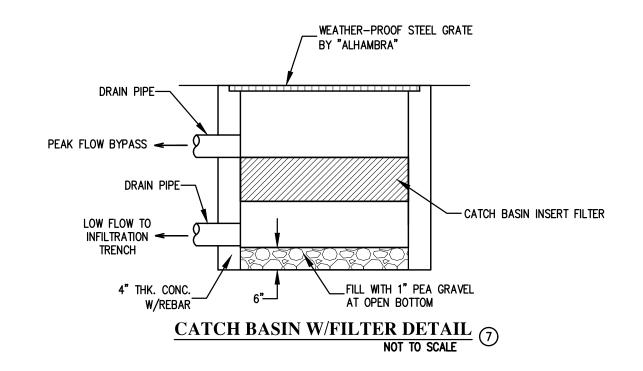

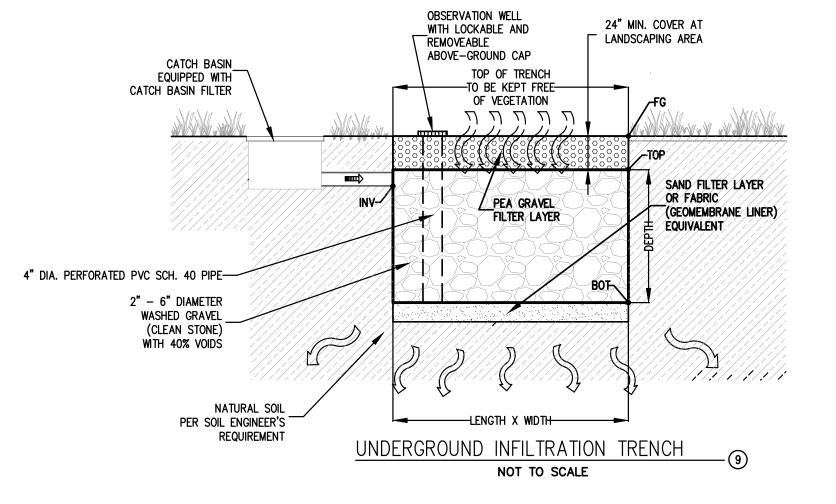

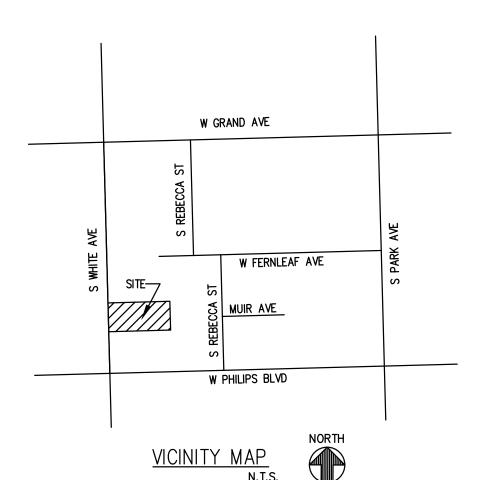

<u>LEGAL DESCRIPTION</u> HE LAND REFERRED TO HEREIN BELOW IS SITUATED IN THE COUNTY OF LOS ANGELES, STATE OF CALIFORNIA, AND IS DESCRIBED AS FOLLOWS:

PART OF LOT 5, IN BLOCK 188 OF THE CITY OF POMONA, AS PER MAP RECORDED IN BOOK 3, PAGES 90 AND 91, OF MISCELLANEOUS RECORDS OF SAID COUNTY.

APN: 8343-008-020

SURVEY WAS PROVIDED BY ALFRED J. THELWELL, LS 6999 ON OCTOBER 27, 2016

EARTHWORK

CUT..... 200 CY FILL..... 200 CY

SPECIAL NOTE: THE QUANTITIES SHOWN HEREON ARE FOR PERMIT AND BONDING PURPOSES ONLY. THE CONTRACTOR SHALL VERIFY QUANTITIES PRIOR TO START OF GRADING.

(89.02)..... EXISTING ELEVATION 90.00.....PROPOSED ELEVATION — 95 — PROPOSED CONTOUR --(89)-- EXISTING CONTOUR == == ...EXISITING WALL RL ...RIDGE LINE ...END OF CONCRETE ...END OF PAVEMENTEXISTINGTOP GRATE ...INVERT ELEVATIONFINISH SURFACE (WHEN CONCRETE, PAVED)TOP OF CURB ...FLOW LINE FINISH GRADEHIGH POINT

TOP.....TOP OF INFILTRATION BASIN

BOT.....BOTTOM OF INFILTRATION BASIN

SHEET INDEX:

ACCEPTED

...TITLE SHEETCONCEPTUAL GRADING & DRAINAGE PLAN

Y:	PLANNING DIVISION	DATE:
CC	EPTED	
Y:	BUILDING OFFICIAL	DATE:
ON	CURRED	
Y:	RENE GUERRERO, P.E., RCE NO. 66263, CITY ENGINEER	DATE:

PUBLIC WORKS DEPARTMENT/ENGINEERING DIVISION

CITY OF POMONA

CONCEPTUAL GRADING PLAN

REVIEWED:

TITLE SHEET

UNDERGROUND SERVICE ALERT

CALL: TOLL FREE 422-4133


TWO WORKING DAYS BEFORE YOU DIG

BENCHMARK:

COUNTY BENCHMARK FG5109 PK NAIL IN S CB @ BCR @ SW COR WHITE AVE & GRAND AVE ELEV 814.485

DEVELOPER: WF CONSTRUCTION **620 ARROW HIGHWAY LA VERNE, CA 91753** TEL: 909-599-4262 FAX:

These drawings and the accompanying specifications are exclusive property of EGL Associates, Inc. Written permission is required by EGL to re—use or reproduce these drawings and specifications by any method in whole or in part. A written consent is required if the drawings are to be used by other than EGL Associates, Inc. Any questions arisen from these drawings should be directed to EGL Associates in a written format.

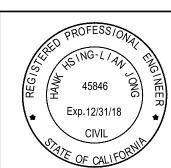

EGL Associates, Inc. 11819 GOLDRING ROAD, UNIT A ARCADIA, CA 91006 TEL: (626)-263-3588 FAX: (626)-263-3599 E-mail: mail@egl88.com EGL PROJECT NO. 16-240-003

DATE INITIAL AS SHOWN **REVISIONS**

1452 S. WHITE AVENUE POMONA, CA 91768 SCALE PVT. ENG SHT. _1_ **DESIGNED:** PVT. ENG DRAWN: CHECKED:

