
Well and Fit ADH CONDITIONAL USE PER

105 MERCURY CIR. POMONA. CALIF.917

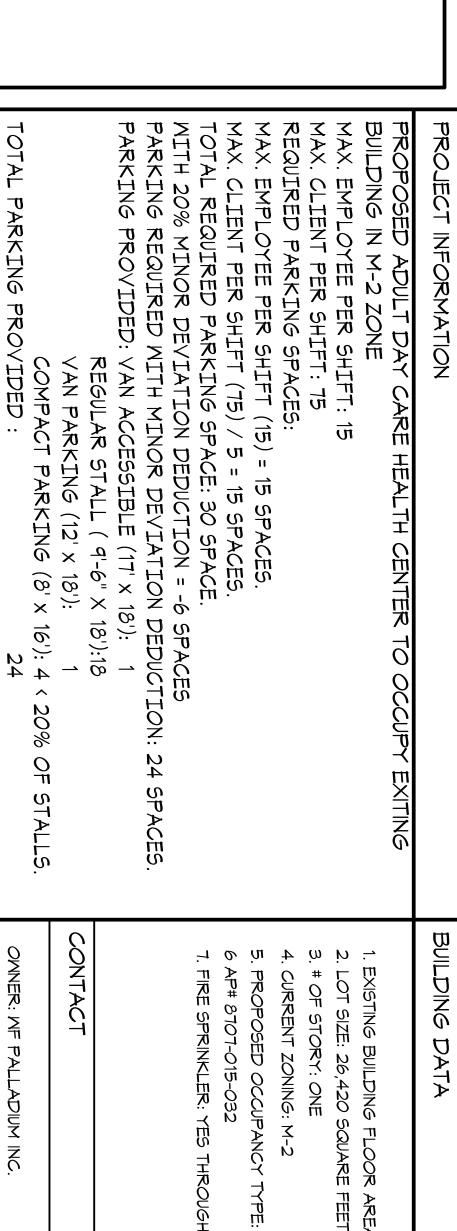

DESIGNER CONTRACTOR: (626) 318-3000

(626) 961-7688

LANDSCAPE ARCHITECT: JK DESIGN & ASSOCIATES (909) 598-2877 LAND SURVEYOR: CALILAND ENGINEERING (626) 281-2288

TOTAL PARKING PROVIDED:

24

SIZE OF PARKING LOT: 14,420 SQUARE FEET

REQUIRED LANDSCAPE AREA: 6% = 865 SQUARE FEET.

LANDSCAPE AREA PROPOSED: 7.9% =1,141 SQUARE FEET.

ON SITE IMPROVEMENT PROPOSED:

1) 6' HEIGHT MASONRY BLOCK WALL AT NORTH & WEST PROPOSED:

2) INSTALL 6" CURB FOR ALL PLANTER AREA.

3) CONSTRUCT (N) DOUBLE BINS TRASH ENCLOSURE.

4) INSTALL (3) PARKING LOT POLE LIGHTS.

5) INSTALL (3) WALL PACK LIGHT FIXTURES.

6) (N) IRRIGATION SYSTEM AND (N) LANDSCAPE.

7) ALL ROOF TOP EQUIPMENT TO BE SCREENED FROM PUB

PROPERTY LINE

PUBLIC VIEW.

SHEET INDEX

SURVEY MAP/EXISTING SITE PL . Z \$ BUILDING

ENLARGE SITE PLAN

ELEVATIONS PLAN

LANDSOAPE CONCEPTUAL DRAMING

VICINITY MAP


DATA CONDITION

BUILDING FLOOR PL

≯-2

ROOFING & PARKING LOT LIGHTING PLAN

APPLICABLE CODE PLUMBING CODE: VECHANICAL ELECTRICAL BUILDING CODE: 2013 ENERGY CODE 2013 2013 2013 2013 シュン

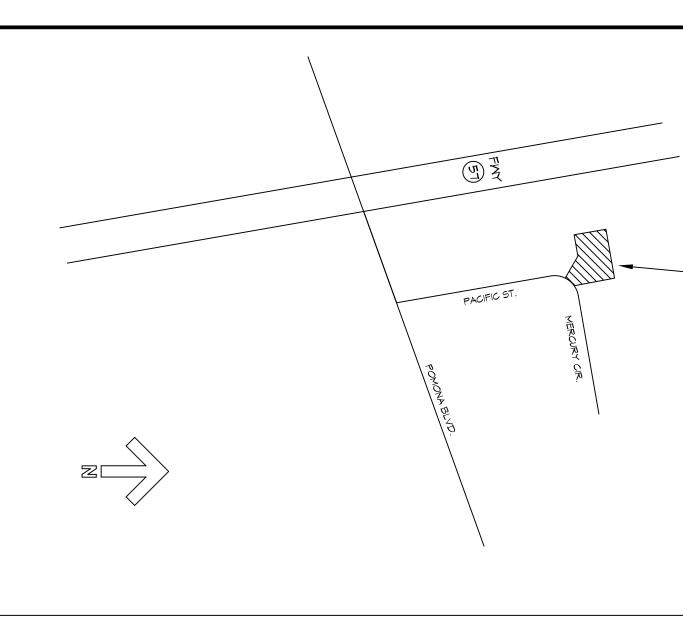



ATTACHMENT A

FOR CONSTRUCTION ACTIVITIES*

Storm Water Pollution Control Requirements for Construction Activities Minimum Water Quality Protection Requirements for All Development Construction Projects/Certification Statement

r as an attachment for building and grading plans and ekeeping that must be implemented on all construction

Eroded sediments and other pollutants must be retained on site and may not be tra via sheetflow, swales, area drains, natural drainage courses or wind.

Fuels, oils, solvents and other toxic materials must be stored in accorda contaminate the soil and surface waters. All approved storage contain weather. Spills must be cleaned up immediately and disposed of in a washed into the drainage system. ance with their listing and an ners are to be protected fr proper manner. Spills may

on-stormwater runoff from equipment and vehicle washing and any other roject site.

Trash and construction related solid wastes must be deposited into contamination of rainwater and dispersal by wind. Excess or waste concrete may not be washed into the public way or any other drainage system. shall be made to retain concrete wastes on site until they can be disposed of as solid waste.

Any slopes with disturbed solls or denuded of vegetation must be stabilized and water.

As the project owner or authorized agent of the owner, I have read and understand the requirements listed above, necessary to control storm water pollution from sediments, erosion, and construction materials, and I certify that I will comply with these requirements.


MERCURY CIRCLE

PROJECT NAME

WELL & FIT ADHC 105 MERCURY CIR., POMONA, CALIF.91768

YELLOW SEA CONSTRUCTION CO. CAL. STATE LIC. # B 902105 COMMERCIAL * INDUSTRIAL

3129 S. Hacienda Blvd., #393 Hacienda Heights, CA 91745 tel: (626) 318-3000 fax: (562) 698-6666 e-mail: vfong@charter.net

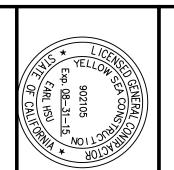

TITLE

SHEET

C.U.P. REV.-1


SCALE

2/8/17

SQUARE

ADULT DAY CARE CENTER



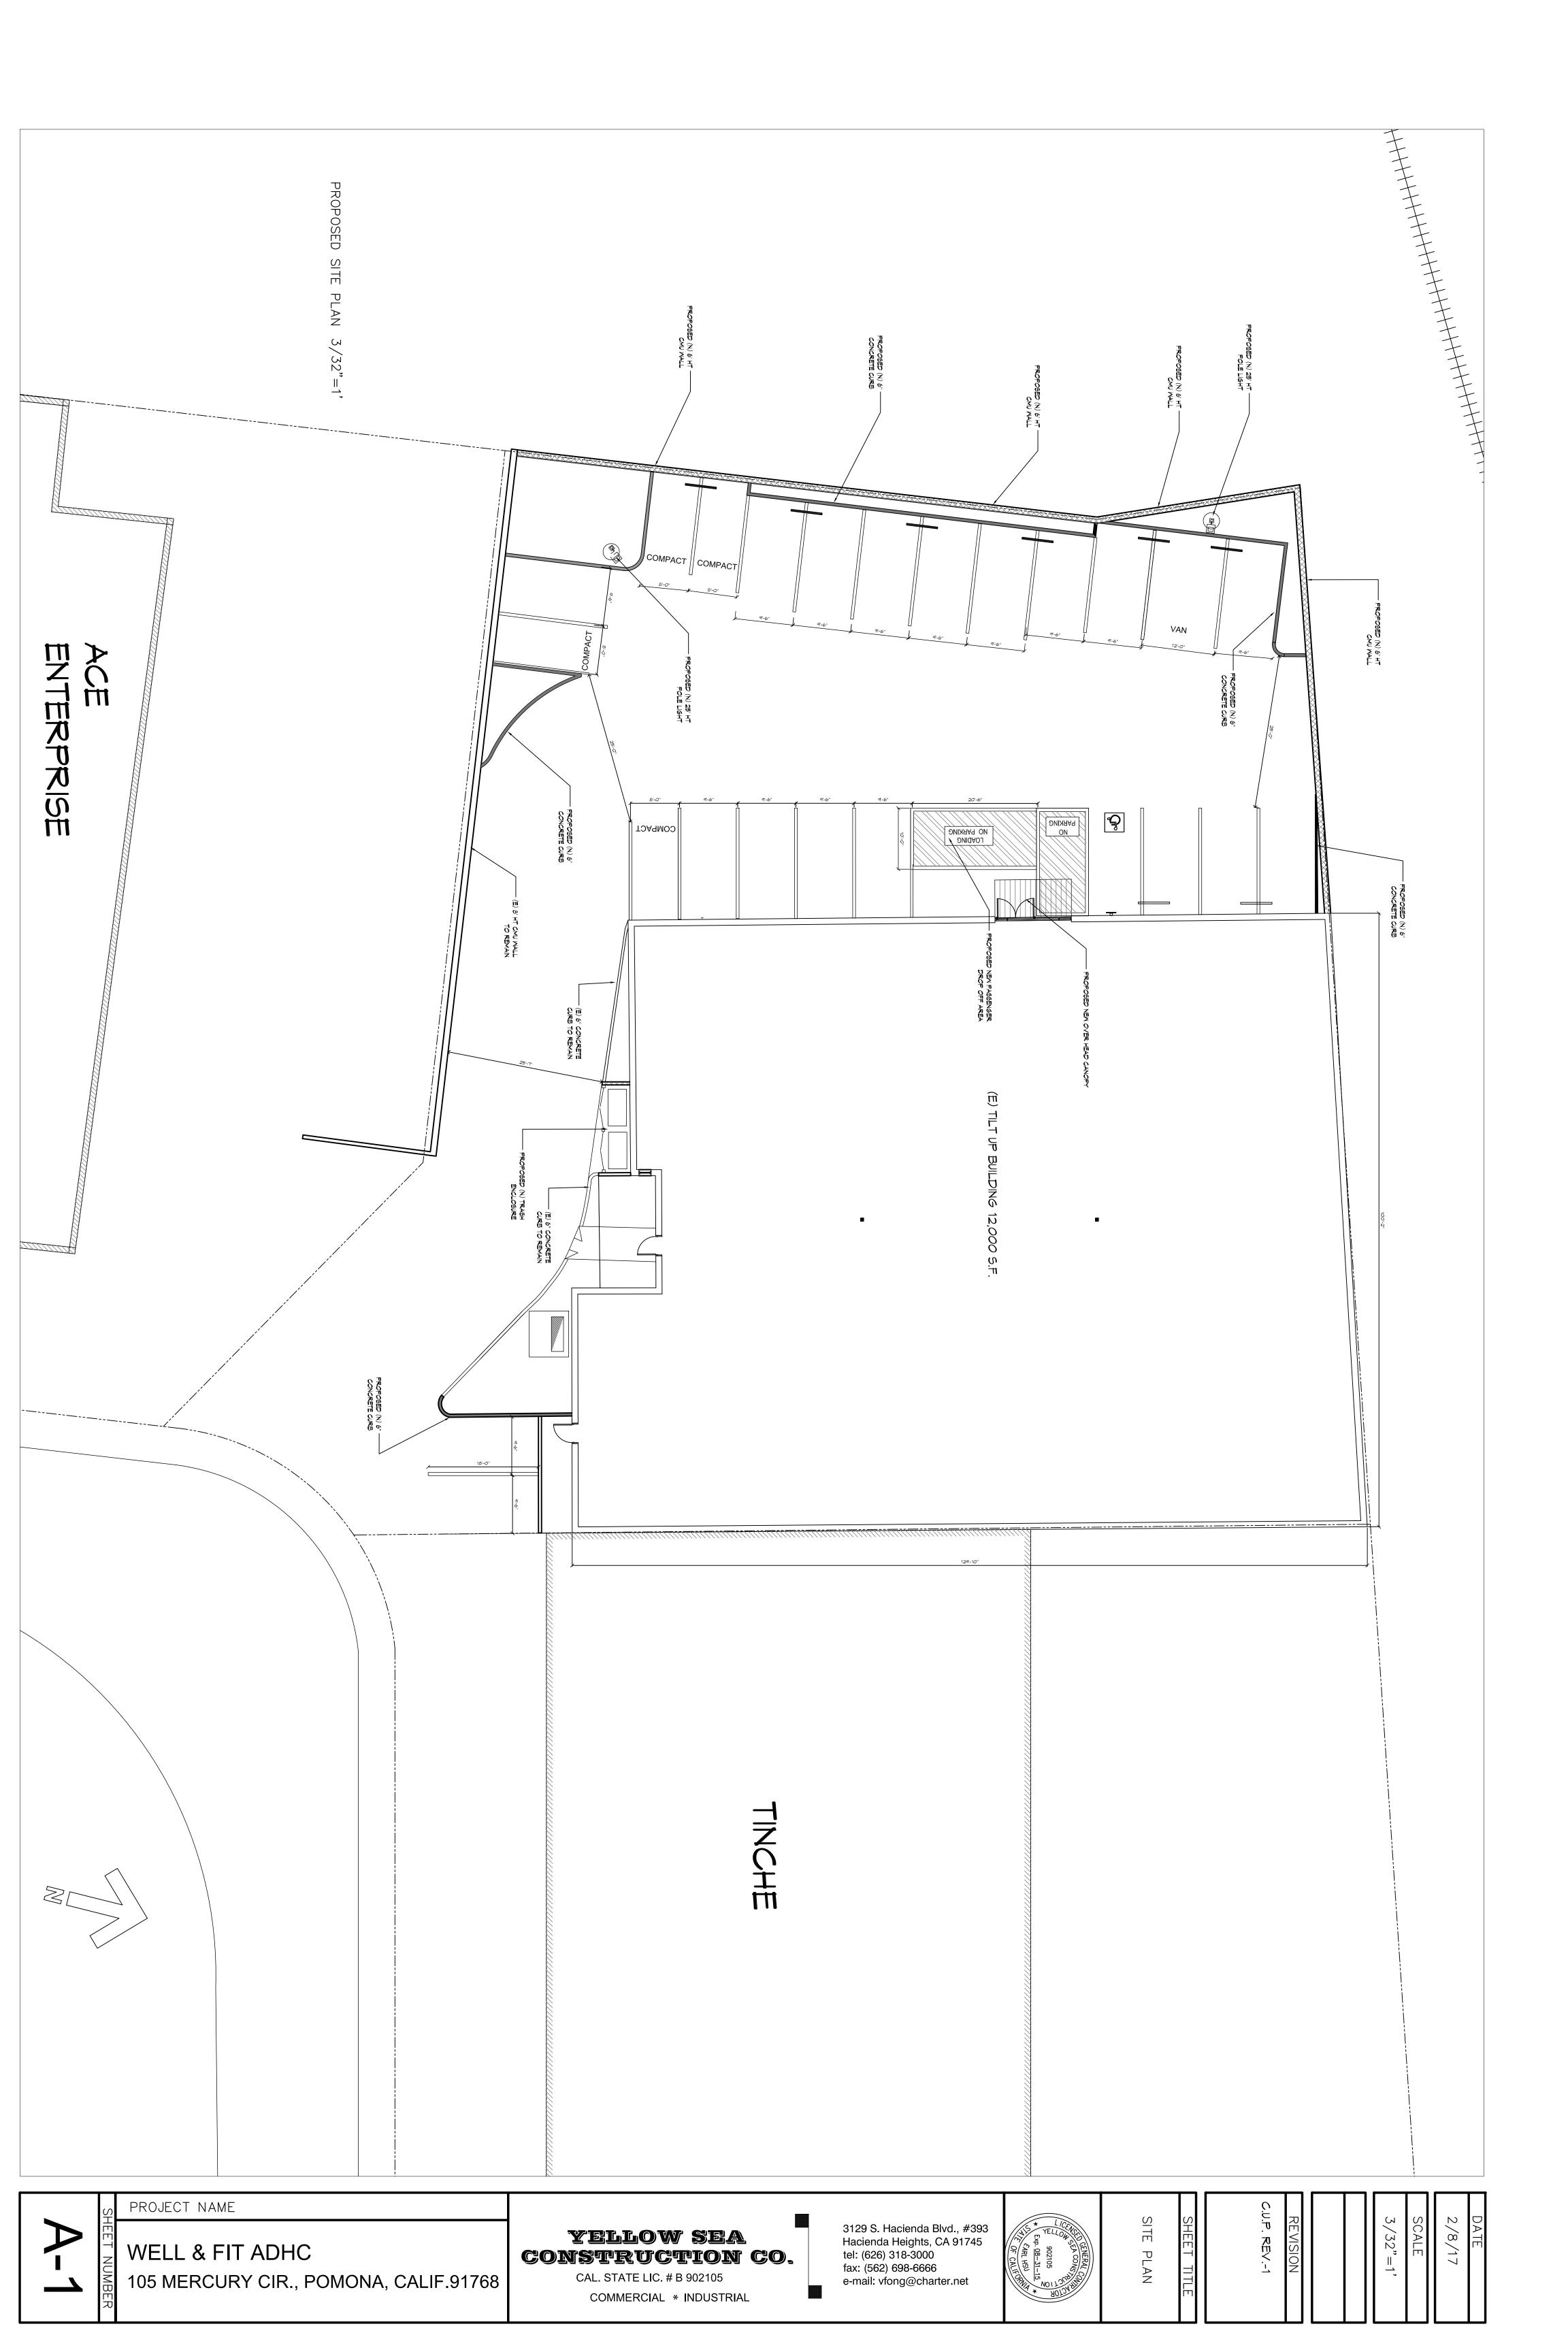




PROJECT NAME

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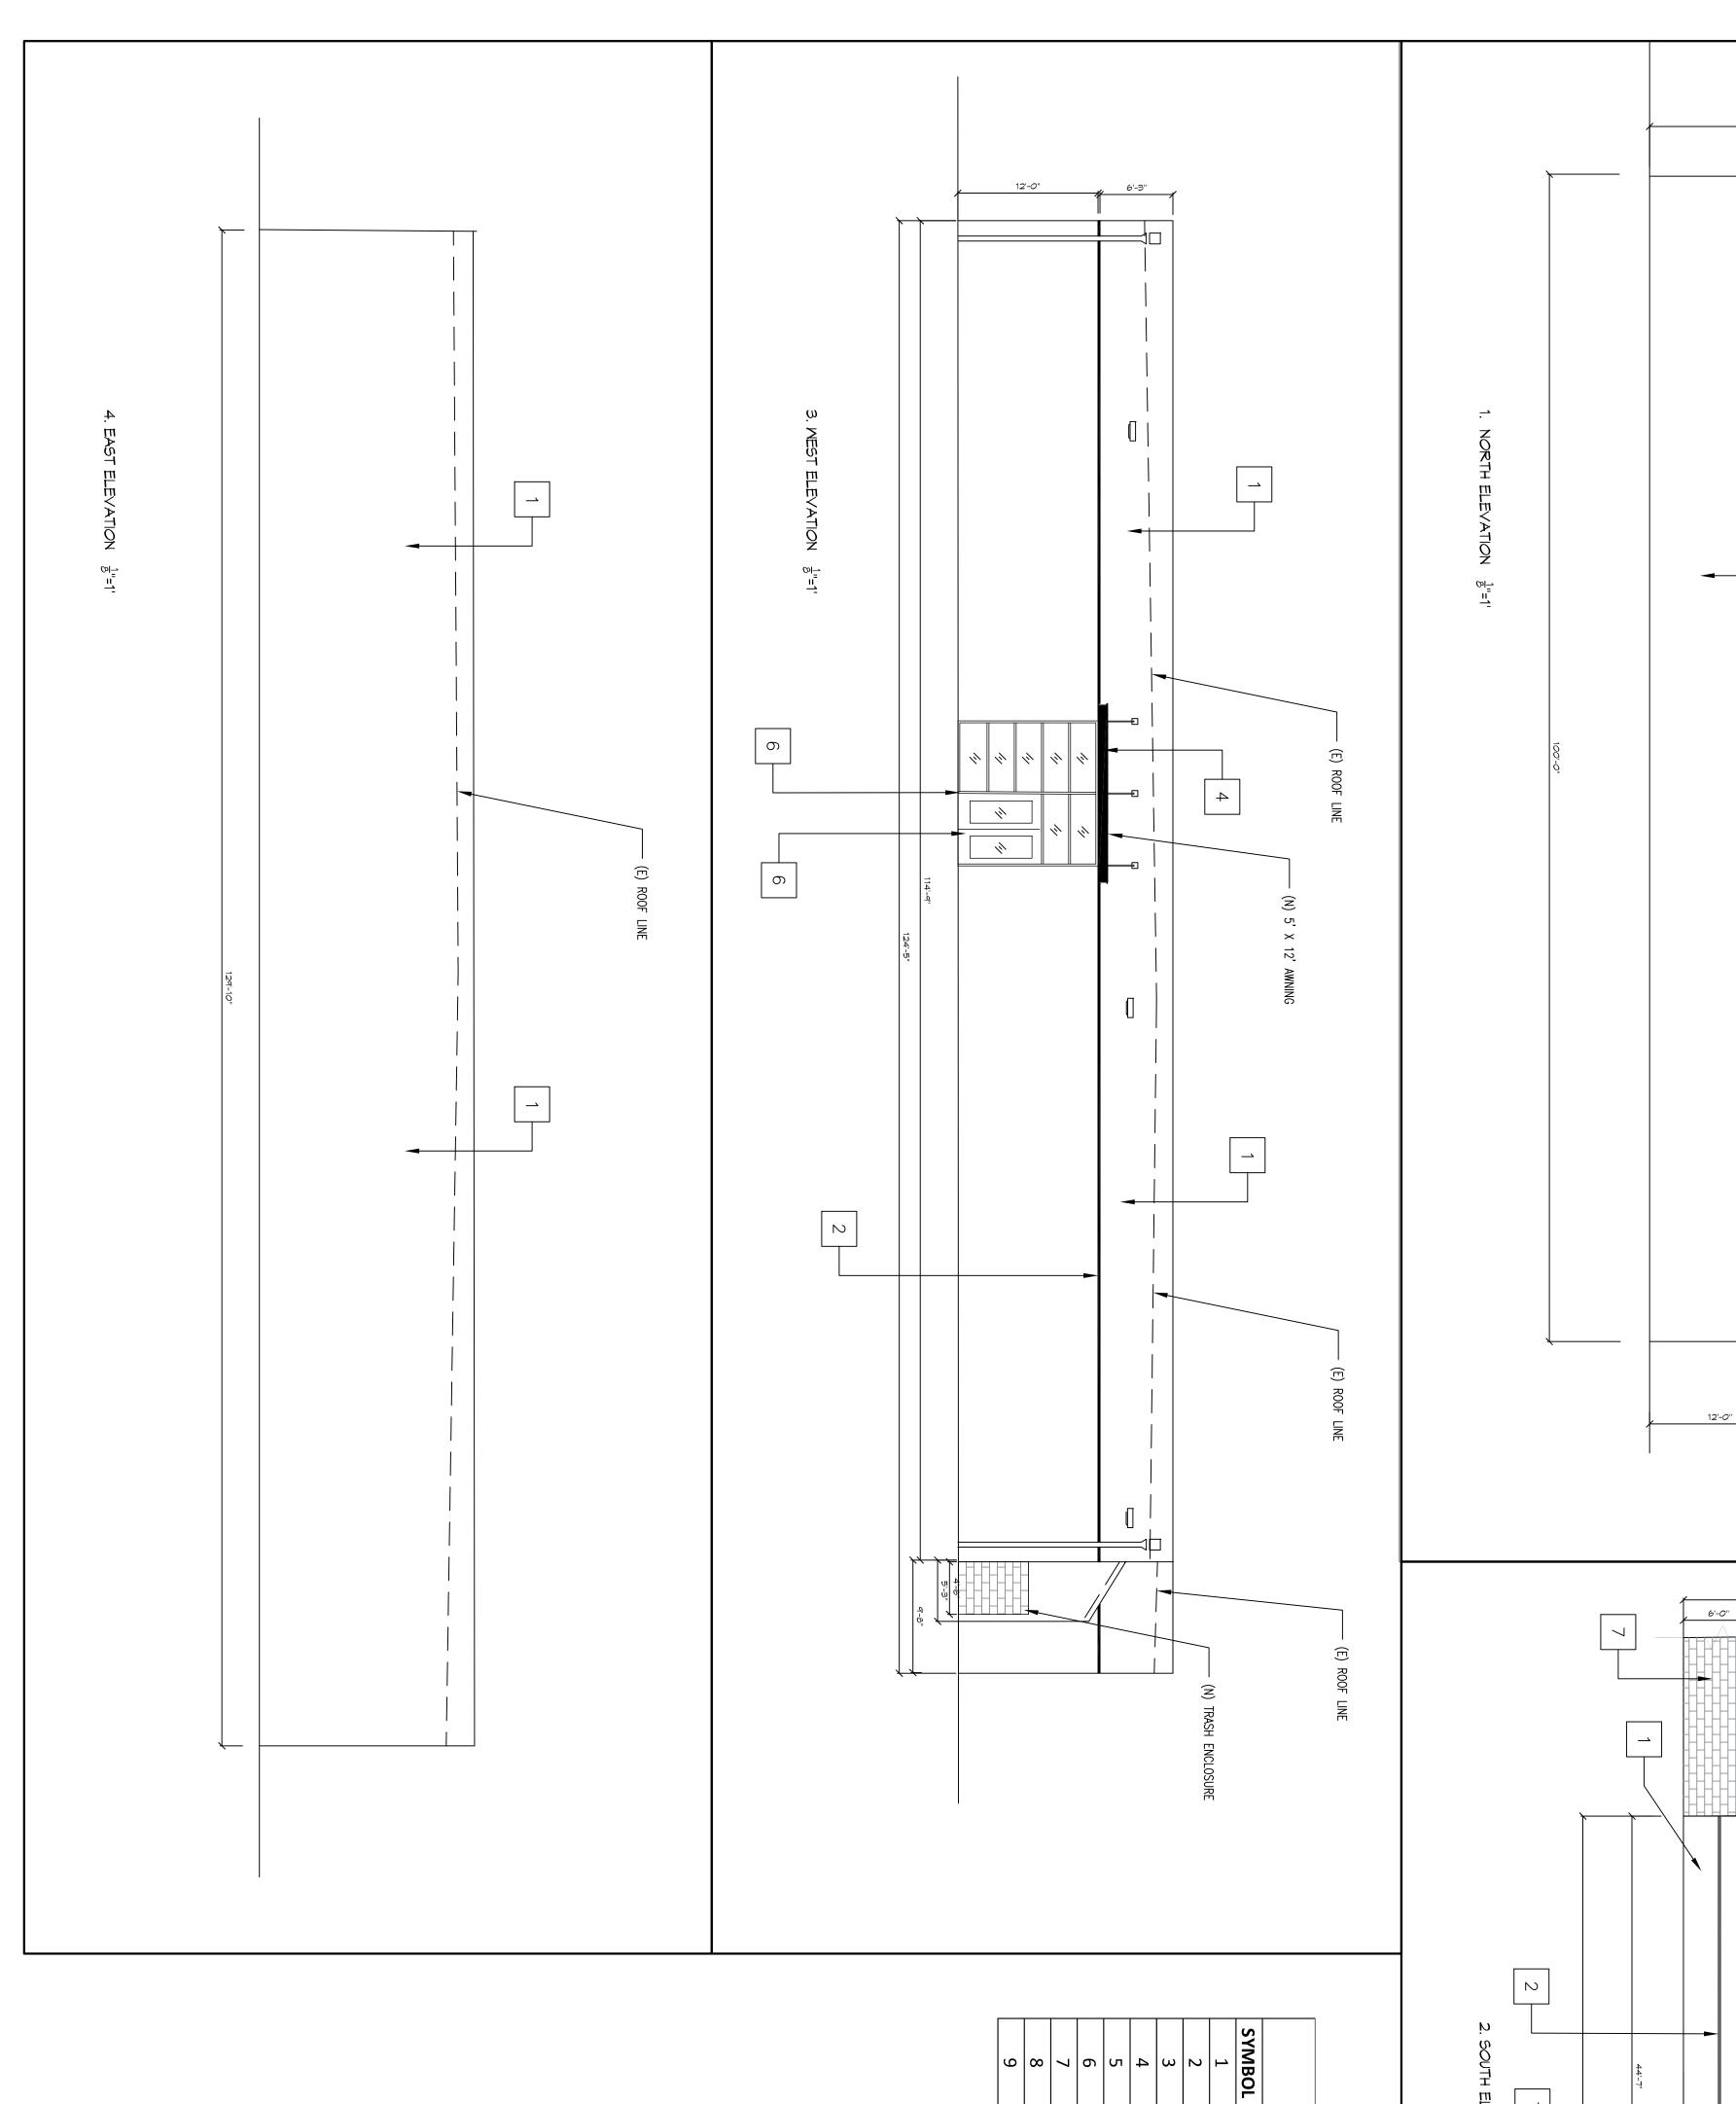



SHEET TITLE
FLOOR PLAN

REVISION

CUP REV-1

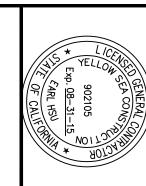2/8/17 SCALE 1/8"=1'



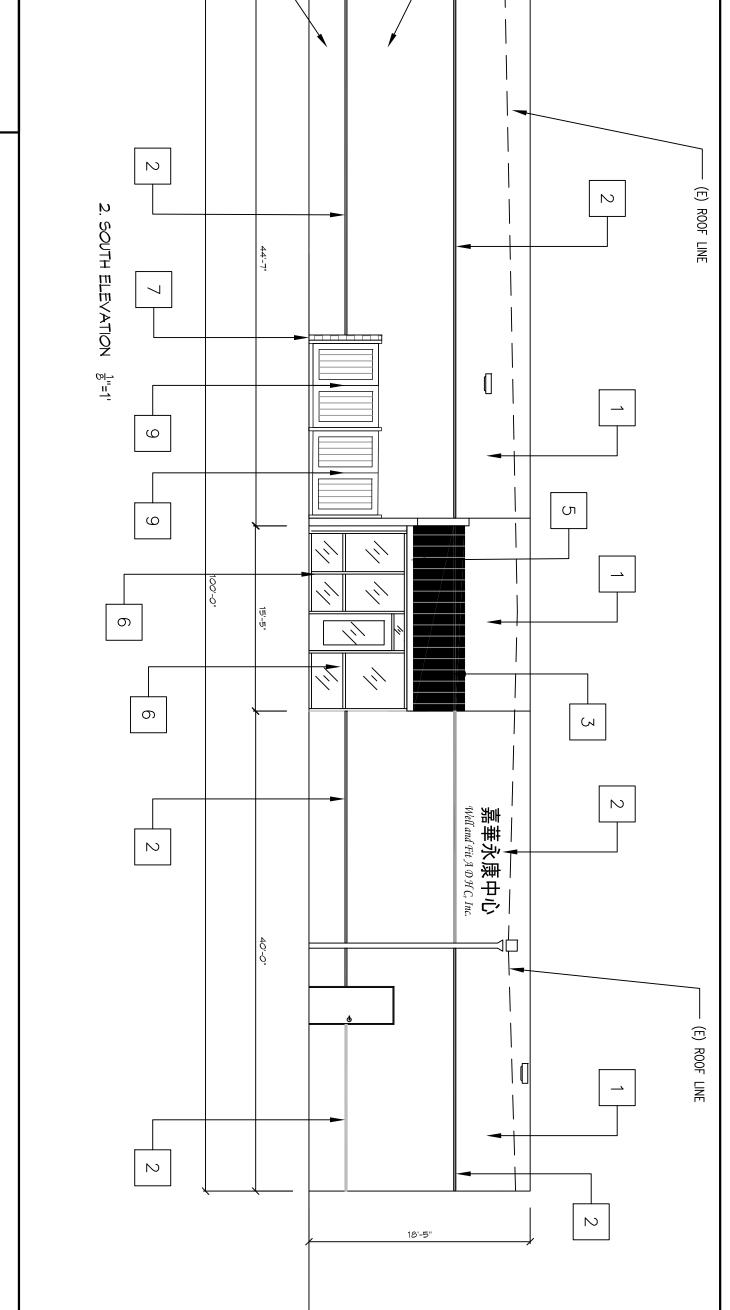


4

6'-3"

- (E) ROOF LINE

(N) 5' X 12' AWNING

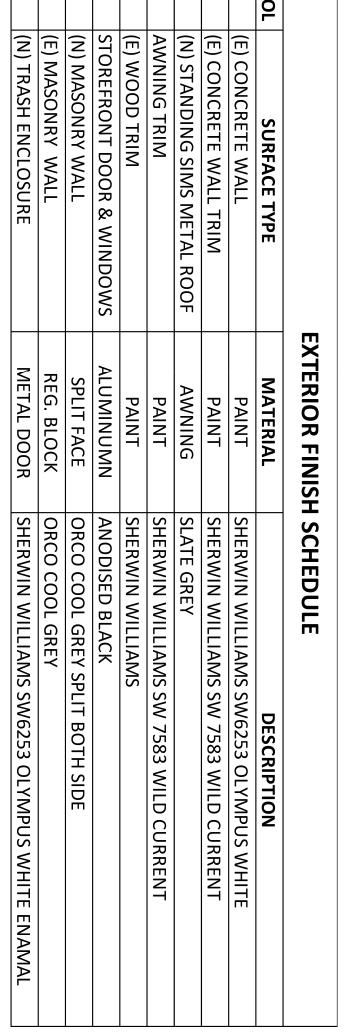

,	-IS	PROJECT NAME
A-3	HEET NUMBER	WELL & FIT ADHC 105 MERCURY CIR., POMONA, CALIF.91768



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Exp. 08-31-15 * OF CALLY ONLY ** ** ** ** ** ** ** ** **	
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	SHEET TITLE

CUP REV.—1	REVISION	1/8"=1"	SCALE	2/8/17	DAIL





PROJECT NAME


WELL & FIT ADHC 105 MERCURY CIR., POMONA, CALIF.91768

YELLOW SEA
CONSTRUCTION CO.

CAL. STATE LIC. # B 902105

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ROOF PLAN

CUP REV.1

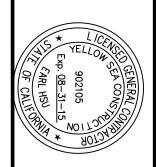SCALE 3/32"=1"

DATE 2/8/17 SCALE

Planting Legend

MAS	QTY.	QTY. BOTANICAL NAME	
	SIZE	SIZE COMMON NAME	Remark
	5	Geijera parvifolia	_
	24"Box	24"Box Australian Willow	Γ
) J	2	Cupaniopsis anacardiodes	-
£	24"box	24"box Carrot wood	
		Existing tree To Remove	

	44 5Gal	Phormium tenax 'Bronze Baby' New Zealand Flax	_
	17 5Gal	Ligustrum j. 'Texanum' Japanese Prtivet	
\bigcirc	38 5Gal	Leonotis leonurus Lion's Tail	
5'o.c.	5'o.c. 5Gal	Lantana montevi.'Gold Rush' Lantana	_

PLANTING NOTES

- DRAWING IS CONDITIONS DIAGRAMMATIC: CONTRACTOR ON SITE. COUNT ALL PLAN CTOR TO VERIFY PLANT MATERIAL ALL LOC, BEFORE LOCATIONS BIDDING. AND
- CONTRACTOR TALL EXISTING TO INSPECT , ST ALL EXISTING BEFORE CONSTR CONSTRUCTION BEG IONS ON BEGINS. SITE AND LOCATE

2

- 3 CONTRACTOR TO OCCURS DURING REPAIR AT 3 PROJECT I HIS OWN EXPENSE INSTALLATION. ALL PROPERTY DAMAGE
- 4 NOTE ADDITIONAL REMARKS ON SPECIFIC PLANTS \equiv PLANT LST.
- 5 EXISTING PLANT MATERIAL 10 B E REMOVED EXCEPT WHERE NOTED $\overset{\circ}{\mathsf{N}}$ PLAN.
- 6 CONTRACTOR TO GUARANTEE ALL IDATE OF ACCEPTANCE BY OWNER. PLANT MATERIAL FOR 90 DAYS FROM HE.
- 7. FINISH GRADE TO BE <u>;</u> BELOW ALL WALKS, CURBS, AND PAVING.
- $\dot{\infty}$ ALL SQ. PLANTED FT. OF S D AREAS SHALL F SURFACE AREA. RECEIVE THE FOLLOWING ROTO—TILL AMENDMENTS AMENDMENTS
 TO A DEPTH PER OF (< 1,000 6"
- *150 LBS. (*3 CU YDS GRO—POWER NITROGENIZED,
- *ADD 8 LBS OF GRO-POWER MINERALIZED FIR BARK OR CONTROLLED RELEASE 12-8-REDWOOD ∞ PER SHAVINGS \bigcap \preceq 9 <u>≤</u> ×
- 9 PLANT HOLE TO BE TWICE AS WIDE AND DEEP AS BACKFILL AND COMPACT TO 80% SOIL OF SITE AN FIR BARK, UNLESS OTHERWISE NOTED. PROVIDE (TABLETS AT THE FOLLOWING RATES: AS THE PLANT ROOT BE AND 4%

 DE GRO-POWER PLANT ROOT BALL.

- GAL 5 GAL 15 GAL 24" P^ 1 1 0 N 0 4

BOX AND UP

PLACE RECOMMENDED TABLETS BETWEEN THE BOTTOM BALL BUT NO HIGHER THAN 1/3 OF THE WAY UP TO SPACE TABLETS EQUALLY AROUND THE PERIMETER OF 2" FROM THE ROOT TIPS. AND AND THE TOP OF THE ROOT TOP OF THE ROOT BALL.

ROOT BALL APPROXIMATELY

- 10."DEEP WITHIN ROOT" 5 FT. BARRIERS ARE TO BE USED AROUND ALL TREES LOCATION . OF PAVING. INSTALL PER MANUFACTURER'S SPECIFICATIONS.
- ALL PROPOSED SHRUBS AND GROUND COVER AREAS ARE TO BE TREATED WITH A PRE—EMERGENT WEED KILLER (EPTAM / RONSTAR). APPLY PER MANUFACTURER'S SPECIFICATIONS: A) IMMEDIATELY AFTER PLANTING, B) AT THE BEGINNING OF THE MAINTENANCE PERIOD, AND C) AT THE EN OF THE MAINTENANCE PERIOD. END
- 12.CONTRACTOR ACCORDANCE WITH THE SPECIFICATIONS UNLESS THE PLANS. TO INSTALL AND MAINTAIN LANSCAPE PLANTING IN GOVERNING AGENCY'S GUIDELINES AND NOTED OTHERWISE IN THESE NOTES C 0R $\frac{\circ}{2}$

		VAN	COMPACT COMPACT	
(N) TRASH ENCLOSURE		PARKING PARKING NO	TOA9MC	DD TOAMPACT CO


drawing content

Conceptual

andscape

Plan

date

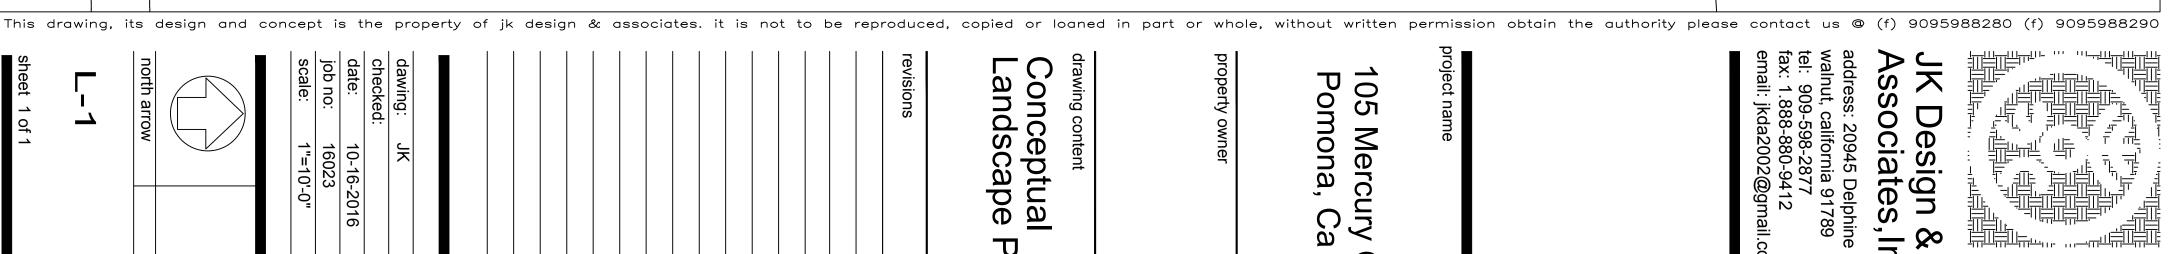

Associates, Inc. Design &

address: 20945 Delphine Drive walnut, california 91789 tel: 909-598-2877 fax: 1.888-880-9412

email: jkda2002@gmail.com

project name

105 Mercury

Pomona, Ca

dawing: checked:

뉘

job no:

16023 1"=10'-0"

10-16-2016