SAN ANTONIO DEVELOPMENT

PLANS PREPARED BY:

CECILE VILLARCSA

MR. AERON ZAMORA

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1476 S. SAN ANTONIO AVE. POMONA CA. 91766

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ANTONIO AVENUE , CA 91766


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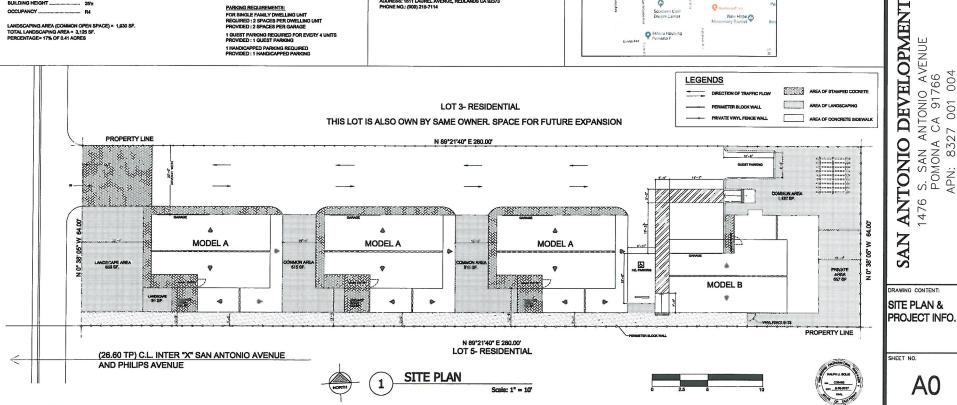
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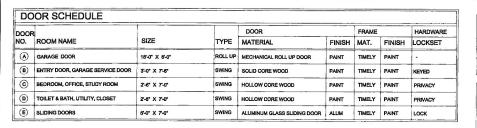
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S. S/ POM(APN:

1476 S. San Antonio Avenue, Pomona CA 91766





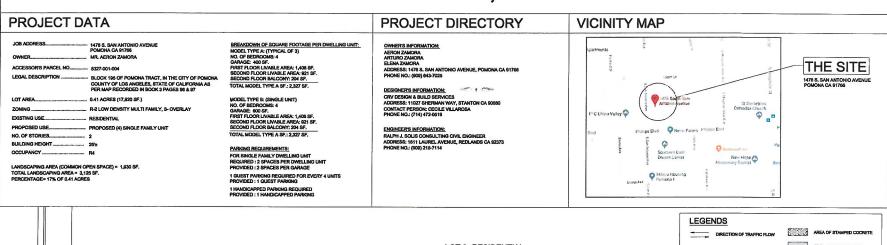



BREAKDOWN OF SQUARE FOOTAGE FOR FIRST FLOOR:
GARAGE: 400 SF.
DINING ROOM: 158 SF.
DINING ROOM: 23 SF.
FAMILY ROOM: 23 SF.
KITCHEN: 90 SF.
BEDROOM: 155 SF.
BEDROOM: 155 SF.
TOTTAL SQUARE FOOTAGE: 1,187 SF.

WINDOW SCHEDULE

WINDOW NUMBER	SIZES (L X H)	MAKE	FRAME	DESCRIPTION	REMARKS	
1	6'-0" X 4'-4"	CLEAR DUAL GLAZED	VINYL	SLIDING X 0	TEMPERED	
(2)	4'-4" X 4'-0"	CLEAR DUAL GLAZED	VINYL	SLIDING X 0	TEMPERED	
(3)	2-2" X 1'-6"	CLEAR DUAL GLAZED	VINYL	SLIDING X 0	TEMPERED TEMPERED	
<u>4</u> <u>5</u>	5-0" X 4'-0"	CLEAR DUAL GLAZED		SLIDING X 0		
	5'-0" X 1'-3"	CLEAR DUAL GLAZED	VINYL	SLIDING X 0		
6	4'-0" X 3'-0"	CLEAR DUAL GLAZED	VINYL	SLIDING X 0	TEMPERED	



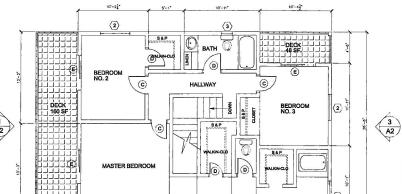

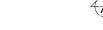

SECOND FLOOR PLAN

DRAWING CONTENT:

MODEL HOUSE TYPE A-FLOOR PLAN

HISTORY RECORDS:

PLANS PREPARED BY:

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MR. AERON ZAMORA 1476 S. SAN ANTONIO AVE. POMONA CA. 91766

DEVELOPMENT

ANTONIO

476


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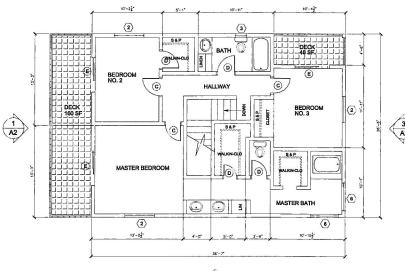
ANTONIO AVENUE A CA 91766 327 001 004

S. SAN AN POMONA C APN: 8327

APN:


SHEET NO.



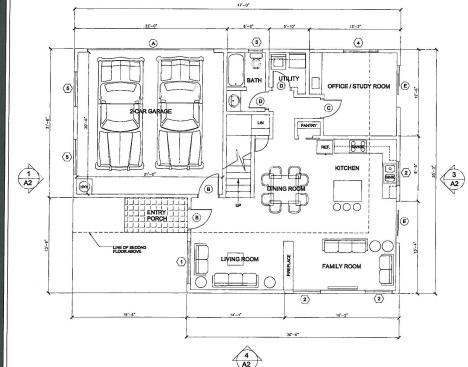

FIRST FLOOR PLAN Scale: 1/4" =1'-0"

Scale: 1/4" =1'-0"

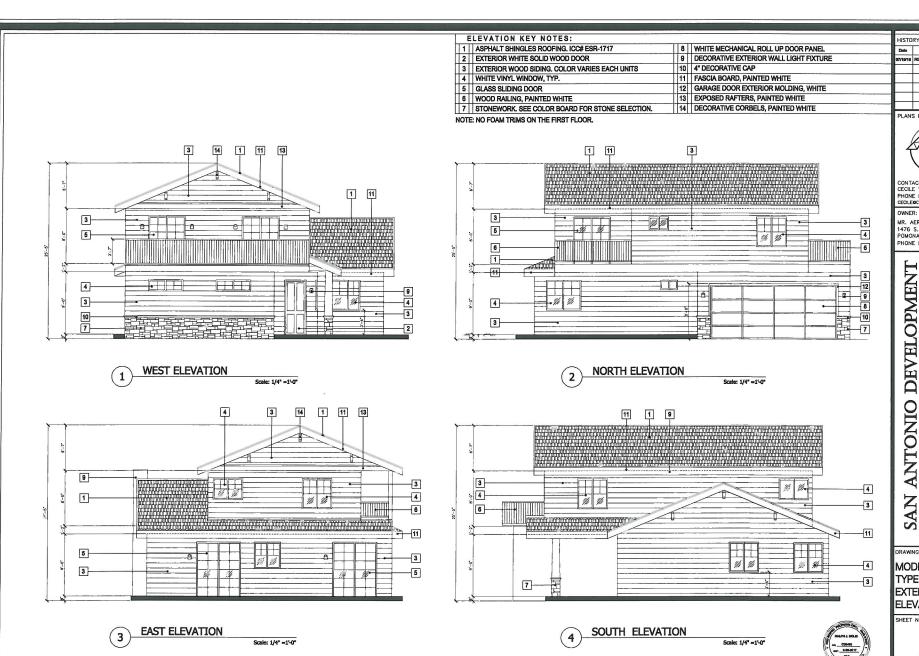

HISTORY RECORDS:



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PHONE NO.: (909)643.7025

DEVELOPMENT S. SAN ANTONIO AVENUE POMONA CA 91766 APN: 8327 001 004

ANTONIO

DRAWING CONTENT:

MODEL HOUSE TYPE A-EXTERIOR ELEVATIONS

SHEET NO.



BREAKDOWN OF SQUARE FOOTAGE FOR FIRST FLOOR: GARAGE: 800 SF. GARAGE: 600 SF.
LIVING ROOM: 159 SF.
DINING ROOM: 22 SF.
FAMILY ROOM: 22 1 SF.
KITCHEN: 90 SF.
BATH & UTILITY: 90 SF.
BEDROOM: 125 SF.
TTOTAL SQUARE FOOTAGE: 1,387 SF.

BREADOWN OF SQUARE FOOTAGE FOR SECOND FLOOR.
MASTERS BEDROOM 165 SF.
MASTERS TOILET & BATH & W.H.C.: 215 SF.
BEDROOM #2: 116 SF.
BEDROOM #2: 116 SF.
BEDROOM #2: 113 SF.
BEDROOM #2: 113 SF.
BEDROOM #2: 113 SF.
DECK: 225 SF.
TOTAL SQUARE FOOTAGE: 966 SF.

WINDOW SCHEDULE

WINDOW NUMBER	SIZES (L X H)	MAKE	FRAME	DESCRIPTION	REMARKS
1	6'-0" X 4'-4"	CLEAR DUAL GLAZED	VINYL	SLIDING X 0	TEMPERED
(2)	4'-4" X 4'-0"	CLEAR DUAL GLAZED	VINYL	SLIDING X 0	TEMPERED
3	2-2" X 1'-6"	CLEAR DUAL GLAZED	VINYL	SLIDING X 0	TEMPERED
	5-0" X 4'-0"	CLEAR DUAL GLAZED	VINYL	SLIDING X 0	TEMPERED
(5)	5'-0" X 1'-3"	CLEAR DUAL GLAZED	VINYL	SLIDING X 0	TEMPERED
(B)	4'-0" X 3'-0"	CLEAR DUAL GLAZED	VINYL	SLIDING X 0	TEMPERED

HISTORY RECURDS: Description 7/19/18 PLANNING RESUDMITTAL

PLANS PREPARED BY:



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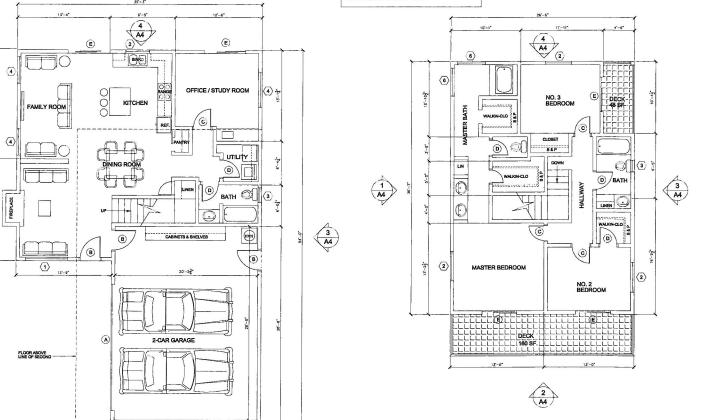
DEVELOPMENT

ANTONIO AVENUE A CA 91766 327 001 004 832 S. SAN A POMONA APN: 832 ANTONIO 476 A

DRAWING CONTENT:

MODEL HOUSE TYPE B-FLOOR PLAN

SHEET NO.



FIRST FLOOR PLAN

(5)

Scale: 1/4" =1'-0"


(5)



SECOND FLOOR PLAN

Scale: 1/4" =1'-0"



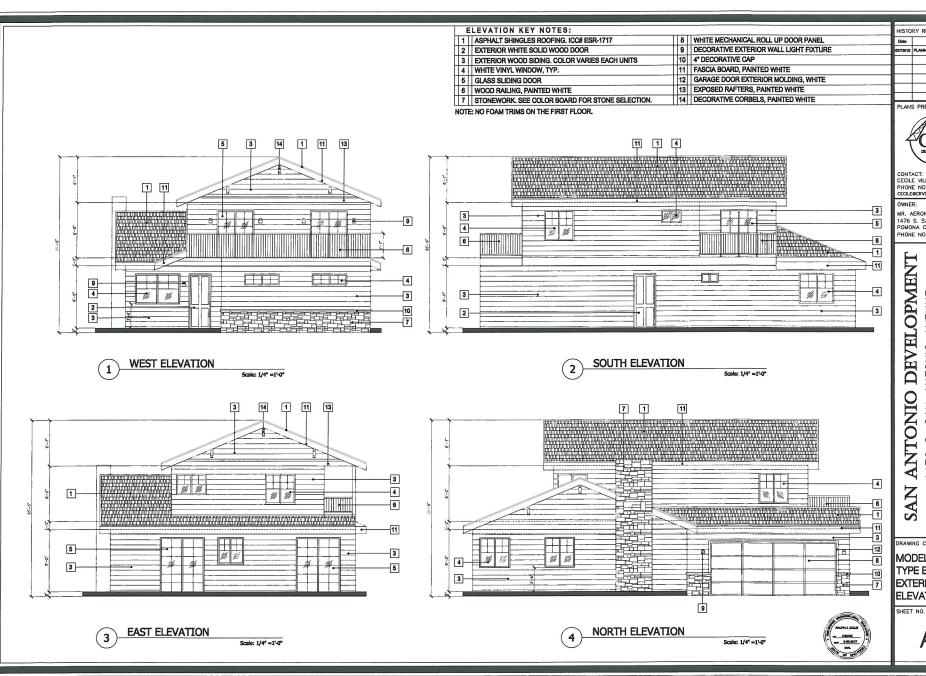

HISTORY RECORDS:

PLANS PREPARED BY:



CONTACT: CECILE VILLAROSA PHONE NO.: (714) 472.0519 CECILEGCRVDBS.CIDM

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S. SAN ANTONIO AVENUE POMONA CA 91766 APN: 8327 001 004

DRAWING CONTENT:

MODEL HOUSE TYPE B-**EXTERIOR** ELEVATIONS

CRRC RAPID RATINGS FOR ROOF

CRRC PROD. ID	MANUFACTURER	BRAND AND MODEL	PRODUCT	COLOR	SOLAR	REFLECTIVE	THERMA	L EMITTANCE	8	3 YEAR
				1	INITIAL	3 YEAR	INITIAL	3 YEAR	INITIAL	3 YEAR
ICC# ESR-1717	EAGLE ROOFING PRODUCTS	OWENS CORNING SUPREME - ESTATE GREY	TILE	GREY	0.21	0.21	0.93	0.91	22	21

ROOF PLAN NOTES

ROOF MATERIAL - ASPHALT SHINGLES 3-TAB ARCHITECTURAL ROOFING AND SHALL BE CLASS 'S' FIRE RATED MINIMUM.(ICCIHESR-1717)

ROOF CONSTRUCTION SHALL BE PER MANUFACTURER'S SPECIFICATIONS WITH THE FOLLOWING AS MINIMUM REQUIREMENTS.

A 11 GA CORPORION RESISTANT MALE WITH MINEUM \$1, RENETRATION HITS SHEATHING FEEL LLG. TABLE 19-04.

E THE NORSE OF ALL RIDGE, HE NORD ARRIC GAS SHALL BE SET IN A BEAD OF APPROVID ROOFERS MASTIC.

C. USE MIN. 30 LB. ROOFING FELT LINDERLYMENT, TYPICAL.

D. MIN. ROOF SHEATHING TO BE USED IS ESTSTING USE STRIP SHEATH, THE COX.PL YHOOD OR GSB ON ENTIRE NEW ROOF.


E PROVIDE MINIMUM 26 GA. GALV. METAL FASHING AT ALL VALLEYS.

F. ROOF PITCH, PASCA BOANGS TYLE AND THAN UNITCH BUSTRING CONSTRUCTION, TYPICAL.


EXPOSED VALLEY FLASHINGS SHALL BE AT LEAST NO. 28- GAUGE CORROSION-RESISTANT METAL INSTALLED OVER A MINIMUM 36" WIDE UNDELAYMENT CONSISTING OF ONE LAYER OF NO. 72 ASTM CAP SHEET RUNNING THE FULL LENGTH OF THE VALLEY.

ROOF GUTTERS SHALL BE PROVIDED WITH THE MEANS TO PREVENT THE ACCUMULATION OF LEAVES AND DEBRIS. (COUNTY BUILDING CODE 704A.15)

ALL ROOF VENTILATION SHALL BE APPROVED OR EQUAL TO VENTILATION MAXIMUM LTD, MODEL VMAX-101.12

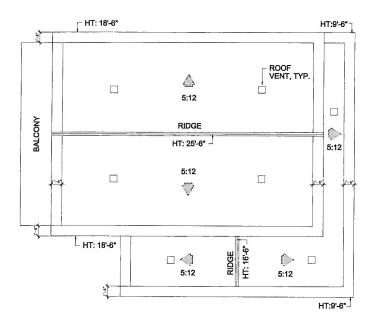

MODEL TYPE A- ROOF PLAN Scale: 1/4" =1'-0"

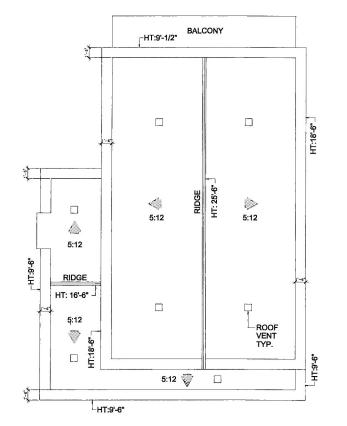

MODEL TYPE B- ROOF PLAN

Scale: 1/4" =1'-0"

HISTORY RECORDS: 7/19/19 PLANNING RESUBMITTAL PLANS PREPARED BY:

CONTACT: CECILE VILLAROSA PHONE NO.: (714) 472 519 CECILEGOP DBS COM

OWNER:

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DEVELOPMENT S. SAN ANTONIO AVENUE POMONA CA 91766 APN: 8327 001 004 ANTONIO APN:


DRAWING CONTENT:

MODEL HOUSE TYPE A & B ROOF PLANS

SHEET NO.

A5



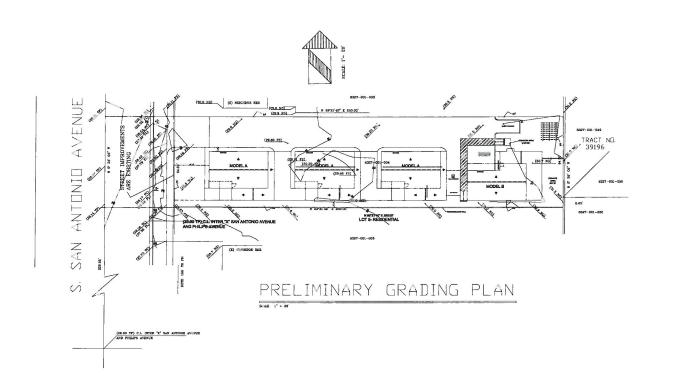

HISTORY RECORDS:

PLANS PREPARED BY:



CONTACT: CECILE VILLAROSA PHONE NO.: (714) 472.0519 CECILEGCRYDBS.COM

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ANTONIO DEVELOPMENT

S. SAN ANTONIO AVENUE POMONA CA 91766 APN: 8327 001 004


DRAWING CONTENT:

PRELIMINARY GRADING PLAN

SHEET NO.

GR1




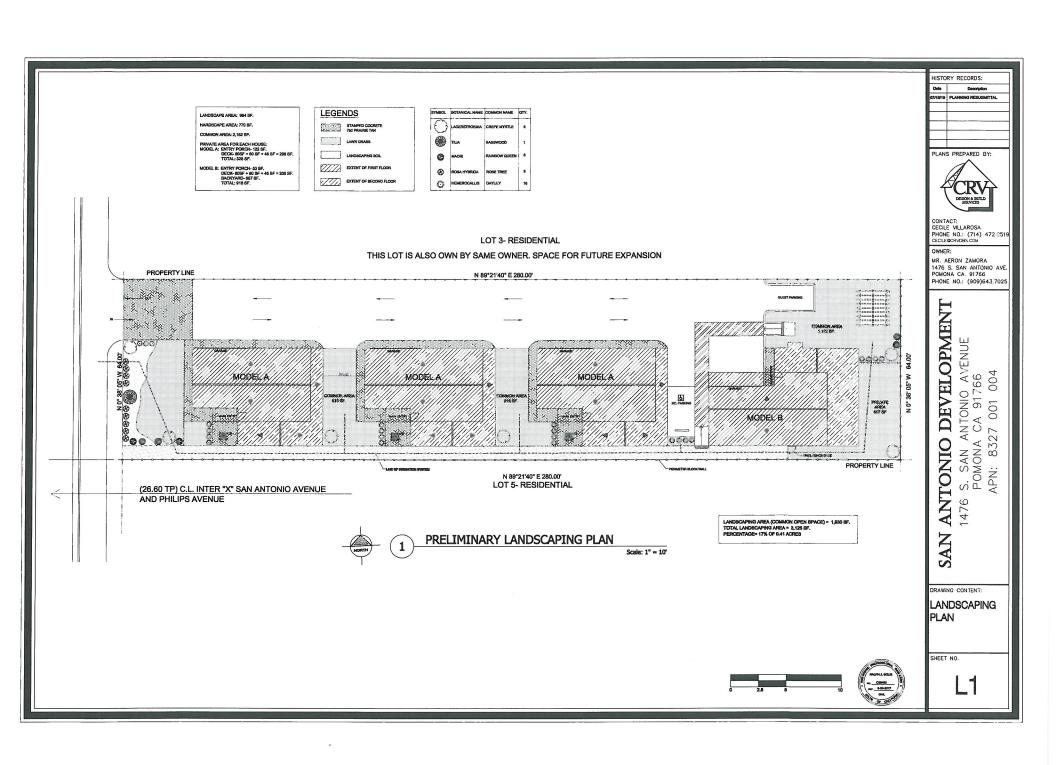



1

ASPHALT SHINGLES ROOFING. ICC# ESR-1717 OWENS CORNING SUPREME- ESTATE GREY 3-TAB ROOF SHINGLES

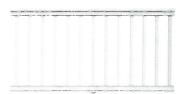

6

WOOD RAILING, PAINTED WHITE PRO RAIL WHITE HANDRAIL



10

4" DECORATIVE CAP/ TRIMS RCP BLOCK & BRICK



2

EXTERIOR WHITE SOLID WOOD DOOR PRIMNED WOOD ENTRY DOOR WITH DECORATIVE GLASS



3

EXTERIOR WOOD SIDING JAMES HARDIE 8.25-IN X 144-IN-HZ5 HARDIEPLANK CEDARMILL LAP SIDING 1 COLOR FOR EACH UNIT



4

WHITE VINYL WINDOW ANDERSEN SLIDING WINDOW



5

GLASS SLIDING DOOR STANLEY DOOR, GLACIER WHITE LOW-E SLIDING PATIO DOOR

maandee







Beach Blend




Arapaho

11


FASCIA BOARD, PAINTED WHITE ALUMINUM FASCIA BOARD, PAINTED WHITE

7 STONEWORK-1 STONEWORK FOR EACH UNIT RCP BLOCK & BRICK

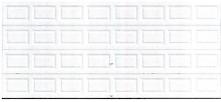

8

WHITE MECHANICAL ROLL UP DOOR PANEL CLOPAY GARAGE DOOR

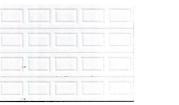

9 CHIMNEY- STUCCO FINISH TO MATCH EXTERIOR WALL 1 COLOR FOR EACH UNIT- OMEGA STUCCO COLORS

THE SECOND



12

GARAGE DOOR EXTERIOR MOLDING, WHITE GARAGE DOOR TRIM, PAINTED WHITE



SHEET NO.

COLOR BOARD

ANTONIO DEVELOPMENT

S. SAN ANTONIO AVENUE POMONA CA 91766 APN: 8327 001 004

1476

DRAWING CONTENT:

HISTORY RECORDS: Data Description 7/19/19 PLANNING RESUBMITTAL

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- 1. THE ELECTRICAL CONTRACTOR SHALL VISIT THE SITE OF THE WORK AND THOROUGHLY FAMILIARIZE HIMSELF WITH THE WORKING CONDITIONS AND THE EXACT NATURE AND EXTENT OF THE WORK TO BE DONE, TAKING INTERPRETARIES FECULIER TO THIS JOB.
- 2. CONTRACTOR SHALL OBTAIN AND PAY FOR ALL NECESSARY ELECTRICAL PERMIT.) PRIOR TO 18 START AND OBTAIN PS WER IN SECTION FROM DEPARTMENT OF BUILDING AND SEFTY.
- 3. ALL ELECTRICAL INSTALLATION SHALL COMPLY WITH THE APPLICABLE ELECTRICAL CODE OF CITY OF POWONA, CAUFORNIA ELECTRICAL CODE DUBG, TILE 24 OF STATE OF CALIFORNIA AND OTHER APPLICABLE ONDINANCES AND STATUTES.
- 4. DIERCURRENT PROTECTION AND DISCONNECTING MEANS FOR ALL MCTUPS SHILL BE INSTALLED TO COMPLY WITH ELECTRICAL CODE AND EQUAL TO MOTOR M.P.
- 5. EXECT LOCATION OF ALL EQUIPMENT SHALL BE VERIFIED IN THE FIELD OF FIDUTING OF CONDUITS SHALL SUIT FIELD CONDUITIONS.
- 6. ALL ELECTRICAL EQUIPMENT DUTD $\mathbb{O} \mathbb{R}^n$ SHALL BE WEATHERPROXE, AND LISTED FOR THE PURPOSE.
- 7. IT IS THE INTENT OF THOSE DRAWN'S THAT THIS BE A COMPLETE ELECTRICAL OID. ANY TERM'S DR OMESSIONS SHALL BE BERJUCHT TO THE ELECTRICAL OID. ANY TERM'S DR OMESSIONS SHALL BE BERJUCHT TO THE FALLS TO INFORM ARCHITECT/SHOWERE OF ANY TOOCEPRANCES PRIOR TO BIDDOING ANY TERRORS OR OMNIMINES WHICH IS DIEMED NECESSARY TO BE PART OF A COMPLETE LELETRICAL WORK AS MANDATED BY ANY TOOLS, CODE OR OTHER GOVERNING AUTHORITIES SHALL BE INSTALLED BY THE INSTALLING ELECTRICAL DOTHRACES AT AN ADDITIONAL OST TO THE OMESSIA.
- © CONTACT FOR ER AND TELEPHONE CO AND PROVIDE AND INSTALL SERVICES AS PER UTILITY CO. REQUIREMENTS AT NO ADDITIONAL COST TO THE OWNER, PAY FEES.
- 9. THE CONTRACTOR SHALL EXAMINE THE CONTRACT PLANS IN ORDER TO LOCKALLY LOCATE NORTH OF CROINATION WITH CONSTRUCTION SUCH AS CADNETS, BEAMS, FURRING DOOR SWING STC.
- 1 . DNDUITS SHALL BE CLEAN OF WATER, DEBRIS, AND OTHER FOREIGN MATERIAL PRIOR TO PULLING CONDUCTORS.
- 11. CONDUITS WHICH ARE INSTALLED AT THIS TIME AND LEFT EMPTY FOR FUTURE USE, INCLUDING TELEPHONE AND INTERBOMMUNICATION SYSTEM, SHALL HAVE #12 GALVANIZED PULL WIRE LEFT IN PLACE FOR FUTURE.
- 12 THE ELECTRICAL CONTRACTOR SHALL BE RESPONSIBLE FOR PROPER PHASING OF THE BRANCH CIRCUITS INSIDE PANELBOARD(S).
- 13. ALL PANELS SHALL HAVE HINGED DICK AND SHALL HAVE LICKABLE DOORS. "NSTALL A TYPEWRITTEN DIRE TORY IN ALL PANEL"
- 14. ALL CONTROL WIRING FOR THE A C AND HEATING SHALL BE OF 500 INSULATION, MINIMUM NO. 14 A C. COPPER.
- 15. ALL MIRING SHALL BE TYPE THHN OR THWN 650 VOLTS UNLESS NOTED OTHERWISE.
- 16. THERMOSTATS SHALL BE MOUNTED ON 4S X 1-1/2" DEEP J-00X.
- 17. BOND ALL METALLIC GAS AND WATER PIPING FOR CONTINUITY PER N.E.C. PREVAILING EDITION.
- 18. SEE ARCHITECTUR & REFLECTED CEILING PLAN FOR EXACT LIGHTING FIXTURES LOCATION.
 - 19. ROOF ALCESS IS PROJUDED. SEE ARCHITECTURAL PLAN.
- 2" CHECK WITH MECHANICAL FOR ACTUAL NO. OF CONTFUL WIRE TO A/T UNIT AND TIMECLOCK. CINTRACTUR TO PROMDE AND INSTALL TIMECLOCK AND RECURSED BY WECHANICA, CONTRACTOR FOR A/C UNIT IN ACCORDANCE TO TITLE 24 PRIOR TO START OF WORK. ELECTRICAL CONTRACTOR SHALL WRITEY WITH A/C CUNTRACTOR THE ELECTRICAL CONTRACTOR SHALL FOR THE A/C WART AND HEATING SYSTEM. ELECTRICAL CONTRACTOR SHALL FOR THE A/C WART AND HEATING SYSTEM. ELECTRICAL CONTRACTOR SHALL FOR MICE AND PER ALL SYSTEM. ELECTRICAL CONTRACTOR SHALL FOR MICE AND OPER ALL SYSTEM. PROMISE LY Z. CO. WART A/C WART TO MARKE A COMPLETE AND OPER ALL SYSTEM. PROMISE LY Z. CO. WART A/C WART TO MERMOSTALT SEE MICHANICAL HAND DRAWNOST FOR CONTROLS WARRED GUNGAN, AND PART OF THIS WORK.
- 21. ALL FEEDER AND BRANCH CIRCUIT COMPUCTOR, ARE BASED ON COPPER CONDUCTOR RATING.
- 22 . INTR. TOR SHALL BE RESPONSIBLE FOR CODERING PROPER TYPES OF TRIM FOR ALL RECESSED FLUORESCENT FIXTURES AND INCOMPESSION FIXTURES FOR THE FIXTURE FOR THE FIXTURE FOR THE FIXTURE FOR THE FIXTURE FIXTURES FOR THE FIXTURE FIXTURE FOR THE FIXTURE FIXTURE
- $\ensuremath{\mathbb{R}^3}$ all fixtures shall be u.l. usted and approved for the purpose.
 - 24. ACRYLIC LENS SHALL BE 100 % PURE, VIRGIN ACRYLIC.
- 25 ALL LIGHTIM: FIXTURES SHALL BE INSTALLED PER MANUFACTURERS INSTRUCTIONS.
- 21 RECESSED FIXTURES SHALL BE PRE-WRED TO ATTACH J-BOX IN MODANCE WITH LOCAL DUE REQUIREMENTS. FIXTURES SHALL BE APPROVED FOR MAXIMUM NUMBER OF WIRES GOING IN AND OUT OF THE FIXTURE AS SHOWN ON PLANS.
- 27 CONTRACTOR SHALL VERIFY THE TYPE OF CEILING BEFORE UNDERING ANY FIXTURES. HE IS FULLY RE FONSIBLE TO PROMIDE ALL MULTIMOS BRUNCH'S, CELING CUIDITIONS, AT NO EXTRA CHARGE TO THE OWNER.
- B PROMES GROUNDING CONDUCTOR FOR FLEXIBLE METALLIC CONDUIT SUPPLIED BY JOA C.C.P. OF LEIN & THE COMBINED LENGTH OF FLEXIBLE METALLIC TUBING & LIQUID TROHT FLEXIBLE CONDUIT IN THE SAME SOUND RETURN PATH DOES NOT EXCEED 6 FT PER NEC SEC. 250-113(b) & (5).
- 27 ALL OUTLET BUYES MUST BE SIZE PER CODE SECT. 370-16 AND 370-18. MINIMUM SIZE TO BE 4" TRADE SIZE.
- 30 ALL CONDUITS SHALL BE RUN CONCEALED UNLESS NOTED OTHERWISE

- M. FROM EXIT, TIME PANELBOARDS RECESSED IN WALLS THAT IS RELOCATED. STUDE TWO E .** CONDUITS INTO ACCESSIBLE COLLING SPACE FOR FUTURE USE. LABEL "SPARE".
- .52 TERMINATE ALL TELEPHONE HOME-RUNS AT TELEPHONE BACKBOARD.

I, I, AMMUN IS DIAGRAMMATIC AND INDICATES THE LICE ATOM OF OUTLETS AND EQUIPMENT AND THE CIRCULAT ARRANGEMENT OF THE REQUIRES WARING, AND THOUGH NOT INCESS SMILLY INDICATIONS THE RECURSES OF THE CINDICATION. THE DRAWING SHALL BE FOLLOWED AS CLOSELY AS PROPER COURDINATION WITH THE WORK OF THEIR TRAD AND SPACES ANALAGEE WILL ESTABLISHMENT.

- 1. DESCRIPTION NAMES. WHEN SECURIC NAMES ARE NOT STATED. ONLY THE BEST AVAILABLE QUALITY OF MATERIAL OR EQUIPMENT SHABE SUBMITTED FOR REVIEW AND USED IN THE INSTALLATION.
- 2. TREAMENT OF MANES MATERIALS SMALL CARDLY WITH THE RECEIVED MORE THE PROGRESS MERCET THE PROGRESS MERCET THE PROGRESS MERCET THE PROGRESS OF WORKS OF SMALAR MENT AS USED IN REFORMED TO MATERIAL OR EQUIPMENT, AND PROGRESS OF STORY AND CONSTRUCTION ONLY AND COMMISSION OF SMALL SMAL
- 3. WHERE NAMES OF SELECTED MANUFACTUREPS AND CERTAIN THES OF MATERIALS ARE SHOWN OR SPECIFIED WITHOUT THE USE OF THE ABOVE PROFILED THE CONTROL SHALL BASE HIS PROFILED, AND WORK ON USE OF THE SELECTED PROFILETS AND ONLY SUCH PROFILETS SHALL BE SUBMITTED FOR REWEW.

1. WICK AND MATERIALS COVERED BY THIS SPECIFICATION SHALL BE URBUCH TO INSPECTION AT ANY TIME BY PEPPESSNITATIONS OF CONTRIBUTION ANY MATERIAL NOT COMPARE MAIN TO STALL WITHIN THREE DAYS AFER BEING MOTHED BY CONTRIBUTIONS AND METERS AFER BEING MOTHED BY METERS AFER BEING MOTHED BY METERS AFER BEING MOTHED BY METERS AND METERS AND METERS AFER BEING MAIN AND REVIEWS BEEN METERS. THE EXTREMELY AND STALL BE BURNE BY THE CHITTAE FOR

F. TREMICTING, BACKFILL AND PATCHING

1. THE ELECTRICAL CONTRACTOR SHALL DO ALL TRENCHING AND BACKFILL NECESSARY IN CONNECTION WITH HIS WORK. THE ELECTRICAL CONTRACTOR SHALL REPAIR AND DAMAGE DONE TO THE WORK OF CHIEFARDES. SAM CUTTING AND PATCHING OF EXISTING A.C. PAVING. IF REQUIRED, SHALL BE DONE BY THE GENERAL CONTRACTOR

1. CONDUITS
RIGH STEEL CONDUITS SHALL BE USED FOR CONDUIT CAST IN CONJECTE
OR CONCEALED INSIDE THE MANDARY, EXPORED OR CUILDING INTERIOR
WITHIN B FT ABOUR FLOOR STUD, EXPORED ON EXTERNIX OF BUILDING,
LOCATED IN MEY OR DAMP AREAS, LOCATED ABOVE EXTERNIX HUNG
CELLING, OR SWETTS OR CANDRES.

CELINES, OR SERTIS OR CANDRES.

MON METALLIC CONDUIT SALE BUSICD FOR UNCORPORATION FIN BYINGS AND INSERT SHALL BE GOOD STEEL CONDUIT RISER SHALL TERMINATE AT PANELS AND PULL SHOKE WITH DOUBLE LOCKOUTS AND INSLATED GROUND BUCHING CUPPER CROUND WIRE SHALL BE INSTALLED IN CONDUIT SHALL BE INSTALLED IN THE COURS AND FOLKE SHALL BE INSTALLED IN THE COURS AND FOLKE OF TH

CHITLET AND JUNCTION BOXES USED IN CONCEALED WORK, EXCEPT MAY "INRY, SHALL BE GAL VANIZED OR SHERARDIZED ONE-PIECE, PRESIDED THEEL, KNOCK-JUT TYPE SIZED IN ACC MICH THE CODE FOR THE NUMBER OF CONDUCTORS OR THE NUMBER AND SIZE OF CONDUITS ENTERING THE BOX, BUT SHALL NOT BE LESS THAN 4" SOUARE AND 1-1/2" DEEP.
PLASTER RING SHALL BE PROVIDED FOR ALL FLUSH MOUNTED BOXES.

UTLET AND JUNCTION NOXES USED OUTSIDE OF BUILDING, ON ROOF, ON IN LAM LAPED AREA "HALL BE CAIT ALUMINUM AS MANUFACTURED BY CROUSE-HINDS TYPE "FS" OR EQUAL WITH COMBUIT HUBS AY REQUIRED.

CONDUCTORS SHALL BE COPPER #12 AND MINIMUM UNLESS SPECIFICALLY NOTED OTHERWISE ON DRAWING

CONDUCTORS #10 A = G AND SMALLER SHALL BE SOLID AND #8 AW? AND LARGER SHALL BE STRANDED UNLESS SPECIFICALLY NOTED OTHERWISE ON DRA HNUS.

CONDUCTORS SHALL HAVE TYPE THWN/THHN, 600 VOLT, INSULATION

MALL SE 20 AMPERE, 125 MOLT A.C., HUBBELL # 5352-1 OR EQUAL BY HERMA, HATER, LEWTON, BRYANT OR ARROW—HART UNLESS INDICATED OTHER NUE ON DRAWNING SPECIAL RECEPTACLES SHALL BE AS INDICATED ON DRAWNING.

SHALL BE HUBBELL # 1 3 - 1 (SINCLE POLE) AND # 1223-1 (3-WAY)
OR EQUAL BY SIERRA, SLATER, LEVITON, BRYANT, OR ARP W-HART

SHALL BE SMOOTH THERMOPLASTIC, STANDARD SIZE FOR ALL SWITCHES, PECCEPACLES, TELEPHONE, AND BLANKED OUTLETS. PLATE'S SHALL HAVE THE SAME MAINTACTURER AS RECEPTACLES AND WALL SWITCHES WAS THERPROOF RECEPTACLES SHALL HAVE HUBBELL & WIZE OR EQUAL UFT CHEER PLATES.

SHALL HAVE THE TYPE AS INDICATED ON LIGHTING FIXTURES SCHEDULE AND SHALL BE UNDERWRITERS' APPRIOVED.

- A PROVIDE LAM. FOR EACH FIXTURE. LAMPS SHALL BE MANUFACTURED BY CENERAL ELECTRIC COMPANY, SYLVANIA OR WESTINGHOUSE WHILLINGS.
- 8. P20. DE PILOT, ANNUNCIATOR AND THER MISCELLANEOUS LAMP FOR PRODUCTS FURNISHED AT PART OF THE ELECTRICAL WORK.
- 8. 120/208 WOLT PANELEDARDS CIRCUIT BREAKERS
- OOB CIR UIT BREAKER TYPE COURSE D OR EQUAL) FOR 3 PHASE, 4 WIRE OR DINDED NEUTRAL SEPTICE.
- O. CIF OUT BREAKERS SHALL HA E THE FOLLOWING CHAR CTERISTICS
- 6.1 BOLTED ON MOLDED CASE DOB FRAME 120/240 WOLT TYPE, WITH AN INTERRUPTING CAPACITY OF 10,000 AMPERES IMM SYMMETRICAL.

0.2 SINULE OR TWO POLE TRIP SETTINGS SHOWN ON THE DRAWINGS OF PANEL SCHEDULES.

07/19/18 PLANNING SUBMITTAL

HISTORY RECORDS

PLANS PREPARED BY:



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MR. AFEON ZAMORA 1476 S. SAN ANTONIO AT OMONA CA. 91766 PHONE NO.: (909)643.7025

0 DEVEL NTONIO

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CA

AVENUE, POMONA, 8327 001 004

ANTONIO /

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DRAWING CONTENT:

ELECTRICAL **SPECIFICATIONS**

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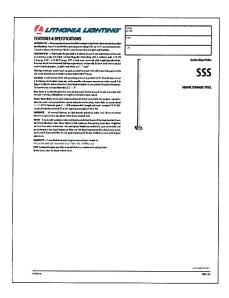
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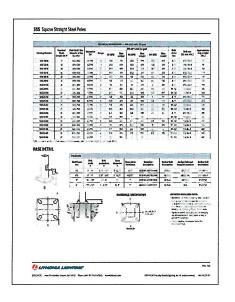
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Arnel de Silva & Associates Consulting Engineers

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	(7)
	N. T.S. FIXTURE TYPE (A)
	ļ I
25 FT. HIGH SQUARE POLE WITH FINISH TO MATCH FIXTURE	COORDINATE WITH MANUFACTURER PRIOR TO ORDERING FOR PROPER CUTOFF TO ADJACENT PROPERTIES AND FOR MOST EFFECTIVE AREA LIGHT DISTRIBUTION.
GROUNDING LUG.	
TERMINATE CONDUITS AT BOTTOM OF HANDHOLE WITH BUSHING	HANDHOLEWITH FLUSH COVER CAST, BASE PLATE
BASE COVER -	-3/4" CHAMBER ALL AROUND
	(4) 1"X36"X4" ANCHOR BOLTS WITH LEVELING AND ANCHOR NUTS
1.1.1	(A) #6 VERTICAL REBAR
 1 	4 HORIZONTAL REBAR TIES AT 12" O.C.
[[4.1	FINISHED GRADE OR PAVING
**************************************	†¦ <i>>>>***</i>
Thi	CONDUCTORS IN PVC CONDUCTS
	CONCRETE BASE, (3000 p.s.l. 0 28 DAYS BUILDING GRADE
	CONCRETE), EXPOSED PORTION SHALL BE TROWELED SMOOTH 3" MIN. CLEAR FORM REBAR (TYPICAL)
Ų	. ,

POLE	MOUNTED	FIXTURE	DETAIL
NO SCALE			

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FIXTURE DESIG.	-	_	HPS	OTHER	-	TYPE	DESCRIPTION	FINISH	MOUNTING
(A)				×	,	LED	KAD LED AREA LUMINAIRE WITH TENDN MOUNTING SUPSTITER FROM LITHONIA CAT NO. KAD LED 40C 1000 40K R4 MYOLT HS		POLE
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Arnel de Silva & Associates
Consulting Engineers

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650-401-4168

HISTORY RECORDS:
Date Description
07/19/18 PLANNING SUBMITTAL

PLANS PREPARED BY:



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MR. AERON ZAMORA 1476 S. SAN ANTONIO AVE. POMONA CA. 91766 PHONE NO.: (909)643.7025

ONE NO.: (909)643.7


SAN ANTONIO DEVELOPMENT
1476 S. SAN ANTONIO AVENUE. POMONA, CA 91766
APN: 8327 001 004


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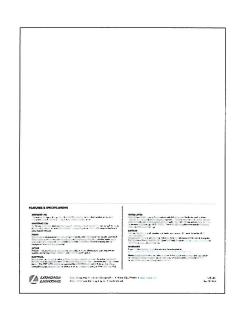
ELECTRICAL FIXTURES SCHEDULES & CUT SHEET


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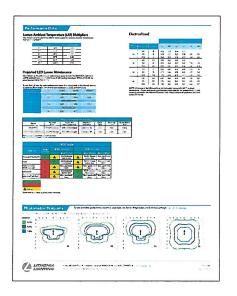
E2





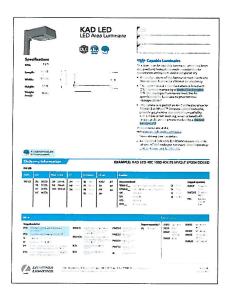

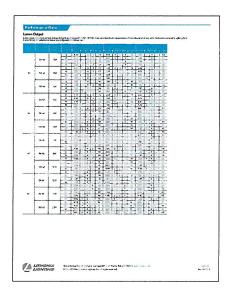

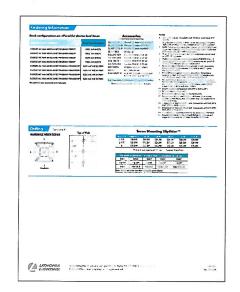



ANTONIO DEVELOPMENT SAN

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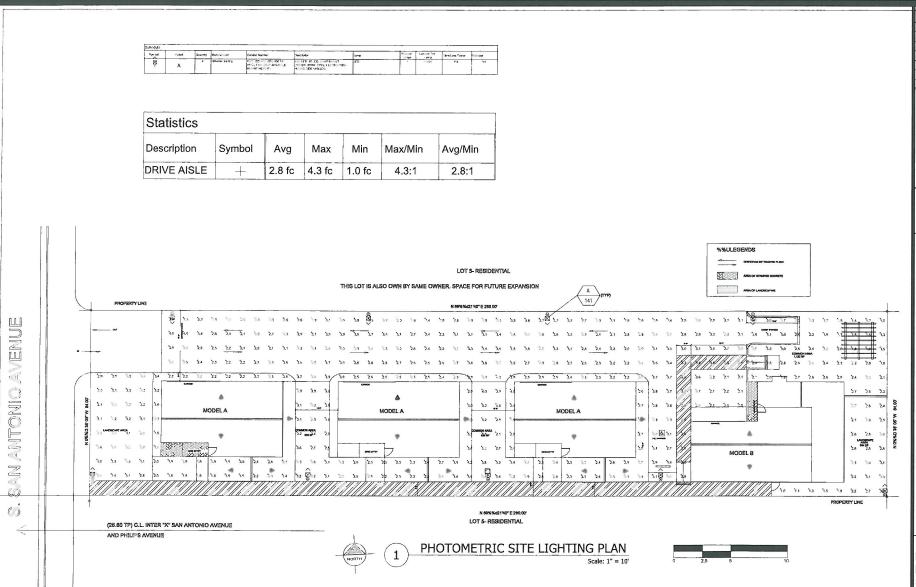
91766 CA

SAN ANTONIO AVENUE, POMONA, APN: 8327 001 004 တ်

DRAWING CONTENT: **ELECTRICAL CUT SHEET**

SHEET NO

E3



E ANTONIO DEVELOPMENT ANTONIO AVERNUE PONCHO PONCHO

HISTORY RECORD⁴:

Date Description

7/19/18 PLANNING SUBMITTAL

PLANS PRETARED BY:

CONTACT:

CECILE VILLAROSA

PHONE NO.: (714) 472,0519

DRAWING CONTENT:

ELECTRICAL PHOTOMETRIC SITE LIGHTING PLAN

SHEET NO.

Arnel de Sih a & Associates Consulting Engineers

E4

