THE COLLECTION AT MOUNTAIN CRES 1137 AND 1149 WEST PHILLIPS BLVD **POMONA CA 91766**



			NO. REVISION DATE
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			ST HILLS NSIDE TRUS
	SCOPE OF WORK MERGE TWO LOTS AND NEW CONSTRUCTION OWNER'S INFORMATIC KHURSHID KHAN TRUSTEE OF THE WEST COAST OCEANSIDE 16392 E. EDNA PLACE COVINA, CA 91722 PHONE: 310-779-5226 PROJECT TEAM ARCHITECTURE: JH DESIGN CONTACT: JACKSON HUANG PHONE: 626-230-4729 EMAIL: jh.design@outlook.com	N	ECTION AT MOUNTAIN CREST HILLS 1149 WEST PHILLIPS BLVD. CA 91766 OF THE WEST COAST OCEANSIDE TRUST DNA PLACE SA 91722
AVE. 2	LAND SURVEYING AND EGNINEERING CONTACT: FLORENTINO FERRER PHONE: 626-437-0038 EMAIL: tinoferrer@yahoo.com CIVIL: KM ASSOCIATES CONTACT: MICHAEL SANTOS PHONE: 323-470-0181 CIVIL: mikehermosa@hotmail.com LANDSCAPE: TWO TREES DESIGN INC.		TTHE COLLI 1137 AND POMONA, 16392 E. El COVINA, C
	CONTACT: CAMILLE PERNG PHONE: 626-278-2766 EMAIL: prunus@gmail.com		PROJECT OWNER:
	BUILDING CODE		CONSULTANT
PROJECT SITE COURTY OF LOS AMERES, GALIF.	2019 CALIFORNIA BUILDING CODE 2019 CALIFORNIA RESIDENTIAL CODE 2019 CALIFORNIA ELECTRICAL CODE 2019 CALIFORNIA MECHANICAL CODE 2019 CALIFORNIA PLUMBING CODE 2019 CALIFORNIA FIRE CODE 2019 CALIFORNIA ENERGY CODE 2019 CALIFORNIA ENERGY CODE 2019 CALGREEN CO CITY OF POMONA, MUNICIPAL CODE		
	PROJECT DATA		
	ASSESSOR'S ID NO.: 8343 8343 ZONE: R-2 S LOT AREA: 3716	/NHOMES -012-015 -012-016 S OVERLAY 4 S.F.	
		FL. 902 S.F. PER UNIT FL. 1,232 S.F. PER UNIT	
	ΤΟΤ/	AL : 2,134 S.F. PER UNIT S.F. PER UNIT	JOB NO :
	2ND. TOT/	FL. 858 S.F. PER UNIT FL. 1,232 S.F. PER UNIT AL = 2,090 S.F. PER UNIT	DATE : 07-29-2021 1ST REV :
	COMMON OPEN SPACE REQUIRED: 6,000	S.F. PER UNIT) S.F. 3 S.F.	DRAWN : JH/MS PLOTTED : -
	UNIT 1 TO UNIT 12 PRIVATE OPEN SPACE 1ST UNIT 1 TO UNIT 12 PRIVATE OPEN SPACE 1ST	FL. REQUIRED: 150 S.F. PER UNIT	SCALE : AS SHOWN
	UNIT 1 TO UNIT 12 PRIVATE OPEN SPACE 2ND UNIT 1 TO UNIT 12 PRIVATE OPEN SPACE 2ND	FL. REQUIRED: 90 S.F. PER UNIT	
	LANDSCAPE AREA: 8124 GUEST PARKING: 3 SP.	S.F. ACES	PLAN
	SHEET INDEX: A-1.0 TITLE SHEET AND SITE PLAN C-1. CIVIL GENERAL NOTES C-1.0 SURVEY PLAN C-2.0 SITE CONTROL PLAN C-3.0 GRADING PLAN C-4.0 UTILITY PLAN L-1.0 LANDSCAPE PLAN A-1.1 NEW SITE ELEVATIONS A-1.2 SITE ROOF PLAN A-1.3 OPEN SPACE AND FIRE LANE DIAGRAM A-2.0 NEW UNIT 1 AND UNIT 2 FIRST FLOOR P A-2.1 NEW UNIT 3 TO UNIT 12 FIRST FLOOR P A-2.2 NEW UNIT 1 AND UNIT 2 SECOND FLOOF A-2.3 NEW UNIT 3 TO UNIT 12 SECOND FLOOF A-3.0 TYPICAL EXTERIOR ELEVATIONS A-3.1 TYPICAL EXTERIOR ELEVATIONS A-3.2 TYPE A UNIT 1 TO UNIT 4 EXTERIOR CO A-3.3 TYPE B UNIT 5 TO UNIT 8 EXTERIOR CO A-3.4 TYPE C UNIT 9 TO UNIT 12 EXTERIOR CO A-4.0 BUILDING SECTIONS AND BIRDS EYE VI A-5.0 COLORS AND MATERIALS MOTHERN, WESTERN, AND EASTERN PROJE REFER TO NOISE AND VIBRATION STUDY FOR	PLANS LANS R PLANS R PLANS LOR ELEVATIONS LOR ELEVATIONS COLOR ELEVATIONS IEW PERSPECTIVE	TITLE SHEET / SITE
			A
ET / SITE PLAN		SCALE : 1/16" = 1'-0"	1 1.0

GENERAL NOTES:

- WORK SHOWN HEREON SHALL BE DONE IN ACCORDANCE WITH THE "STANDARD PLANS & SPECIFICATIONS FOR PUBLIC WORKS CONSTRUCTION", LATEST EDITION AND SUPPLEMENTS.
- WORK SHOWN HEREON SHALL BE DONE IN ACCORDANCE WITH THE "STANDARD SPECIFICATIONS FOR PUBLIC WORKS CONSTRUCTION," LATEST EDITION AND SUPPLEMENTS, THE UNIFORM BUILDING CODE (EXCAVATION AND GRADING), AND CITY OF POMONA LOCAL ORDINANCES AS APPLICABLE.
- 3. ALL GRADING WORK SHALL BE PERFORMED IN ACCORDANCE WITH THE REQUIREMENTS.
- 4. IT IS SHOWN AS PART OF THIS PLAN FOR REFERENCE ONLY. ANY DISCREPANCIES ONSITE SHALL BE REPORTED BY THE CONTRACTOR TO THE CONSTRUCTION MANAGER PRIOR TO CONSTRUCTION.
- THE CONTRACTOR SHALL ASSUME SOLE AND COMPLETE RESPONSIBILITY FOR THE JOB SITE CONDITIONS, INCLUDING SAFETY OF ALL PERSONS AND PROPERTY, DURING THE COURSE OF CONSTRUCTION OF THIS PROJECT. THIS REQUIREMENT SHALL APPLY CONTINUOUSLY, AND SHALL NOT BE LIMITED TO NORMAL WORKING HOURS.
- PRIOR TO COMMENCING CONSTRUCTION, CONTRACTOR SHALL HIRE A LICENSED LAND SURVEYOR TO VERIFY THAT THE ELEVATIONS SHOWN ON THE GRADING PLAN AT THE JOIN TO THE EXISTING IMPROVEMENTS MATCHES THE EXISTING ELEVATIONS IN THE FIELD. THE CONTRACTOR SHALL IMMEDIATELY NOTIFY THE ENGINEER OF ANY DISCREPANCIES, AND SHALL NOT BEGIN CONSTRUCTION, IN THE AREAS OF DISCREPANCIES UNTIL THE CHANGED CONDITIONS HAVE BEEN EVALUATED.
- PRIOR TO COMMENCING CONSTRUCTION, CONTRACTOR SHALL POTHOLE AND VERIFY THE VERTICAL AND HORIZONTAL LOCATION OF ALL EXISTING UTILITIES WITHIN THE LIMIT OF WORK SHOWN ON THE CONSTRUCTION DRAWINGS, INCLUDING VERTICAL AND HORIZONTAL LOCATION OF EXISTING UNDERGROUND FACILITIES AT THE POINT-0F-CONNECTIONS AND CROSSINGS WITH THE PROPOSED UNDERGROUND FACILITIES. CONTRACTOR SHALL VERIFY THE POTHOLING INFORMATION AGAINST THE CONSTRUCTION DRAWINGS AND IMMEDIATELY NOTIFY THE ENGINEER OF ANY DISCREPANCIES AND/OR CONFLICTS. THE CONTRACTOR SHALL NOT BEGIN CONSTRUCTION OF UNDERGROUND FACILITIES UNTIL THE CHANGED CONDITIONS HAVE BEEN EVALUATED.
- 8. ALL DRAWINGS ARE CONSIDERED TO BE A PART OF THE CONTRACT DOCUMENTS. THE CONTRACTOR SHALL BE RESPONSIBLE FOR THE REVIEW AND COORDINATION OF ALL DRAWINGS AND SPECIFICATIONS PRIOR TO THE START OF CONSTRUCTION. ANY DISCREPANCIES THAT OCCUR SHALL BE BROUGHT TO THE ATTENTION OF THE ARCHITECT PRIOR TO THE START OF CONSTRUCTION SO THAT A CLARIFICATION CAN BE ISSUED. ANY WORK PERFORMED IN CONFLICT WITH THE CONTRACT DOCUMENTS OR ANY CODE REQUIREMENTS SHALL BE CORRECTED BY THE CONTRACTOR AT THEIR OWN EXPENSE AND AT NO EXPENSE TO THE OWNER OR ARCHITECT.
- 9. THE ENGINEER PREPARING THESE PLANS WILL NOT BE RESPONSIBLE FOR, OR LIABLE FOR, UNAUTHORIZED CHANGES TO OR USES OF THESE PLANS. ALL CHANGES TO THE PLANS MUST BE IN WRITING AND MUST BE APPROVED BY THE PREPARER OF THESE PLANS.
- 10. NOTES AND DETAILS ON DRAWINGS SHALL TAKE PRECEDENCE OVER GENERAL NOTES AND TYPICAL DETAILS. WHERE NO DETAILS ARE GIVEN, CONSTRUCTION SHALL BE AS SHOWN FOR SIMILAR WORK.
- 11. THE EXISTENCE, LOCATION AND CHARACTERISTICS OF UNDERGROUND UTILITY INFORMATION SHOWN ON THESE PLANS HAVE BEEN OBTAINED FROM A REVIEW OF AVAILABLE RECORD DATA. NO REPRESENTATION IS MADE AS TO THE ACCURACY OR COMPLETENESS OF SAID UTILITY INFORMATION. THE CONTRACTOR SHALL TAKE PRECAUTIONARY MEASURES TO PROTECT THE UTILITY LINES SHOWN AND ANY OTHER LINES NOT OF RECORD OR NOT SHOWN ON THESE PLANS.
- 12. IF AT ANY TIME DURING GRADING OPERATIONS, ANY UNFAVORABLE GEOLOGICAL CONDITIONS ARE ENCOUNTERED, GRADING IN THAT AREA WILL STOP UNTIL APPROVED CORRECTIVE MEASURES ARE OBTAINED.
- 13. THE PROPOSED GRADE IS THE FINAL GRADE AND NOT THE ROUGH GRADE. THE CONTRACTOR SHALL SUBTRACT THE THICKNESS OF THE PAVED SECTION AND/OR LANDSCAPE TOPSOIL SECTION TO ARRIVE AT THE ROUGH GRADE ELEVATION.
- 14. STRAIGHT GRADE SHALL BE MAINTAINED BETWEEN CONTOUR LINES AND SPOT ELEVATIONS UNLESS OTHERWISE SHOWN ON THE PLANS.
- 15. ALL DEBRIS AND FOREIGN MATERIAL SHALL BE REMOVED FROM THE SITE AND DISPOSED OF AT APPROVED DISPOSAL SITES. THE CONTRACTOR SHALL OBTAIN NECESSARY PERMITS FOR THE TRANSPORTATION OF MATERIAL TO AND FROM THE SITE.
- 16. ALL FILL SOILS OR SOILS DISTURBED OR OVEREXCAVATED DURING CONSTRUCTION SHALL BE COMPACTED PER THE REQUIREMENTS OF THE SOILS REPORT BUT NOT LESS THAN 90% MAXIMUM DENSITY AS DETERMINED BY A.S.T.M. SOIL COMPACTION TEST D-1557.
- 17. THE CONTRACTOR SHALL OBTAIN AN O.S.H.A. PERMIT FROM THE CALIFORNIA DIVISION OF INDUSTRIAL SAFETY PRIOR TO THE CONSTRUCTION OF TRENCHES OR EXCAVATIONS WHICH ARE FIVE FEET OR DEEPER.
- 18. DIMENSIONS TO PIPE LINES ARE TO CENTERLINE UNLESS OTHERWISE NOTED.
- 19. ALL WATER LINES SHALL BE INSTALLED WITH 36" MINIMUM COVER FROM TOP OF PIPE TO FINISHED GRADE, UNLESS OTHERWISE NOTED
- 20. THRUST BLOCKS SHALL BE INSTALLED AT WATERLINE HORIZONTAL AND VERTICAL BENDS, TEES, CAPPED ENDS AND REDUCERS ACCORDING TO THE DETAILS PROVIDED ON THESE PLANS.
- 21. CONSTRUCTION STAKING FOR IMPROVEMENTS SHOWN ON THESE PLANS SHALL BE PERFORMED BY A LICENSED LAND SURVEYOR. 22. THE CONTRACTOR SHALL REPLACE ALL EXISTING IMPROVEMENTS DAMAGED DURING CONSTRUCTION TO MATCH EXISTING,
- 23. CONTRACTOR TO CONTACT UNDERGROUND SERVICE ALERT (800-227-2600) PRIOR TO EXCAVATION.
- 24. ALL DIMENSIONS ARE IN FEET OR DECIMALS THEREOF.

INCLUDING PERMANENT TRENCH RESURFACING.

- 25. ALL CURB DIMENSIONS AND RADII ARE TO PAVEMENT FACE OF CURB.
- 26. CONTRACTOR TO BE AWARE OF ALL OVERHEAD LINES AT ALL TIMES, SO AS NOT TO DISTURB THEM.
- 27. WATER SHALL BE PROVIDED ONSITE AND USED TO CONTROL DUST DURING CONSTRUCTION OPERATIONS.
- 28. CONTRACTOR SHALL OBTAIN ANY NECESSARY PERMITS FROM THE CITY OF PASADENA FOR ALL WORK WITHIN THE PUBLIC RIGHT-OF-WAY.
- 29. STORM DRAINAGE SYSTEMS SHOWN ON THESE PLANS HAVE BEEN DESIGNED FOR THE FINAL SITE CONDITION AT COMPLETION OF THE PROJECT. THE CONTRACTOR IS RESPONSIBLE FOR MAINTAINING ADEQUATE DRAINAGE OF THE SITE, DURING INTERIM CONDITIONS OF CONSTRUCTION.
- 30. CONTRACTOR SHALL OBTAIN ALL REQUIRED PERMITS, INCLUDING NPDES, FROM THE APPROPRIATE JURISDICTIONAL AGENCIES FOR DISCHARGE OF GROUNDWATER THAT MAY BE NECESSARY TO ACCOMPLISH EXCAVATIONS SHOWN ON THESE PLANS.
- 31. BLANKET PROTECTION SHALL BE PROVIDED FOR ALL UTILITY PIPES AND CONDUITS UNDER DRIVEWAYS, ROADWAYS, PARKING LOTS, AND OTHER VEHICULAR PATH OF TRAVEL PER APWA STANDARD PLAN 225-1 WHERE THE MINIMUM COVER OVER THE PIPES AND CONDUITS IS LESS THAN 36".
- 32. CONTRACTOR SHALL ADJUST ALL EXISTING UTILITIES SUCH AS MANHOLE COVERS, CLEAN OUTLET COVERS, METER BOXES, PULL BOXES, VALVE BOXES, AREA DRAINS, CATCH BASINS, FIRE HYDRANTS AND OTHER SURFACE UTILITIES TO NEW FINISH GRADE. NOT ALL EXISTING SURFACE UTILITIES MAY HAVE BEEN IDENTIFIED ON THESE PLANS THAT MAY REQUIRE ADJUSTMENT TO NEW GRADE, THE CONTRACTOR SHALL BE RESPONSIBLE
- TO VISIT THE SITE TO FULLY ACKNOWLEDGE, UNDERSTAND AND INCLUDE THE EXTEND OF WORK REQUIRED.
- 33. CONTRACTOR SHALL APPLY EXCAVATION PERMIT FROM PUBLIC WORKS PRIOR TO CONSTRUCTION OF ALL WORK IN PUBLIC-RIGHT-OF WAY. A SEPARATE PERMIT MAYBE REQUIRED BY PUBLIC WORKS TO BE SECURED FROM P.W.P. AND PASADENA D.O.T.



SECTION 4216/4217 OF THE GOVERNMENT CODE REQUIRES A DIGALERT IDENTIFICATION NUMBER BE ISSUED BEFORE A "PERMIT TO EXCAVATE" WILL BE VALID. FOR YOUR DIGALERT I.D. NUMBER CALL UNDERGROUND SERVICE ALERT TOLL FREE 1-800-227-2600 TWO WORKING DAYS BEFORE YOU DIG

GEOTECHNICAL NOTES; GRADE,

1. ALL WORK MUST BE IN COMPLIANCE WIT AND THE APPROVED GRADING PLANS AND S

2. THE GEOTECHNICAL ENGINEER IS TO APP THE CITY INSPECTOR. THE CONSTRUCTION INSPECTION BEFORE FILL IS PLACED.

3. GRADING OPERATIONS MUST BE CONDUC MONTHLY INSPECTION REPORTS TO BE SU

4. THE SOIL ENGINEER SHALL PROVIDE SUF ACCORDANCE WITH THE PLAN AND LATEST

5. ALL SITE PREPARATION AS INDICATED SH CONTRACTOR SHALL FOLLOW THAT TABLE INSPECTION IS ONLY REQUIRED FOR VERIF PLACEMENT AND COMPACTION OF CONTRO OR OAR.

6. ALL EXISTING FILL SOILS AND TOP SOIL/C

7. FOR SUPPORT OF CONCRETE WALKS ANI COMPACTION OF AT LEAST 90% AT OPTIMU

8. IN THE AREAS OF FILL, ALL SOILS SHOUL SHALL BE SCARIFIED TO A DEPTH OF ABOU CONTENT, AND COMPACTED TO AT LEAST COMPACTION METHOD.

9. PRIOR TO CONSTRUCTION. THE AREAS P INCLUDING VEGETATION, TRASH, AND DEBR LOCATE ANY EXISTING OR ABANDONED UT EITHER PROPERLY ABANDONED AND REMO EXCAVATIONS THAT RESULT FROM THE REI AND COMPACTED.

10. SITE PREPARATION . THE CONTRACTOR

11. ALL FILL SHALL BE GRANULAR IN NATUR AREAS OF COMPACTED FILL.

12. BEFORE WALL BACKFILLING, SUBDRAIN PERFORATED PIPES EMBDEDED IN ABOUT SHALL BE WRAPPED AROUND THE FREE DR INTERIOIR SUMP PUMP.

13. THE EXCAVATED SANDY SOILS FROM TH COMPACTED FILL AND WALL BACKFILL PRO

14. FILL MATERIALS, APPROVED BY THE SOI COMPACTED TO AT LEAST 90% OF THE MAX

15. THE FILL SHALL BE PLACED IN LAYERS V SPREAD EVENLY AND SHALL BE THOUROUG

16. WHEN MOISTURE CONTENT OF THE FILI THOROUGHLY DISPERSED UNTIL MOISTURE

17. WHEN THE MOISTURE CONTENT OF THE SHALL BE AERATED BY BLADING OR ORTHE

18. INSPECTION AND FIELD DENSITY TEST ADEQUATE COMPACTION IS ATTAINED. WH CONDUCT/MAKE ADDITIONAL COMPACTION

19. TEMPARARY EXCAVATION:

0-4'

>4'

WHEN SPACE LIMITATION PERMITS, UNSHC

MAXIMUM DEPTH OF CUT MAXI

20. WATER SHALL NOT BE ALLOWED TO FLOW ALLOWED WITHIN 45-DEGREES LINE DRAWN NOT SATURATED TO RETARD RAVELING AND

NOTE TO CONTRACTOR:

CONTRACTOR TO OBTAIN SEPARAT PURVEYOR(S), FOR WORK WITHIN 1 IMPROVEMENTS, STORM DRAIN, SE CONTRACTOR IS RESPONSIBLE FOR TO AGENCIES AND UTILITY OWNERS

AS THE CIVIL ENGINEER OF THE PROJECT, I HAVE REVIEWED THE DEVELOPMENT PLANNING FOR STORM WATER MANAGEMENT-A MANUAL FOR STANDARD URBAN STORMWATER MITIGATION PLAN (SUSMP), AND HAVE PROPOSED THE IMPLEMENTATION OF THE PERMANENT BEST MANAGEMENT PRACTICES (BMP'S) APPLICABLE TO EFFECTIVELY MINIMIZE THE NEGATIVE IMPACTS OF THE PROJECT'S STORMWATER RUNOFF. THE SELECTED BMP'S WILL BE INSTALLED PER THE APPROVED PLANS AND AS RECOMMENDED BY THE PRODUCT MANUFACTURER AS APPLICABLE.

AND SUBGRADE PREPARATION REQUIREMENT	
H THE RECOMMENDATIONS INCLUDED IN THE GEOTECHNICAL CONSULTANT'S REPORT(S) SPECIFICATIONS.	
PROVE THE KEY OR BOTTOM OF EXCAVATION AND LEAVE A CERTIFICATE ON THE SITE FOR N MANAGER IS TO BE NOTIFIED BEFORE ANY GRADING BEGINS AND FOR BOTTOM	
CTED UNDER PERIODIC INSPECTIONS BY THE GEOTECHNICAL CONSULTANTS WITH IBMITTED TO THE CONSTRUCTION MANAGER.	ANNOTATION
FFICIENT INSPECTIONS TO MAKE SURE THAT THE WORK IS BEING PERFORMED IN	[OR] 100.00 XX SURFACE ELEVATION/UTILITY ELEVATION
T EDITION OF CALIFORNIA BUILDING CODE.	EXISTING SURFACE ELEVATION/UTILITY ELEVATIO
HALL BE INSPECTED PER TABLE 1704 OF 2-13 CALIFORNIA BUILDING CODE. THE FOR ITEMS THAT NEED PERIODIC AND CONTINUOUS INSPECTION. CONTINUOUS	CONSTRUCTION NOTE
FICATION OF USE OF PROPER MATERIALS, DENSITIES, AND LIFT THICKNESS DURING OLLED FILL; UNLESS OTHERWISE INSTRUCTED BY THE DSA INSPECTOR, SOIL'S ENGINEER,	<u>2.0%</u> FLOW (DIRECTION AND GRADE)
	2:1 SLOPE (DIRECTION AND RUN:RISE)
COLLOVIUM ARE TO BE REMOVED AND REPLACED BY PROPERLY COMPACTED FILL.	HORIZONTAL CONTROL POINT LABEL
IN MOISTURE CONTENT.	PAD/FINISHED FLOOR ELEVATION
D BE REMOVED UNTIL BEDROCK IS EXPOSED, THE AREAS TO RECEIVE COMPACTION FILL IT 8 INCHES, MOISTEN AS REQUIRED TO BRING TO APPROXIMATELY OPTIMUM MOISTURE 90% OF THE MAXIMUM DRY DENSITY AS DETERMINED BY THE ASTM DESIGNATION D 1557-02	FF=100.00
PLANNED FOR NEW CONSTRUCTION SHOULD BE CLEARED OF EXISTING IMPROVEMENTS	SITE CURB/BACK OF CURB/GUTTER
RIS, WHICH SHOULD BE PROPERLY DISPOSED OFFSITE. EFFORTS SHOULD BE MADE TO ILITY LINES IN THE AREA PLANNED FOR CONSTRUCTION. EXISTING UTILITIES SHOULD BE	RETAINING WALL/SITE WALL
OVED OR REROUTED AROUND THE DEVELOPMENT AREA TO PRESERVE THEIR FUNCTION. MOVAL OF UTILITIES AND OTHER SITE IMPROVEMENTS SHOULD BE PROPERLY BACKFILLED	PROPERTY LINE/RIGHT OF WAY
	CENTER LINE
R SHALL FOLLOW AND DO THE FOLLOWING REQUIREMENT:	FENCE
RE. THEREFORE, ONLY THE EXCAVATED SANDY SOIL FROM THE SITE MAYBE REUSED IN THE	TO BE DEMOLISHED
SHALL BE INSTALLED. THE SUBDRAIN SYSTEM SHALL CONSIST OF 4" DIAMETER 1 CU.FT. OF FREE DRAINING GRAVEL PER FOOT OF PIPE. AN APPROVED FILTER FABRIC	EROSION CONTROL
RAINING GRAVEL. NON PERFORATED OUTLET PIPES SHALL PASS THROUGH THE WALL INTO	SANDBAGS
HE SITE ARE CONSIDERED TO BE SATISFACTORY TO BE REUSED IN THE AREAS OF VIDED THAT ROCKS LARGER THAN 6" IN DIAMETER ARE TO BE REMOVED.	FIBER ROLL
IL'S ENGINEER, SHOULD BE PLACED IN CONTROLLED LAYERS. EACH LAYER SHALL BE	— — — — — — PROPOSED BUILDING EXCAVATION OUTLINE
XIMUM UNIT WEIGHT AS DETERMINED BY ASTM D 1557-02 FOR THE MATERIAL USED.	EXISTING DRAINAGE DIRECTION OF FLOW
WHICH WHEN COMPACTED SHALL NOT EXCEED 8" PER LAYER. EACH LAYER SHALL BE GHLY MIXED DURING THE SPREADING TO INSURE UNIFORMITY OF MATERIAL IN EACH LAYER.	<u>GRADING</u> <u>100</u> PROPOSED MAJOR CONTOUR
L MATERIAL IS TOO LOW TO OBTAIN ADEQUATE COMPACTION, WATER SHALL BE ADDED E CONTENT IS NEAR OPTIMUM,	
E FILL MATERIAL IS TOO HIGH TO OBTAIN ADEQUATE COMPACTION, THE FILL MATERIAL	FLOW LINE
ER SATISFACTORY METHODS UNTIL NEAR OPTIMUM CONDITION IS ACHIVED. SHALL BE CONDUCTED BY THE SOIL'S ENGINEER DURING GRADING WORK TO ASSURE	GRADE BREAK LINE
HERE COMPACTION IS LESS THAN 90% RELATIVE DENSITY, CONTRACTOR SHALL I TO ACHIEVE 90% RELATIVE COMPACTION.	RIDGE LINE
	EARTHEN SWALE
	SAWCUT
ORED TEMPORARY EXCAVATION SLOPES CAN BE USED WITH THE FOLLOWING CONDITION:	LIMITS OF GRADING
IMUM SLOPE RATIO	GRADING BENCH
L GRADIENT)	GRADED SLOPE (HORIZONTAL:VERTICAL)
W OVER THE TOP OF EXCAVATION IN UNCONTROLLED MANNER. NO SURCHARGE SHALL BE I FROM THE BOTTOM OF EXCAVATION. EXCAVATION SURFACE SHALL BE KEPT MOIST BUT	
D SLOUGHING DURING CONSTRUCTION.	UTILITY
	SANITARY SEWER
	WATER
	DOMESTIC WATER
	STORM DRAIN
TE PERMIT FROM CITY OF POMONA AND OTHER AGENCIES / UTILITY THE PUBLIC RIGHT OF WAY INCLUDING (BUT NOT LIMITED TO), SIDEWALK	GAS
WER, GAS, WATER, AND OTHER UNDERGROUND UTILITY LATERALS. R COORDINATING THE PERMITS AND CONSTRUCTION WORK AND SCHEDULE	ELECTRIC
S. CONTRACTOR TO INCLUDE THIS PERMIT PROCESSING ON HIS/HER BID.	TELEPHONE
	PERFORATED PIPE
	POINT OF CONNECTION
	COORDINATION POINT
	CAP OR PLUG
	AREA DRAIN/PLANTER DRAIN

FIRE HYDRANT

()

M. \otimes

TRENCH DRAIN

THRUST BLOCK

FIRE DEPARTMENT CONNECTION (FDC)

POST INDICATOR VALVE (PIV)

WATER VALVE

BACKFLOW ASSEMBLY

UTILITY METER VAULT

ABBREVIATIONS

AC	ASPHALTIC CONCRETE	PA
BW	BACK OF WALK	POC
BLDG	BUILDING	PIV
BM	BENCH MARK	PCC
BOS		PRV
BMP		PVC
CB	CATCH BASIN	PWP
CI	CAST IRON	PW
CL	CENTER LINE	PPW
	CONCRETE MASONRY UNIT	R
CO	CLEANOUT	RCIP
	CONCRETE	RD
CF	CURB FACE	RW
DW		(S)
(E)	EAST	S=
EG	EDGE OF GUTTER	SD
		SSMH
		SS
EX. OR	-	STD
FDC		SDMH : TC
FF		-
FG		TEL TG
FS FH	FINISHED SURFACE (HARDSCAPE) FIRE HYDRANT	TOS
FL	FLOW LINE	TW
FL	FOOT OR FEET	TS
FU	FIXTURE UNITS	TSB
GV	GATE VALVE	TYP
FW	FIRE WATER	TV
GPM		VIF
HDPE		VLT
HP	HIGH POINT	VCP
INV.		(W)
LP	LOW POINT	W
MAX.		WM
MIN.	MINIMUM	WV

PA POC	PLANTER AREA POINT OF CONNECTION
PIV	POST INDICATOR VALVE
20Y	PORTLAND CEMENT CONCRETE
PRV	PRESSURE REDUCING VALVE
VC	POLYVINYL CHLORIDE
WP	PASADENA WATER & POWER
PW	PUBLIC WORKS
PW	PASADENA PUBLIC WORKS
2	RADIUS
RCIP	RECTANGULAR CAST IRON PIPE
RD	ROOF DRAIN
RW	RIGHT-OF-WAY
S)	SOUTH
S=	SLOPE EQUALS
	STORM DRAIN
	SANITARY SEWER MANHOLE
SS STD	SANITARY SEWER STANDARD
	STANDARD STORM DRAIN MANHOLE
С	TOP OF CURB
EL	TELEPHONE
G	TOP OF GRATE
os	TOP OF STAIRS
W	TOP OF WALL
S	TRAFFIC SIGNAL
SB	TRAFFIC SIGNAL BOX
ΥP	TYPICAL
V	TELEVISION
/IF	VERIFY IN FIELD
/LT	VAULT
/CP	VITRIFIED CLAY PIPE
W)	WEST
V	WATER
VM	WATER METER
VV	WATER VALVE

CIVIL SHEETS			
SHEET NO.	SHEET NAME		
C-0.1	CIVIL GENERAL NOTES		
1	TOPOGRAPHIC SURVEY		
C-2.0	SITE CONTROL PLAN		
C-3.0	GRADING PLAN		
C-4.0	UTILITY PLAN		

ESTIMATED EARTHWORK QUANTITIES

ON-SITE EARTHWORK QUANTITIES (PAVING ONLY):


- CUT: 3,360 CY
- FILL: 2,520 CY


SITE AREA: 0.83 ACRES

NOTES:


- 1. THE ESTIMATED QUANTITIES PROVIDED ABOVE ARE TO BE USED FOR JURISDICTIONAL PLAN CHECKING AND PERMITTING PURPOSES ONLY. THE CONTRACTOR SHALL NOT USE THE ABOVE QUANTITIES IN HIS BID. THE CONTRACTOR SHALL CALCULATE HIS OWN EARTHWORK QUANTITIES NECESSARY FOR HIS BID AND WORK.
- ESTIMATED EARTHWORK ABOVE IS BASED ON DESIGN FINISH GRADES TO EXISTING 2. GRADES AND/OR CONTOURS AS PROVIDED ON THE BASE SURVEY. THE ESTIMATED EARTHWORK DOES NOT ACCOUNT FOR THE OVEREXCAVATION, RECOMPACTION REQUIREMENT, THICKNESS OF PAVEMENTS, FOUNDATIONS AND SLABS ON GRADE, FOOTINGS, CLEARING AND GRUBBING, AND CONSTRUCTION MEANS AND METHODS.
- 3. THE ESTIMATED EARTHWORK QUANTITIES DO NOT INCLUDE SHRINKAGE AND/OR EXPANSION FACTORS DUE TO COMPACTION OR OVER EXCAVATION QUANTITIES.
- 4. CONTRACTOR SHALL REFER TO GENERAL GEOTECHNICAL NOTES (C-0.1) AND THE SOIL'S REPORT FOR OVEREXCAVATION, RECOMPACTION, AND FILL REQUIREMENTS. CONTRACTOR SHALL CONSIDER THESE OVEREXCAVATION, RECOMPACTION, & FILL QUANTITIES IN HIS BID.
- 5. EARTHWORK QUANTITIES DOES NOT INCLUDE BUILDING FOUNDATION & SLAB EXCAVATION AND OVEREXCAVATION.
- 6. ESTIMATED EARTHWORK QUANTITIES ABOVE ASSUME THAT ALL ONSITE MATERIALS ARE SUITABLE FOR BACKFILLING. HOWEVER, ACTUAL EXISTING ONSITE MATERIALS AND IMPORTED MATERIALS MUST FIRST BE APPROVED BY THE GEOTECHNICAL ENGINEER PRIOR TO INSTALLATION, REMOVAL, OR REPLACEMENT.

	EVISIONS	DATE
PROJECT: WEST PHILLILPS TOWNHOMES	ADDRESS: 1137 AND 1149 WEST PHILLIPS BLVD. POMONA ,CA 91766	OWNER: KHURSHID KHAN TRUSTEE OF THE WEST COAST OCEANSIDE TRUST
		0
2522 T: 323.47 JOB N DATE 1 ST R DRAV PLOT	: EV: VN: TED:	RIVE, UNIT C 91010
SCAL	E: AS	SHOWN
SCAL		SHOWN
SCAL	GENERAL NOTES	
	CIVIL GENERAL NOTES	ITLE

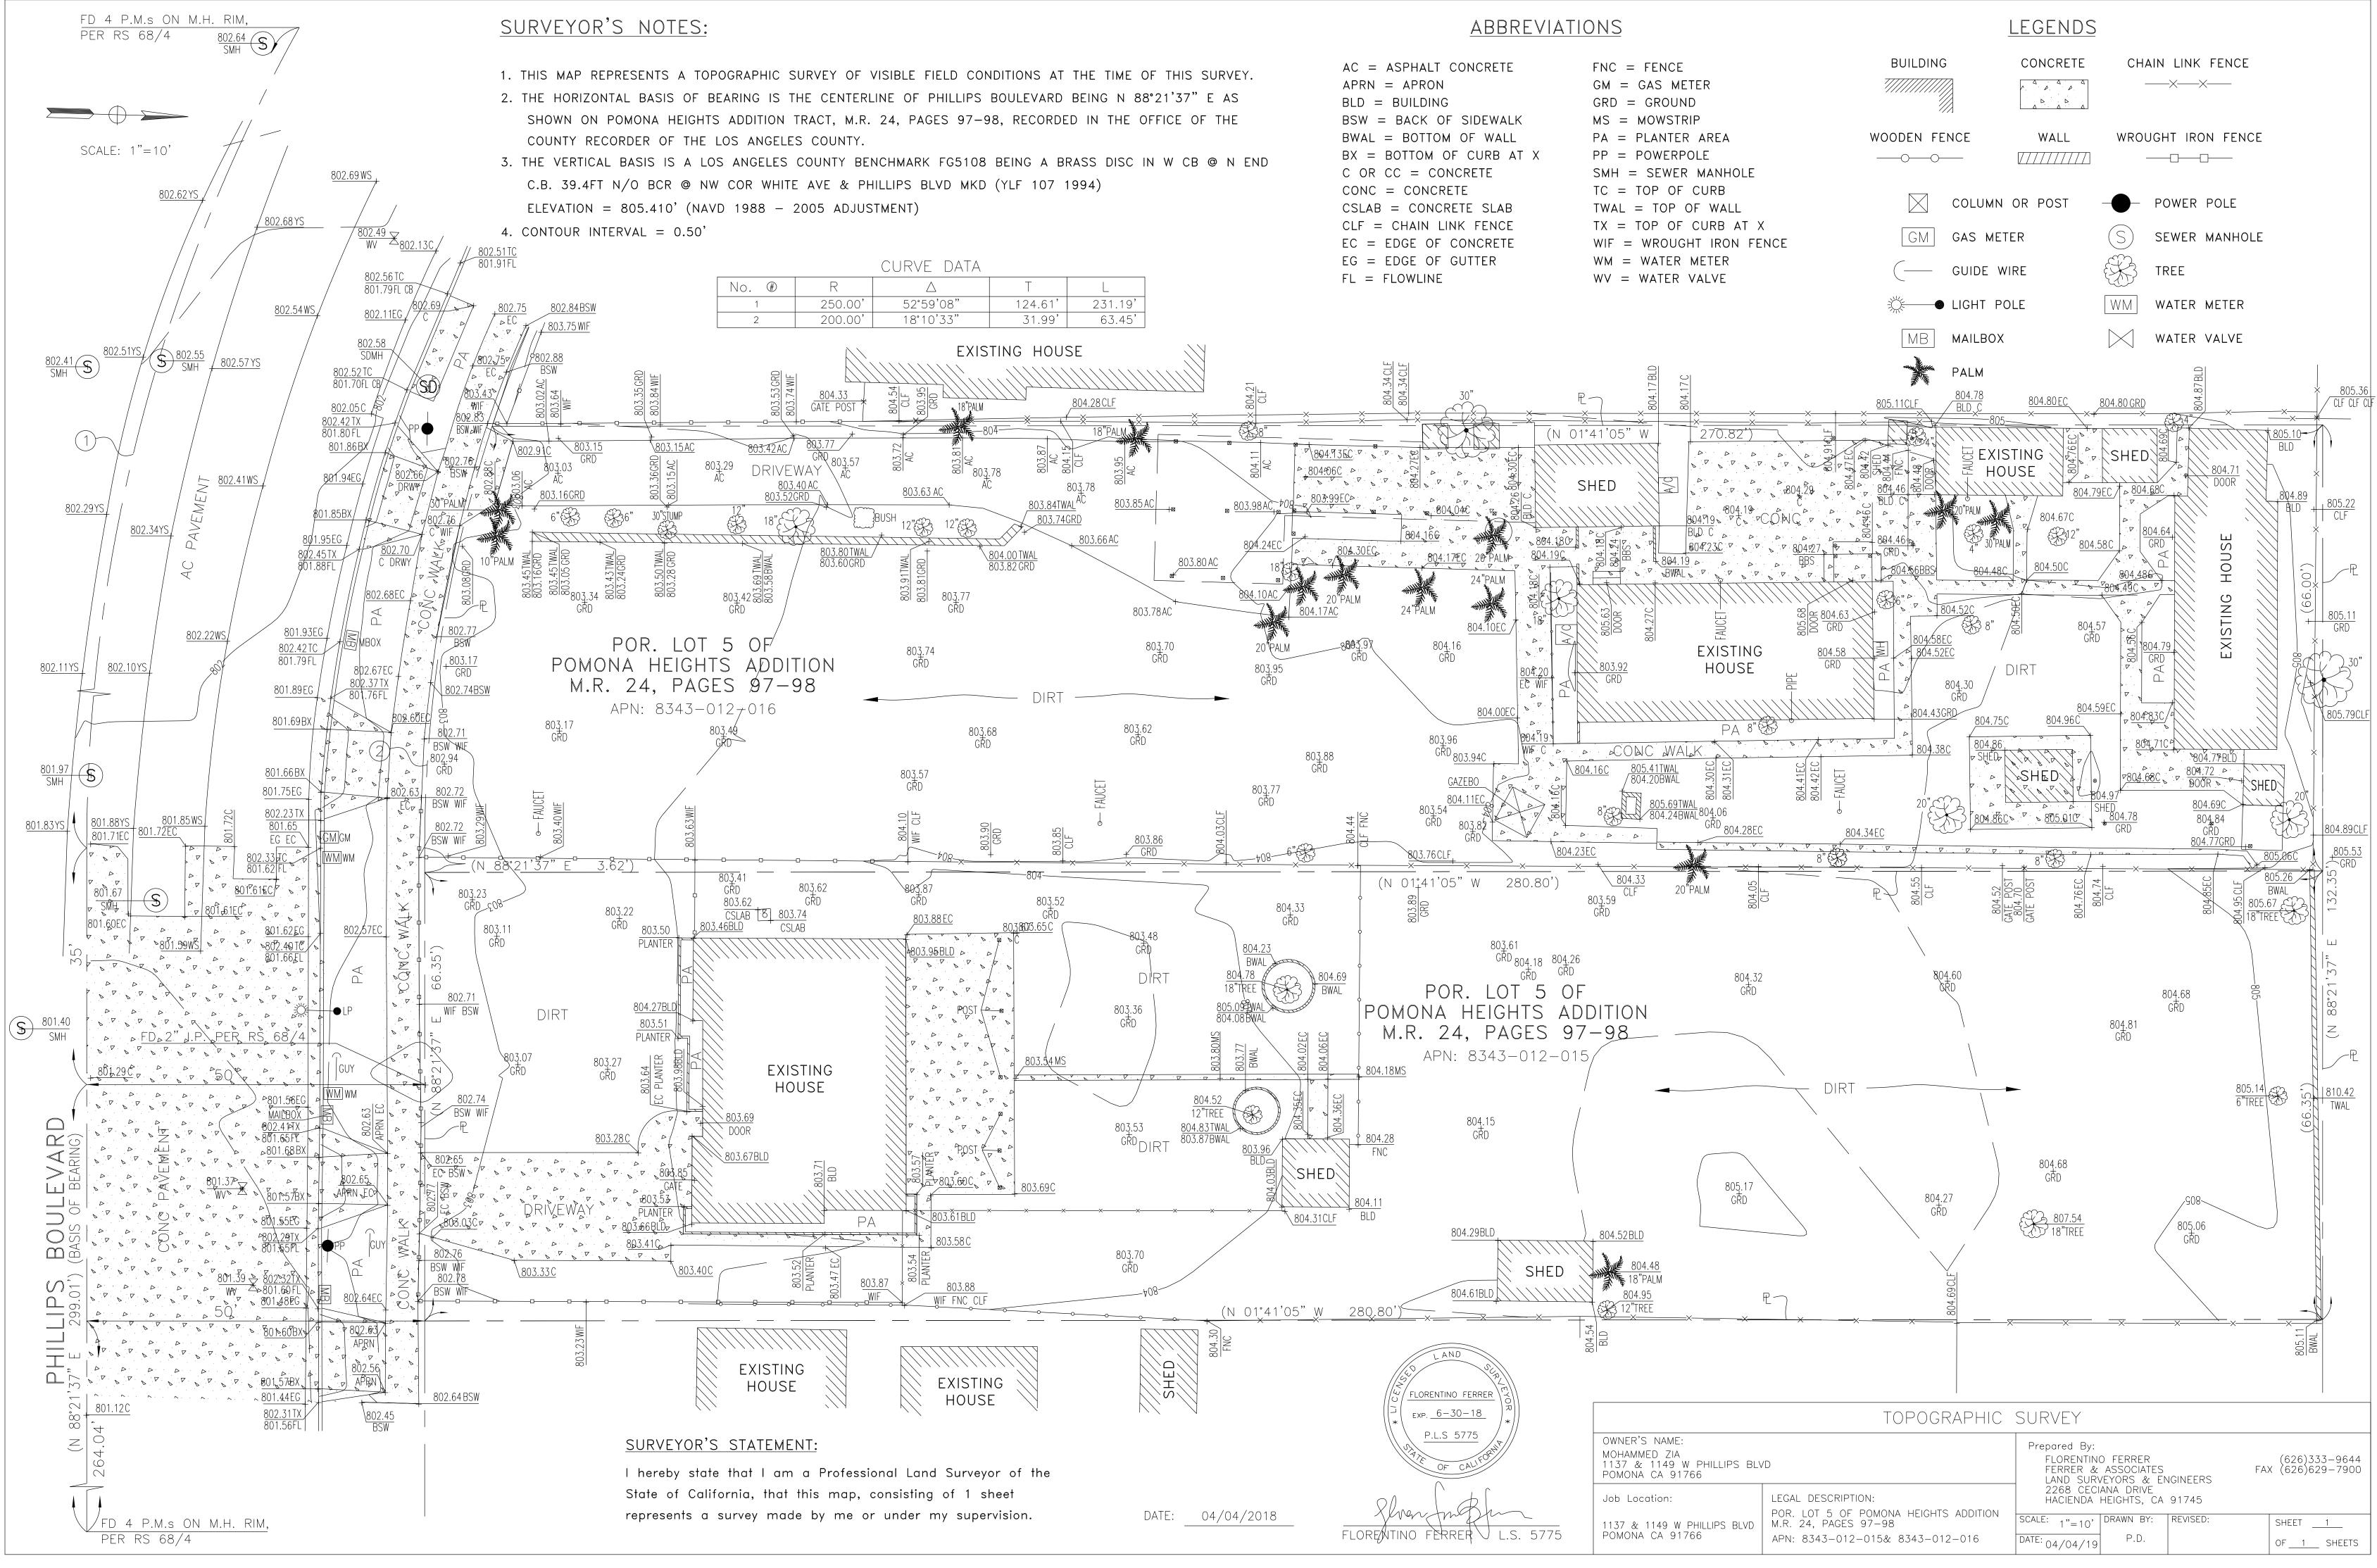


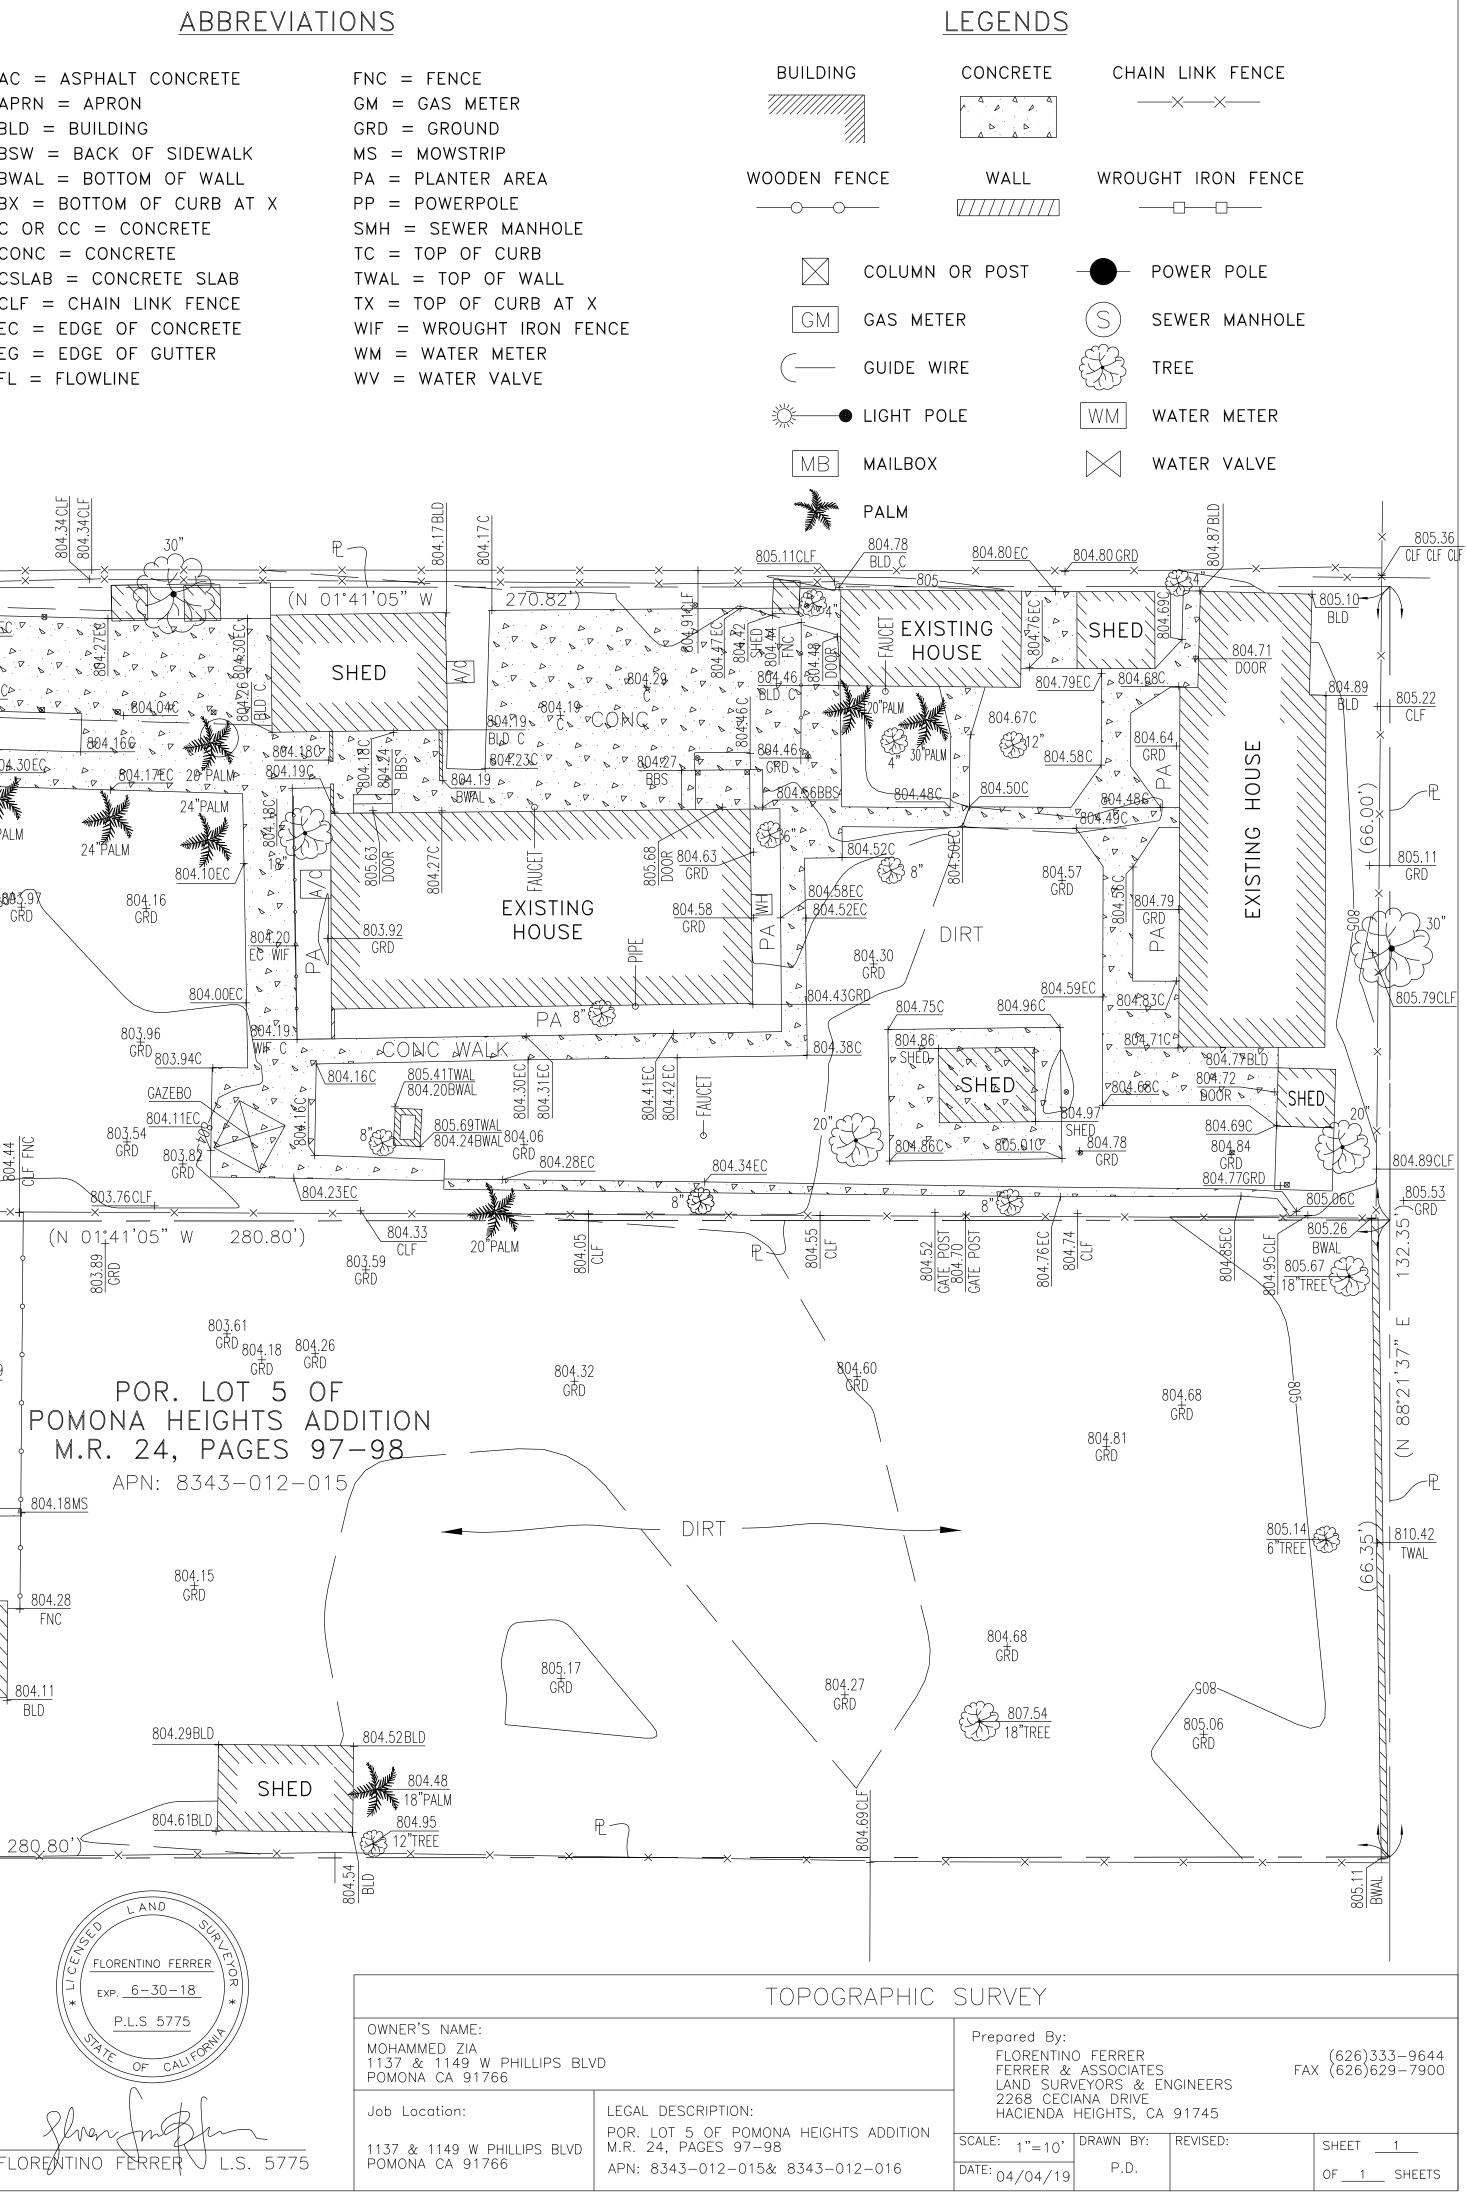





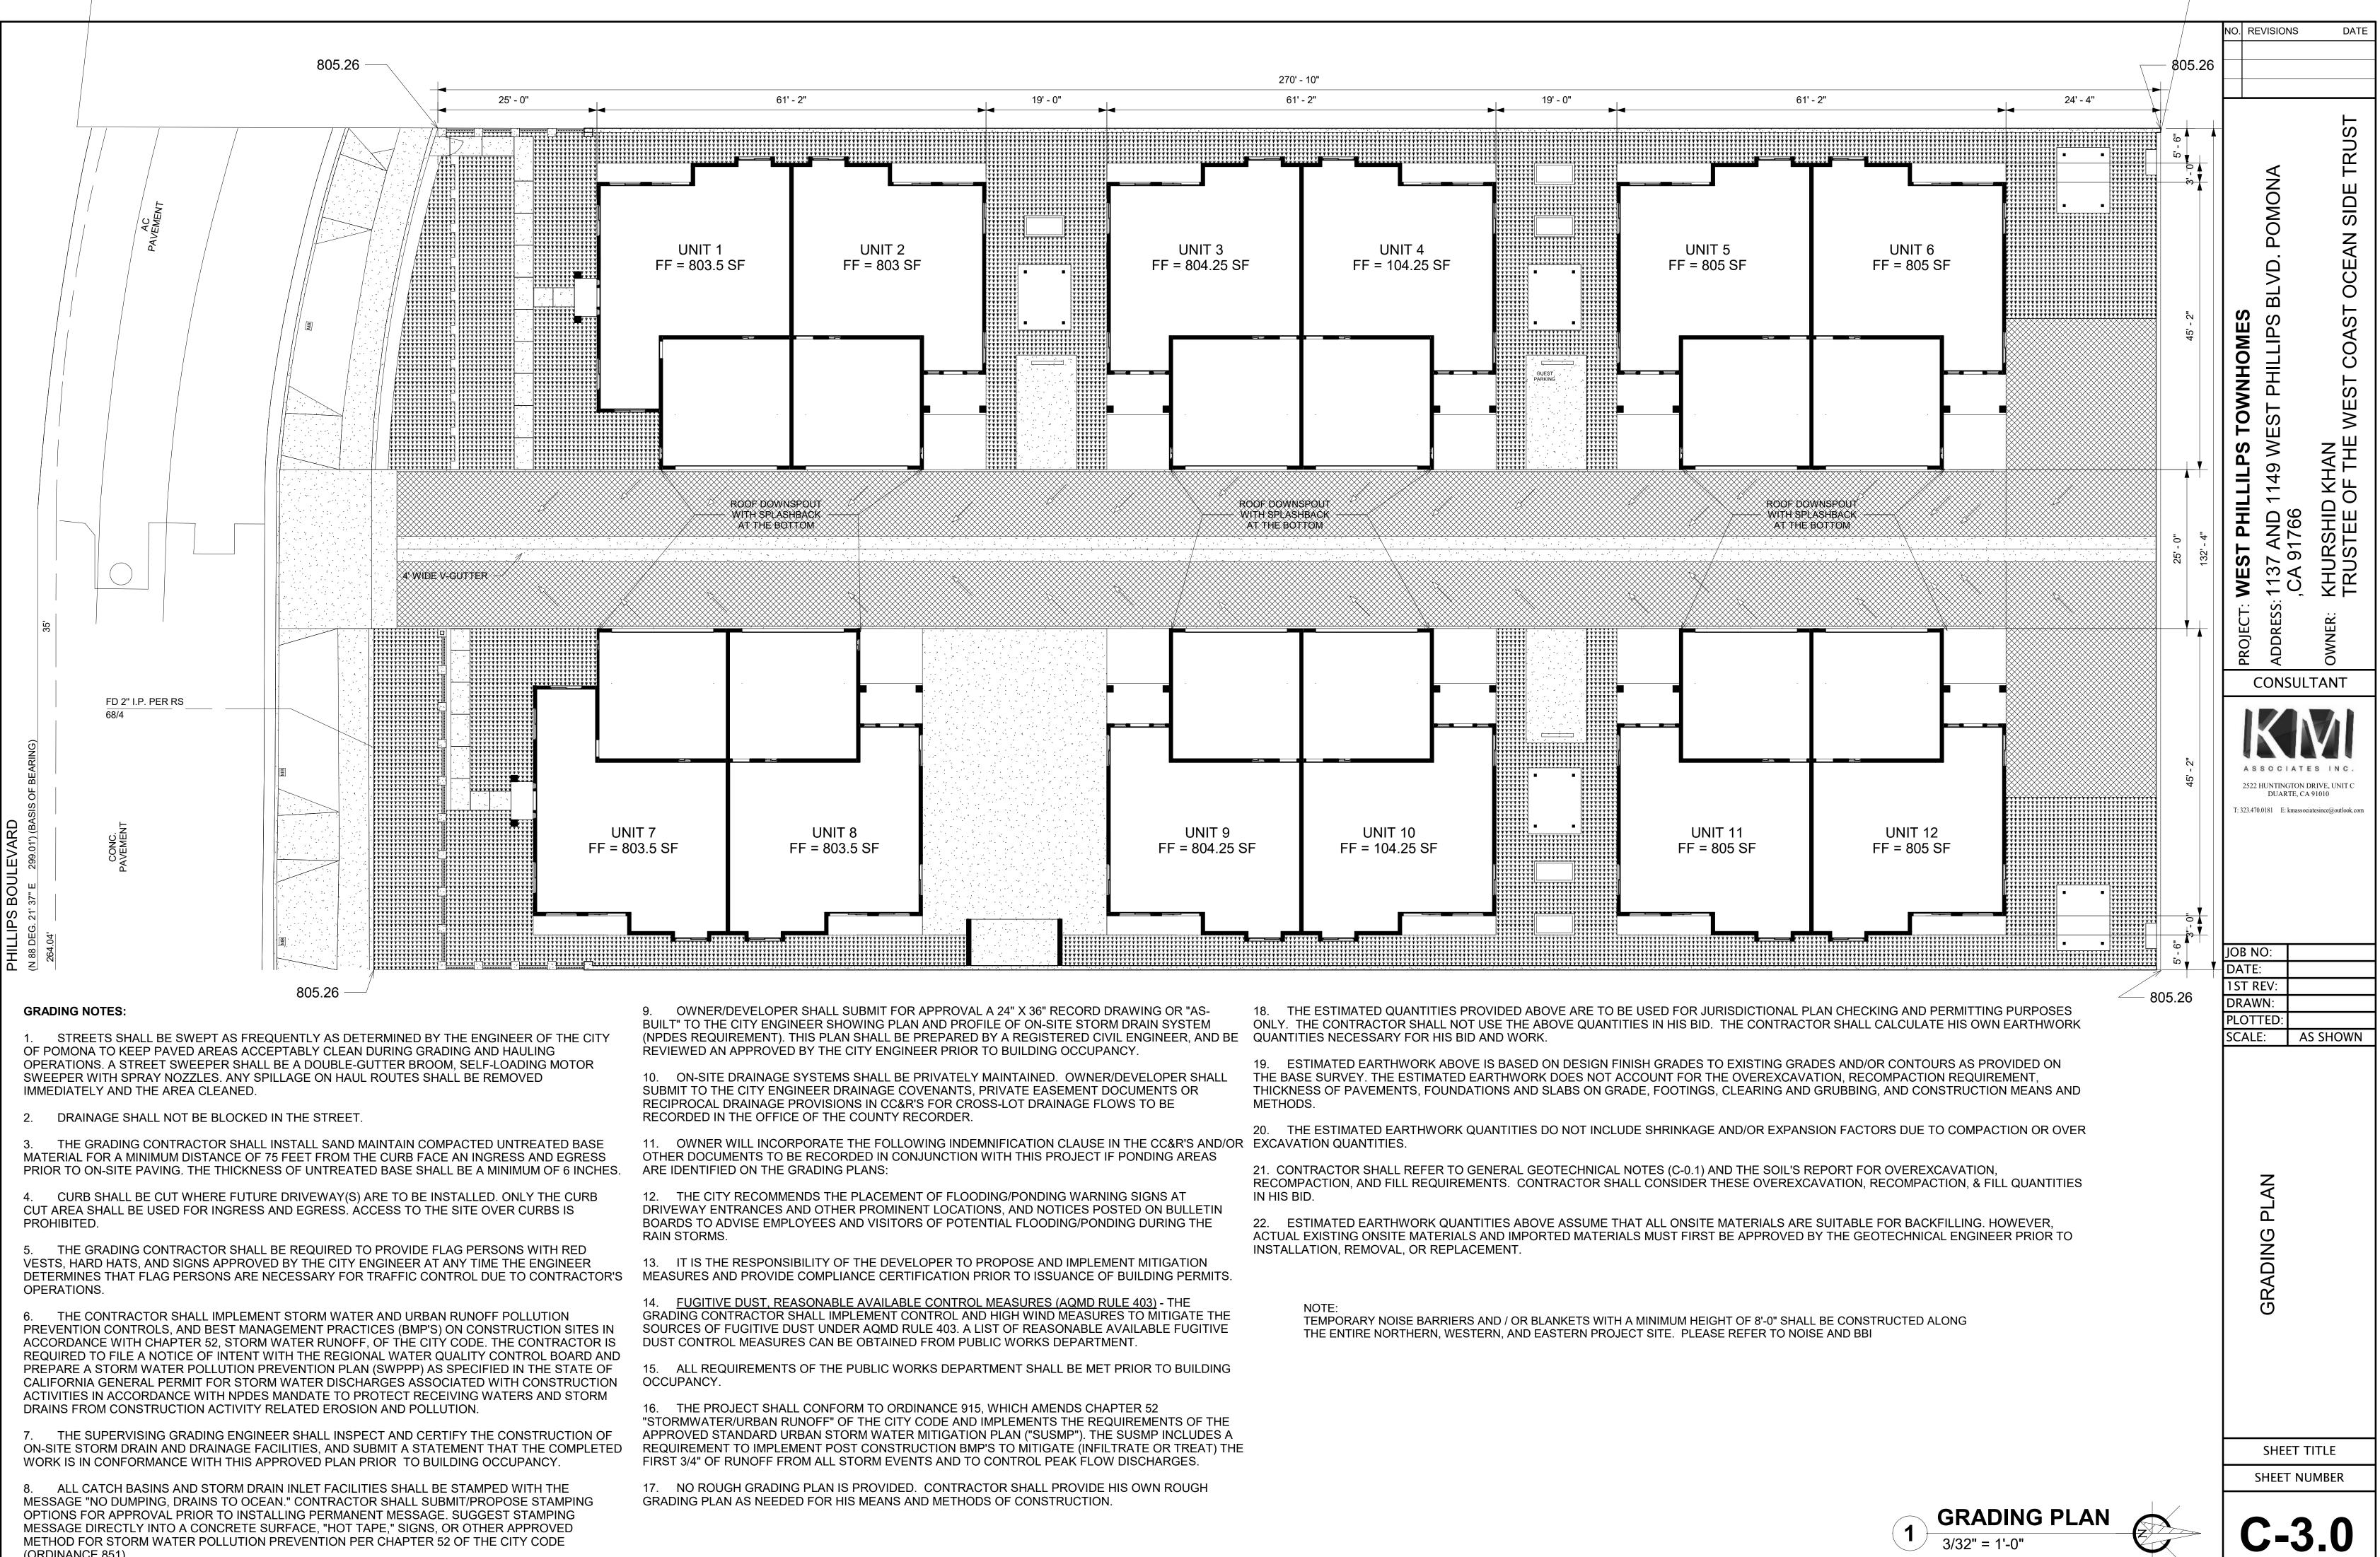



(ORDINANCE 851).

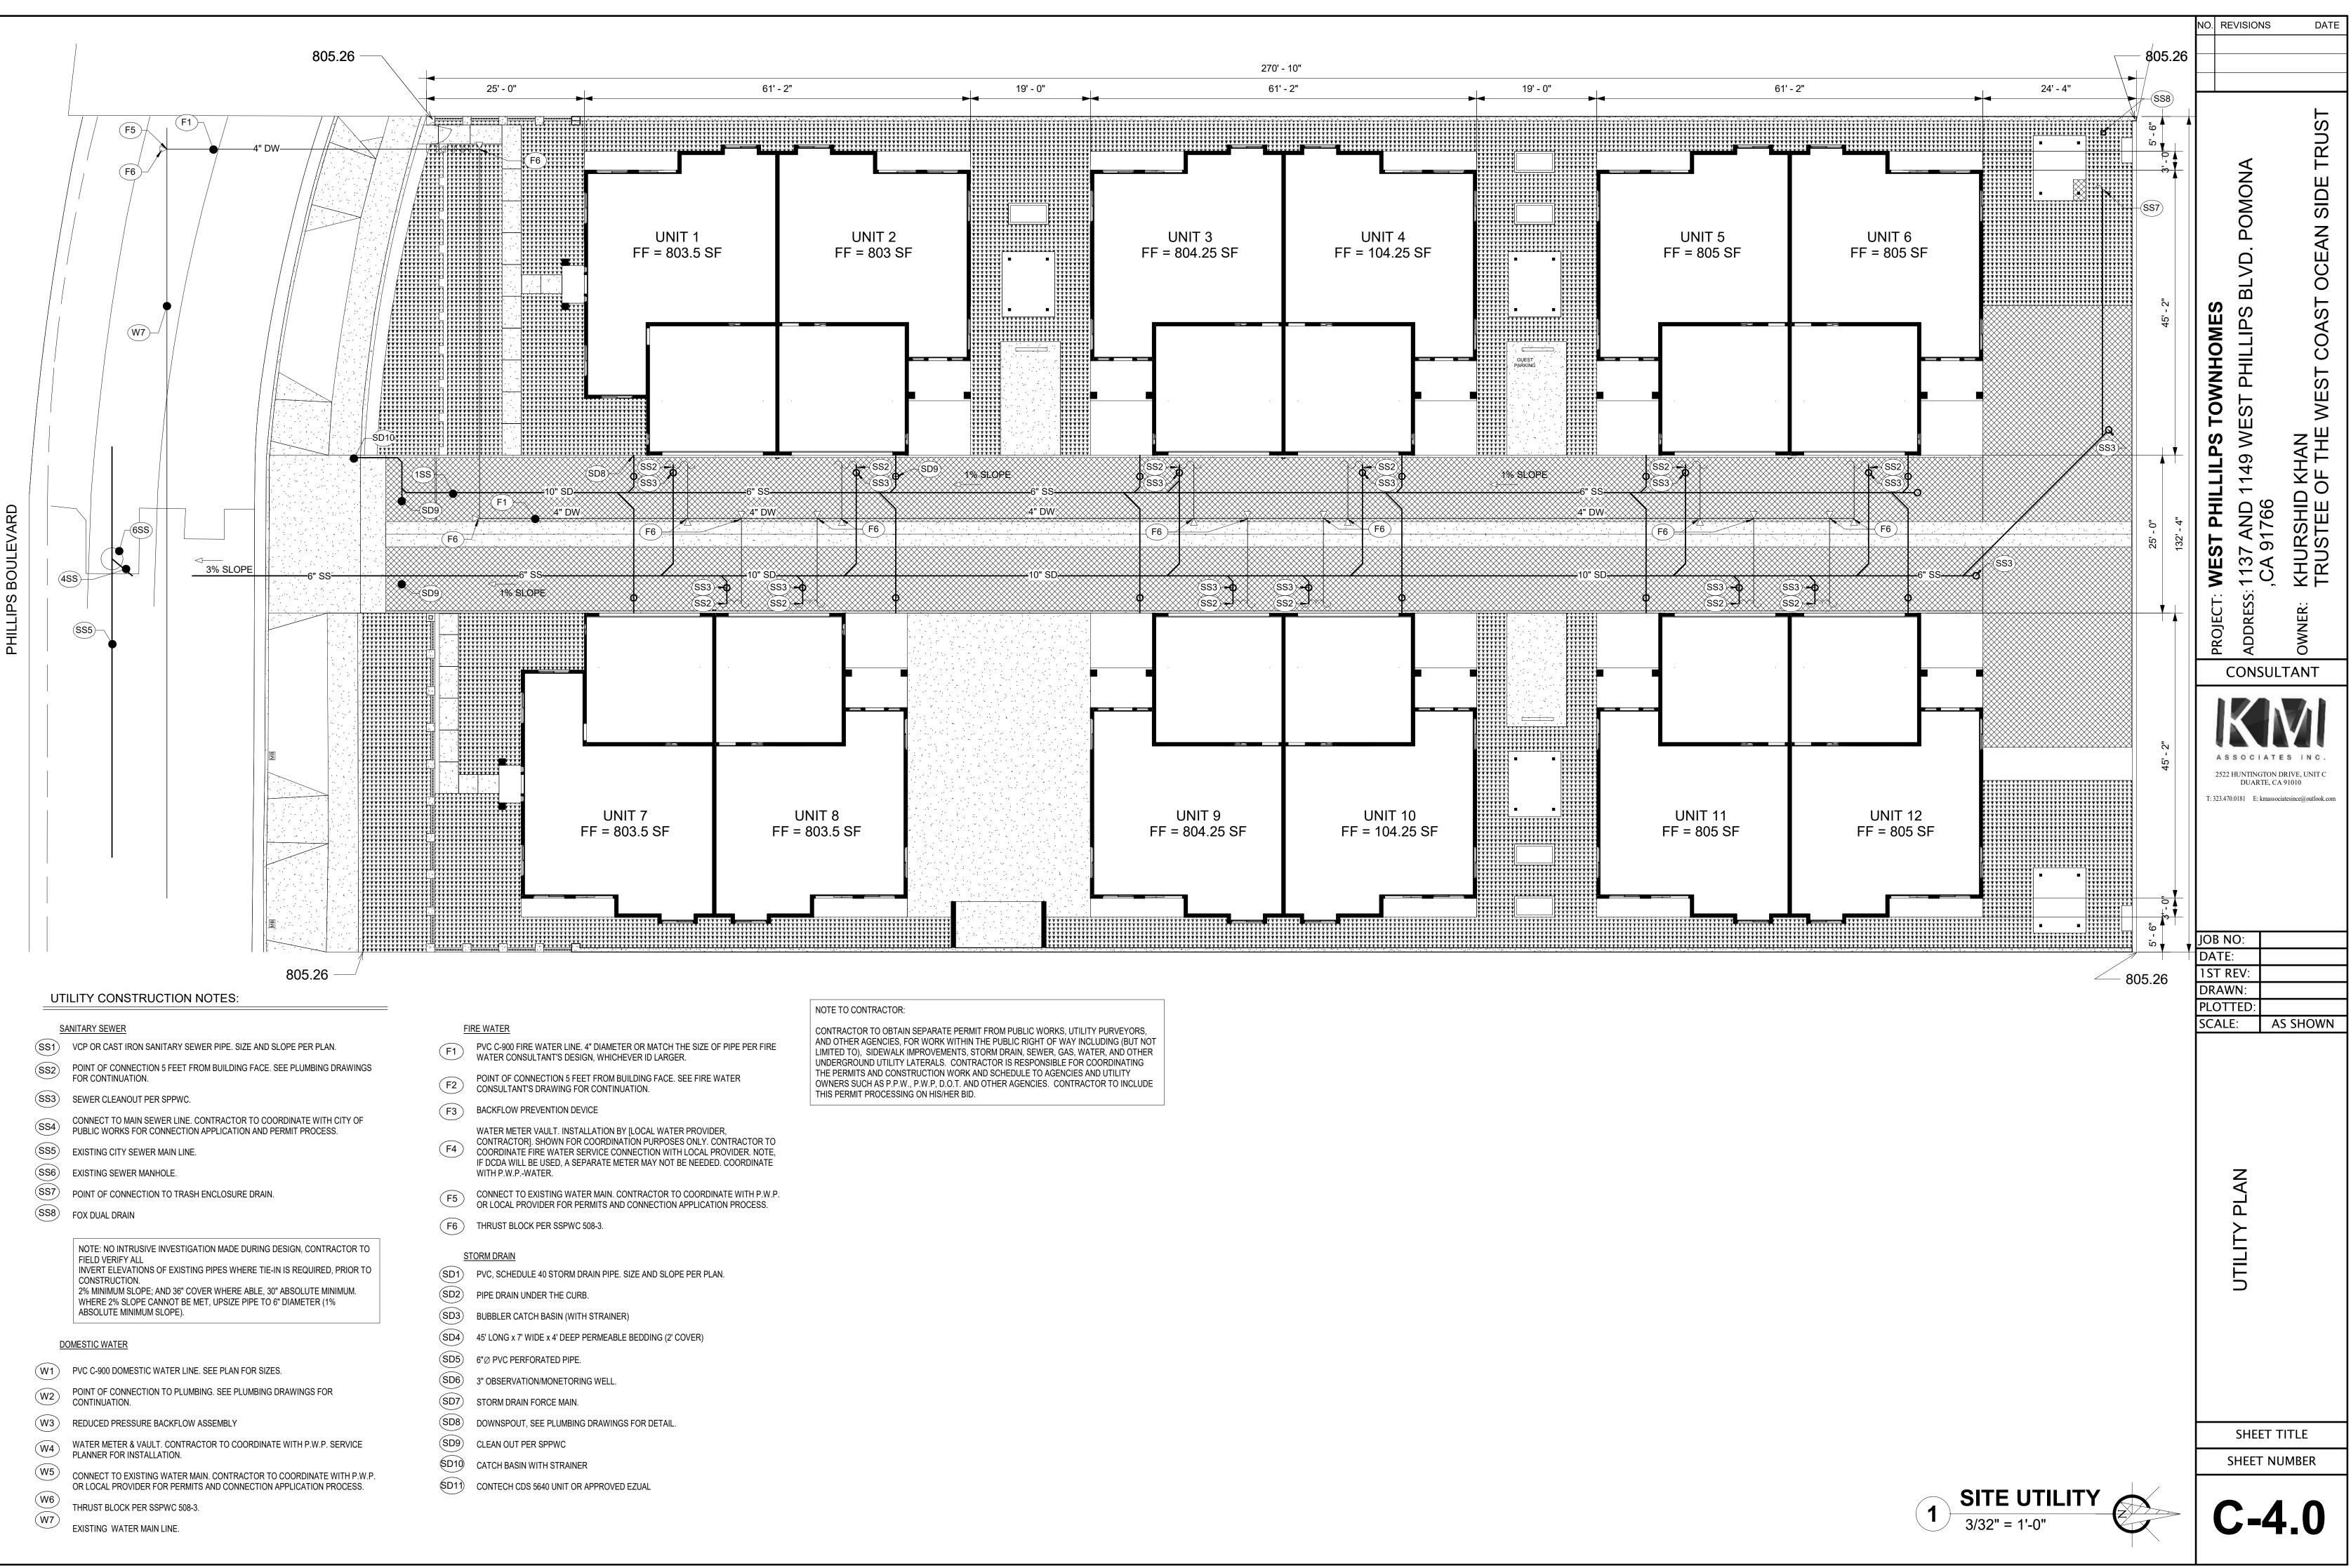

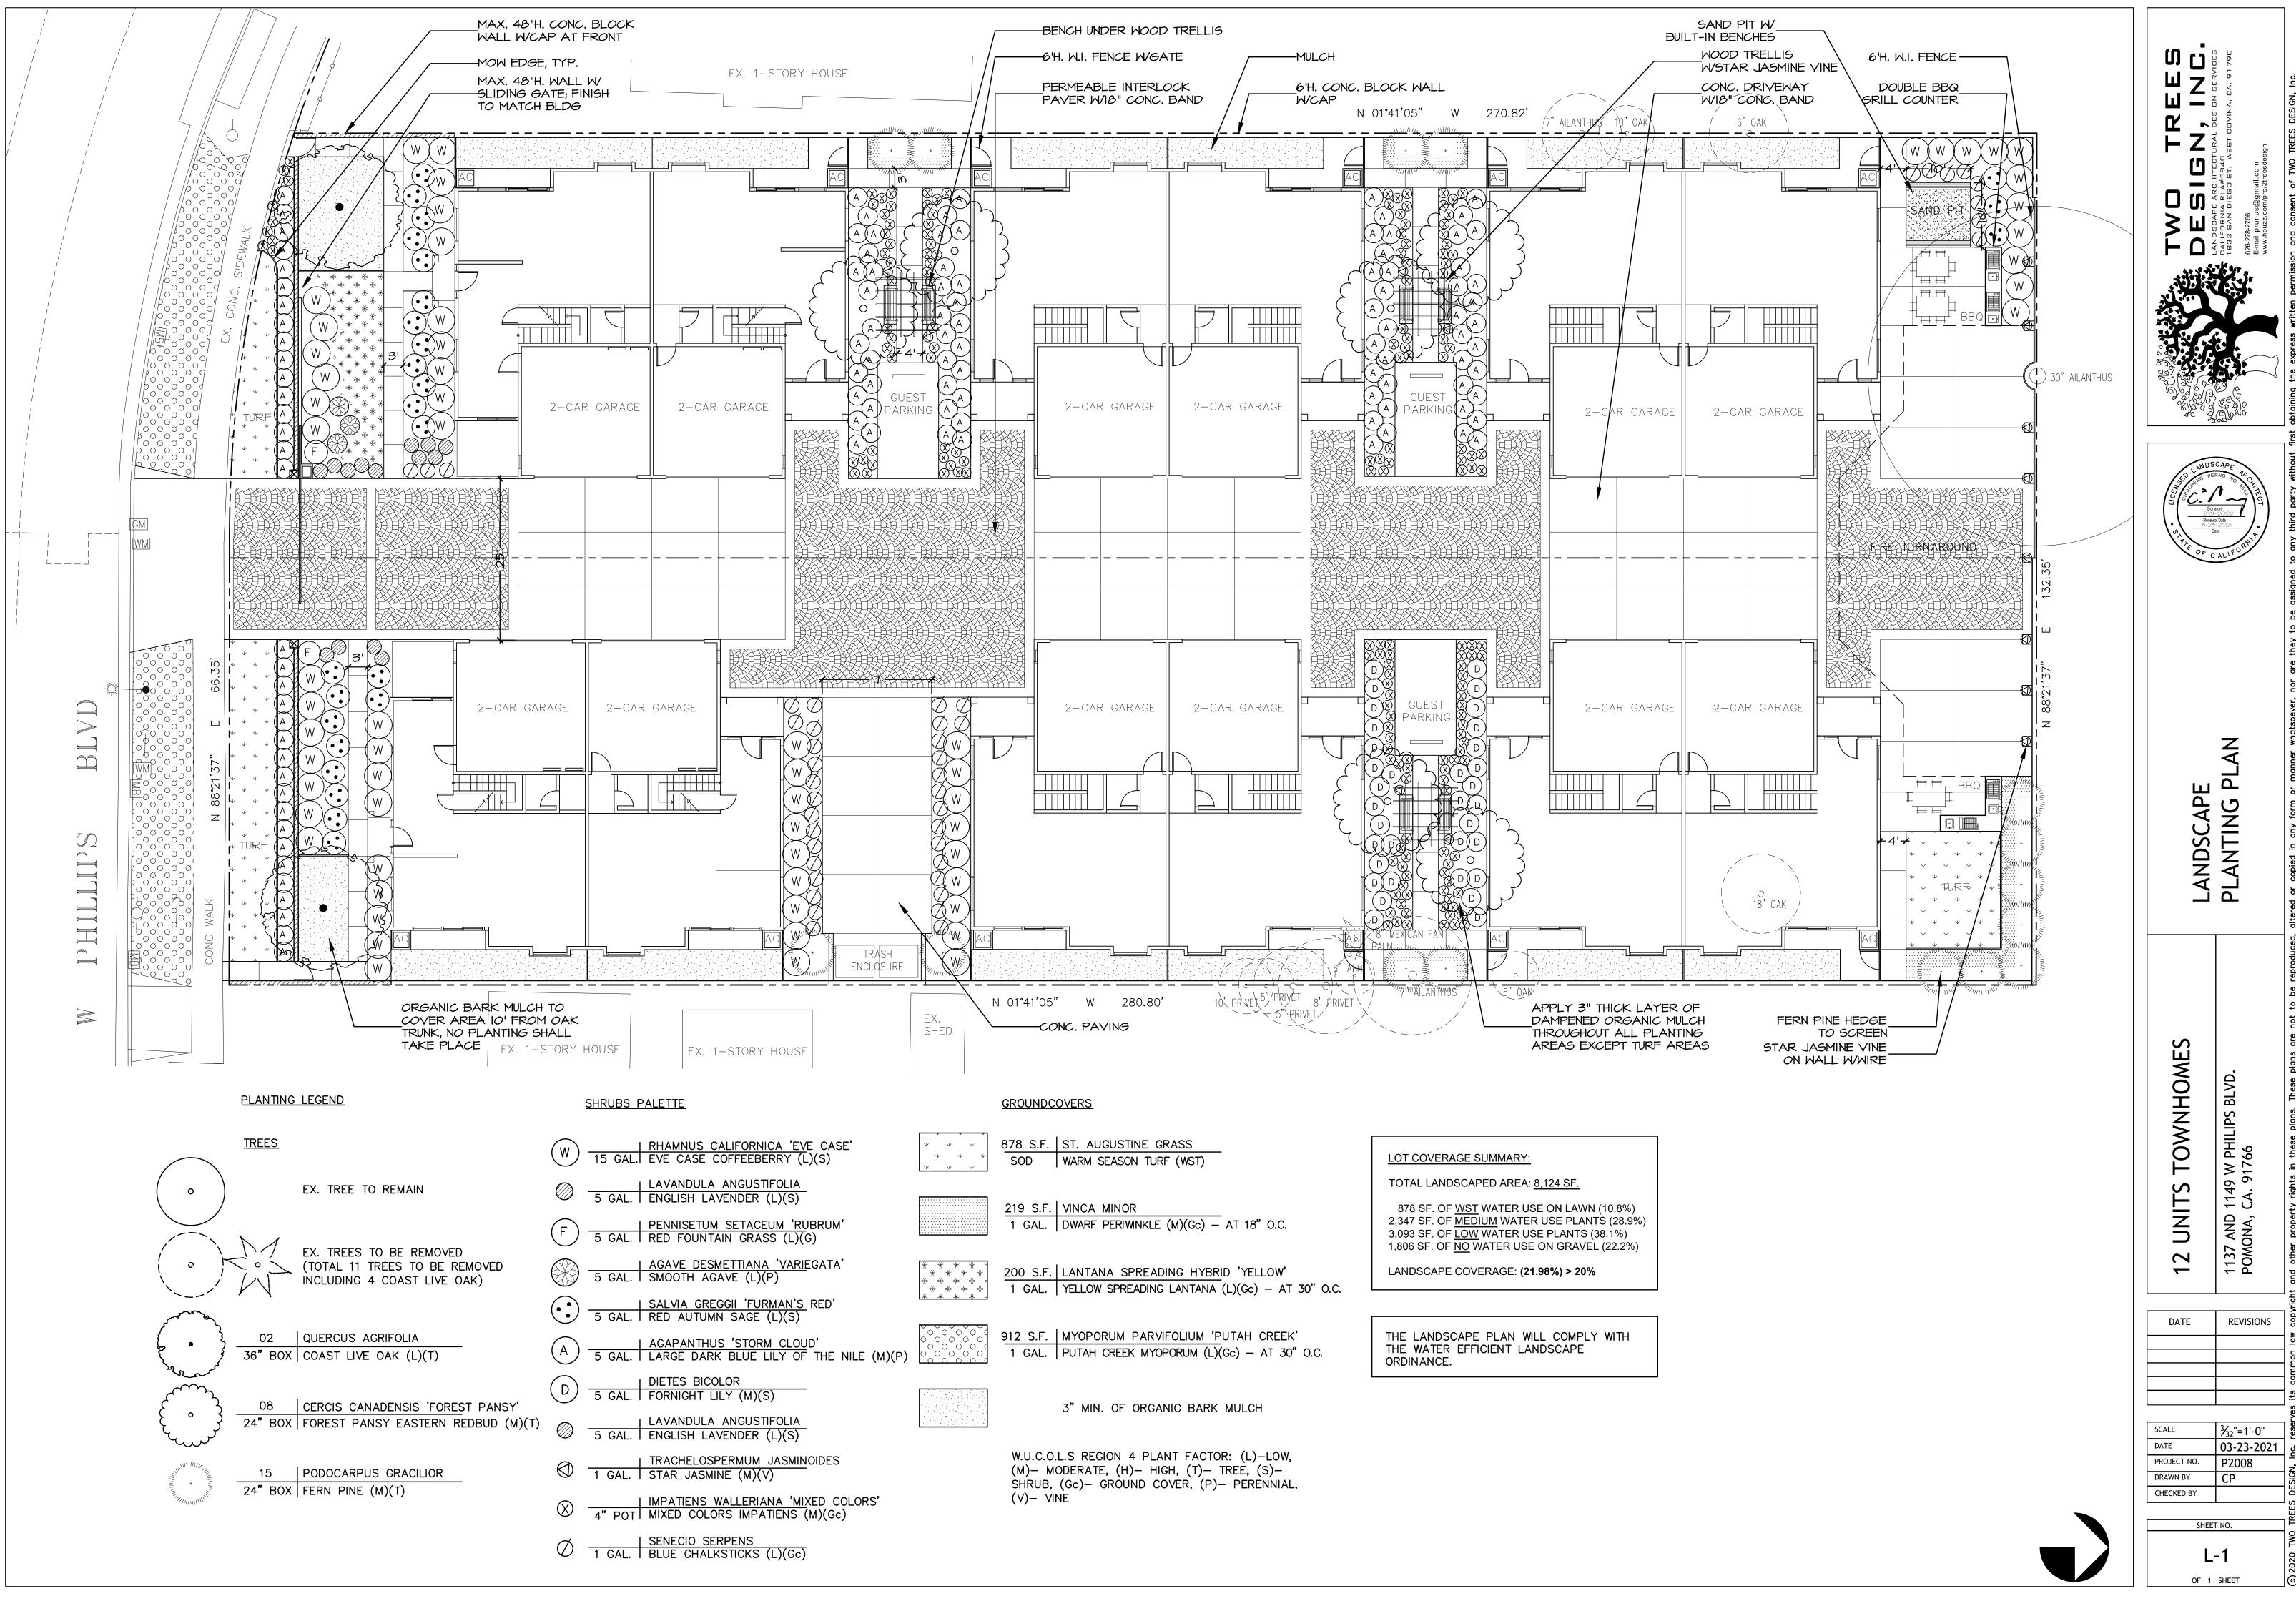

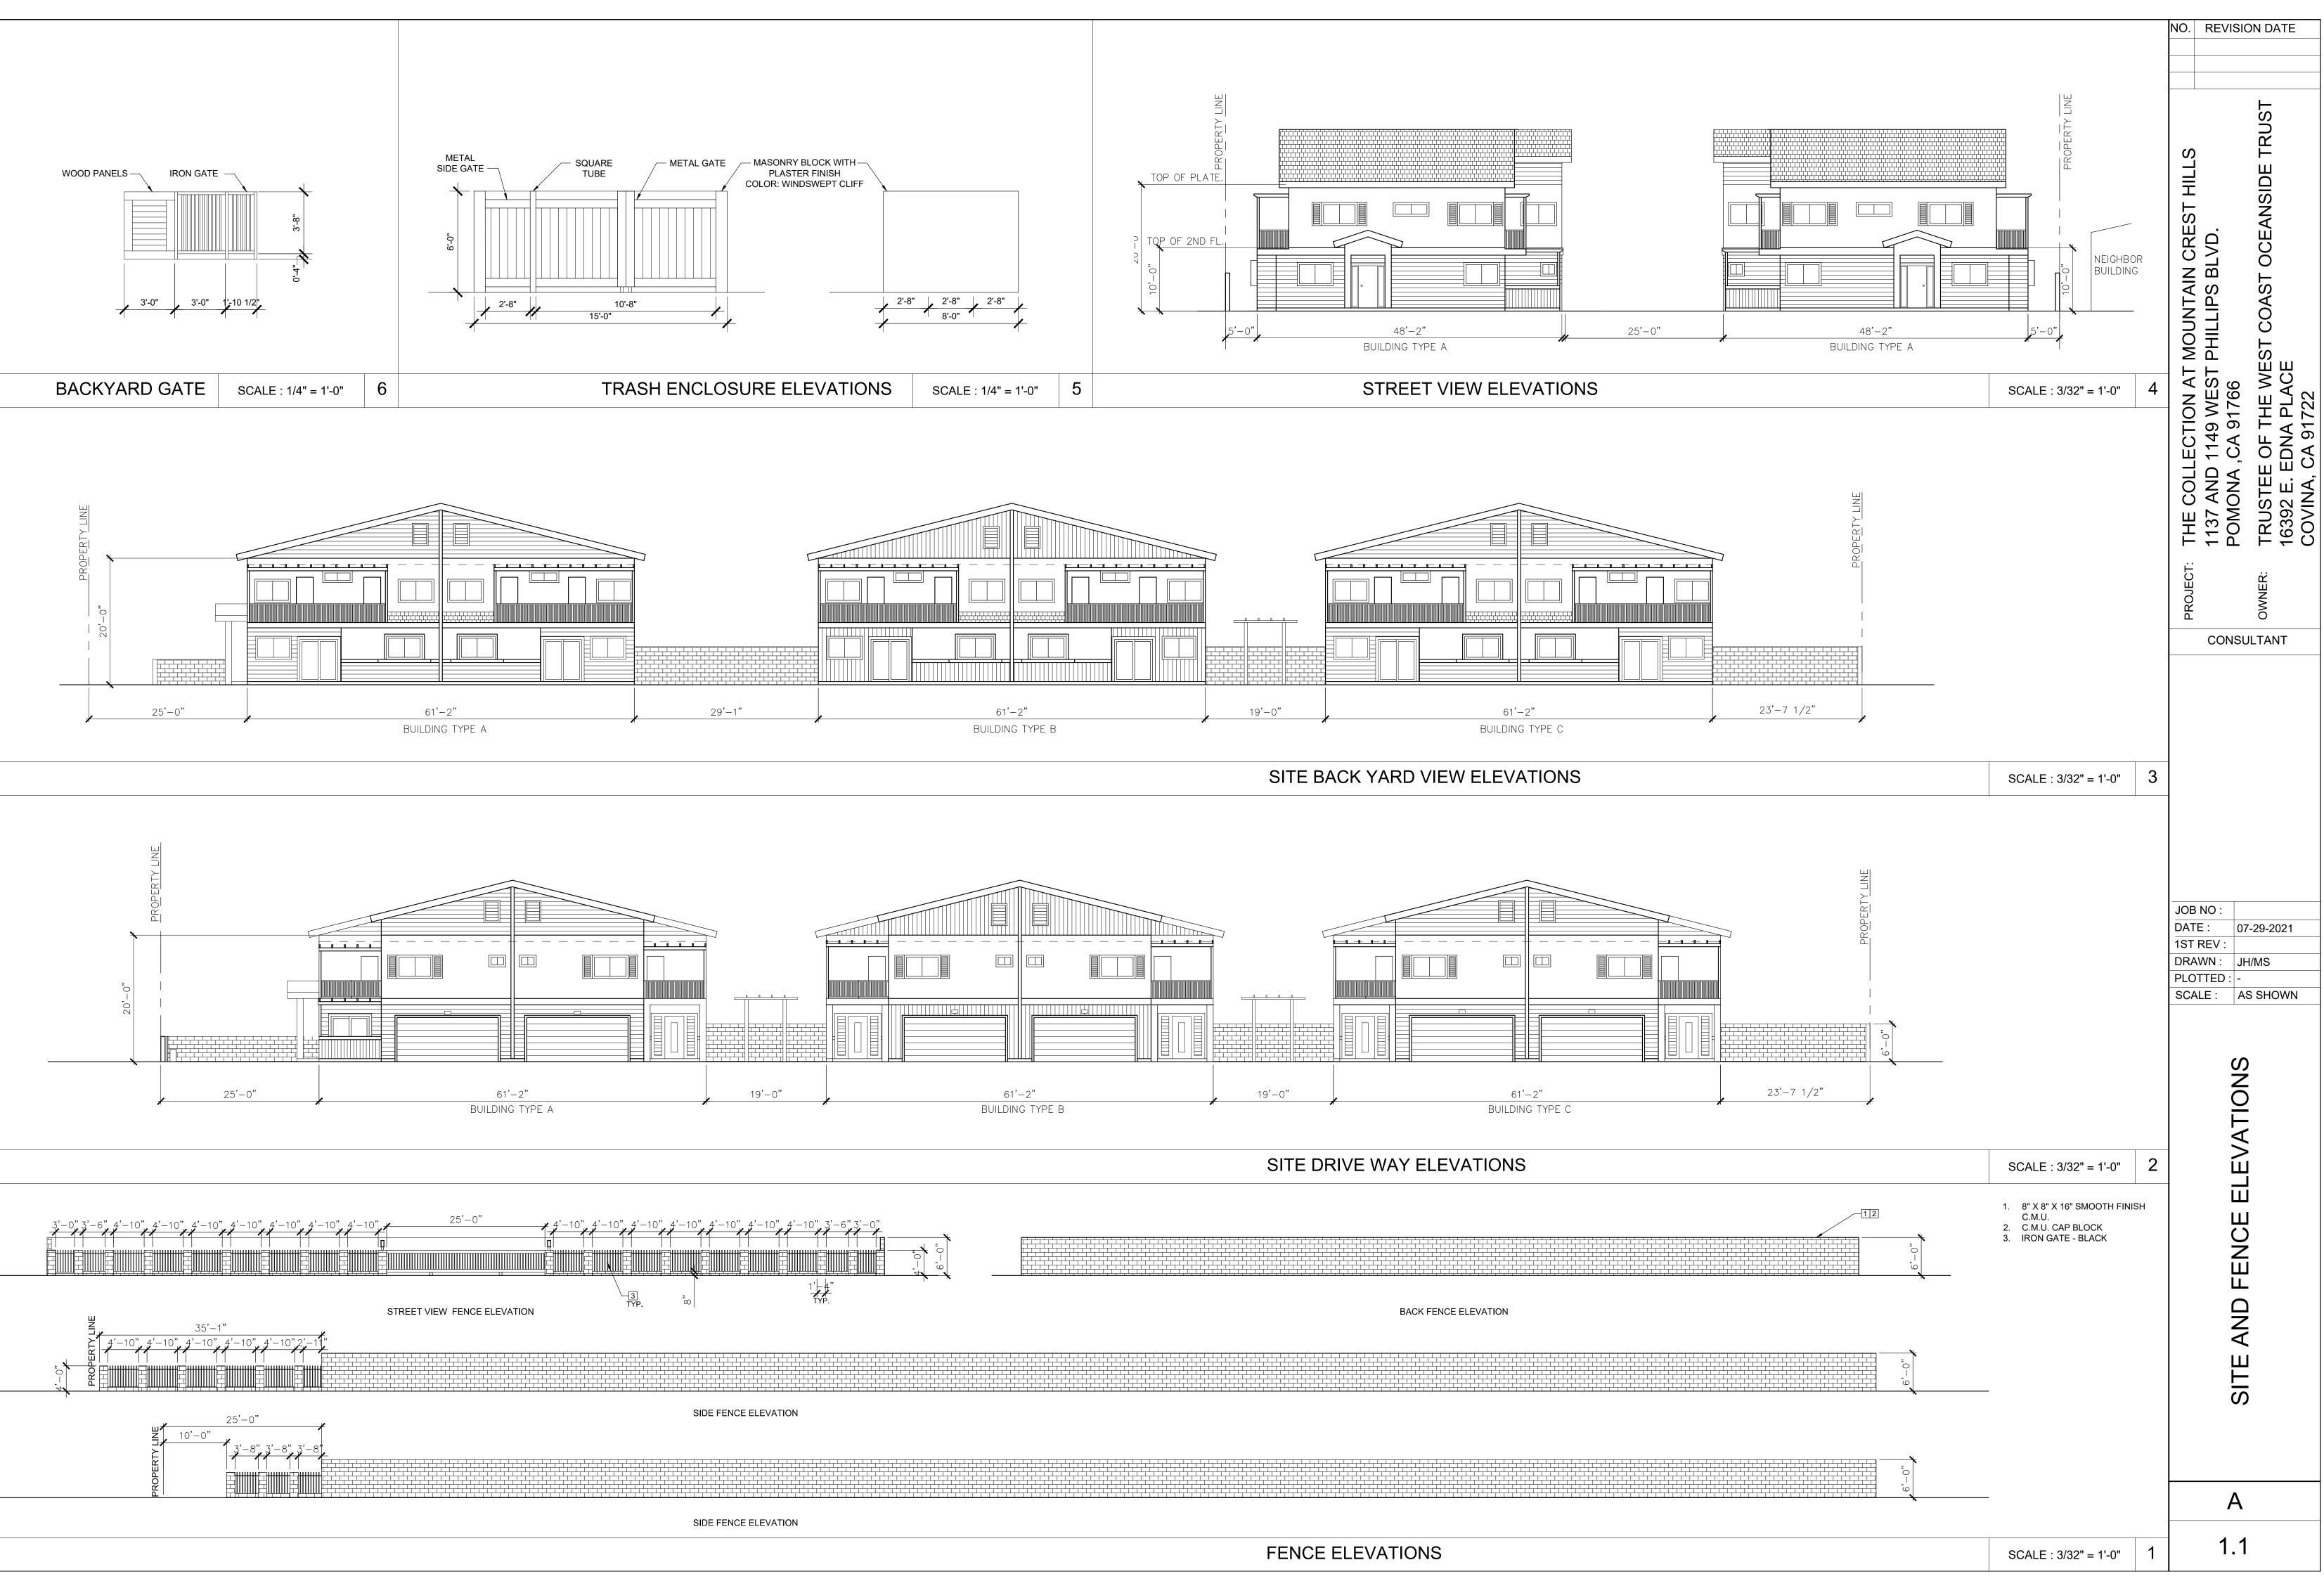

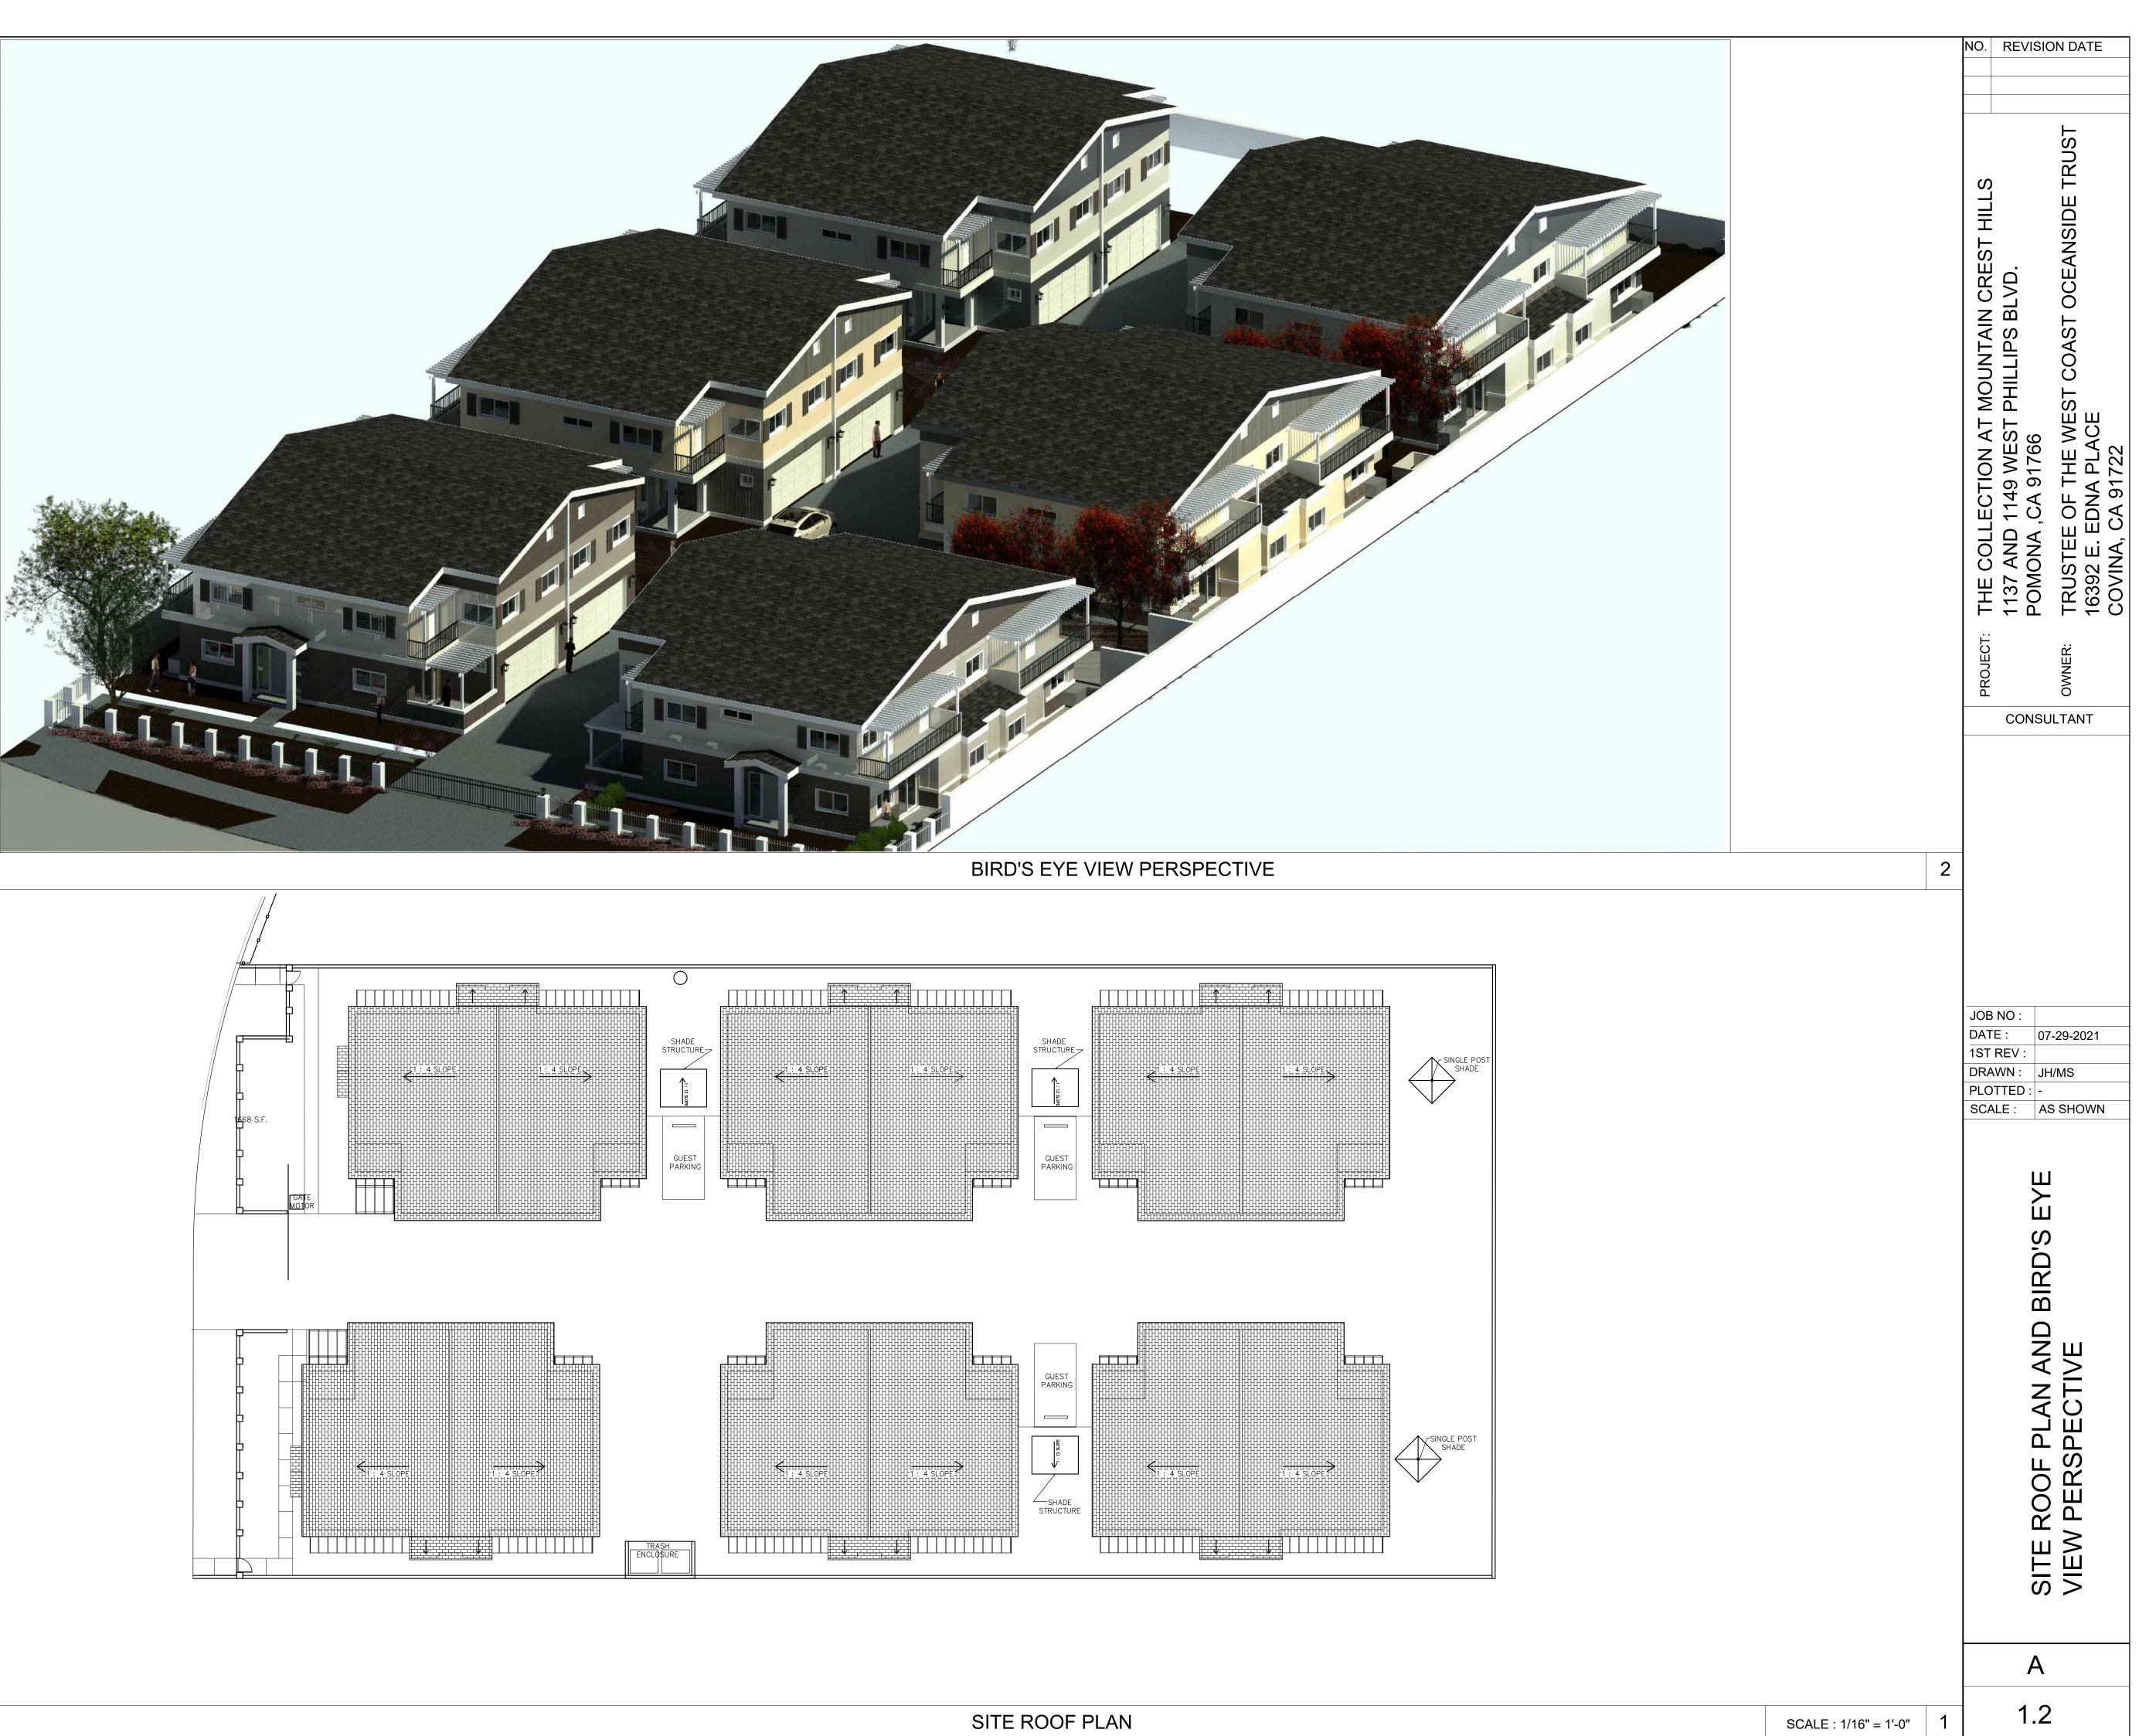


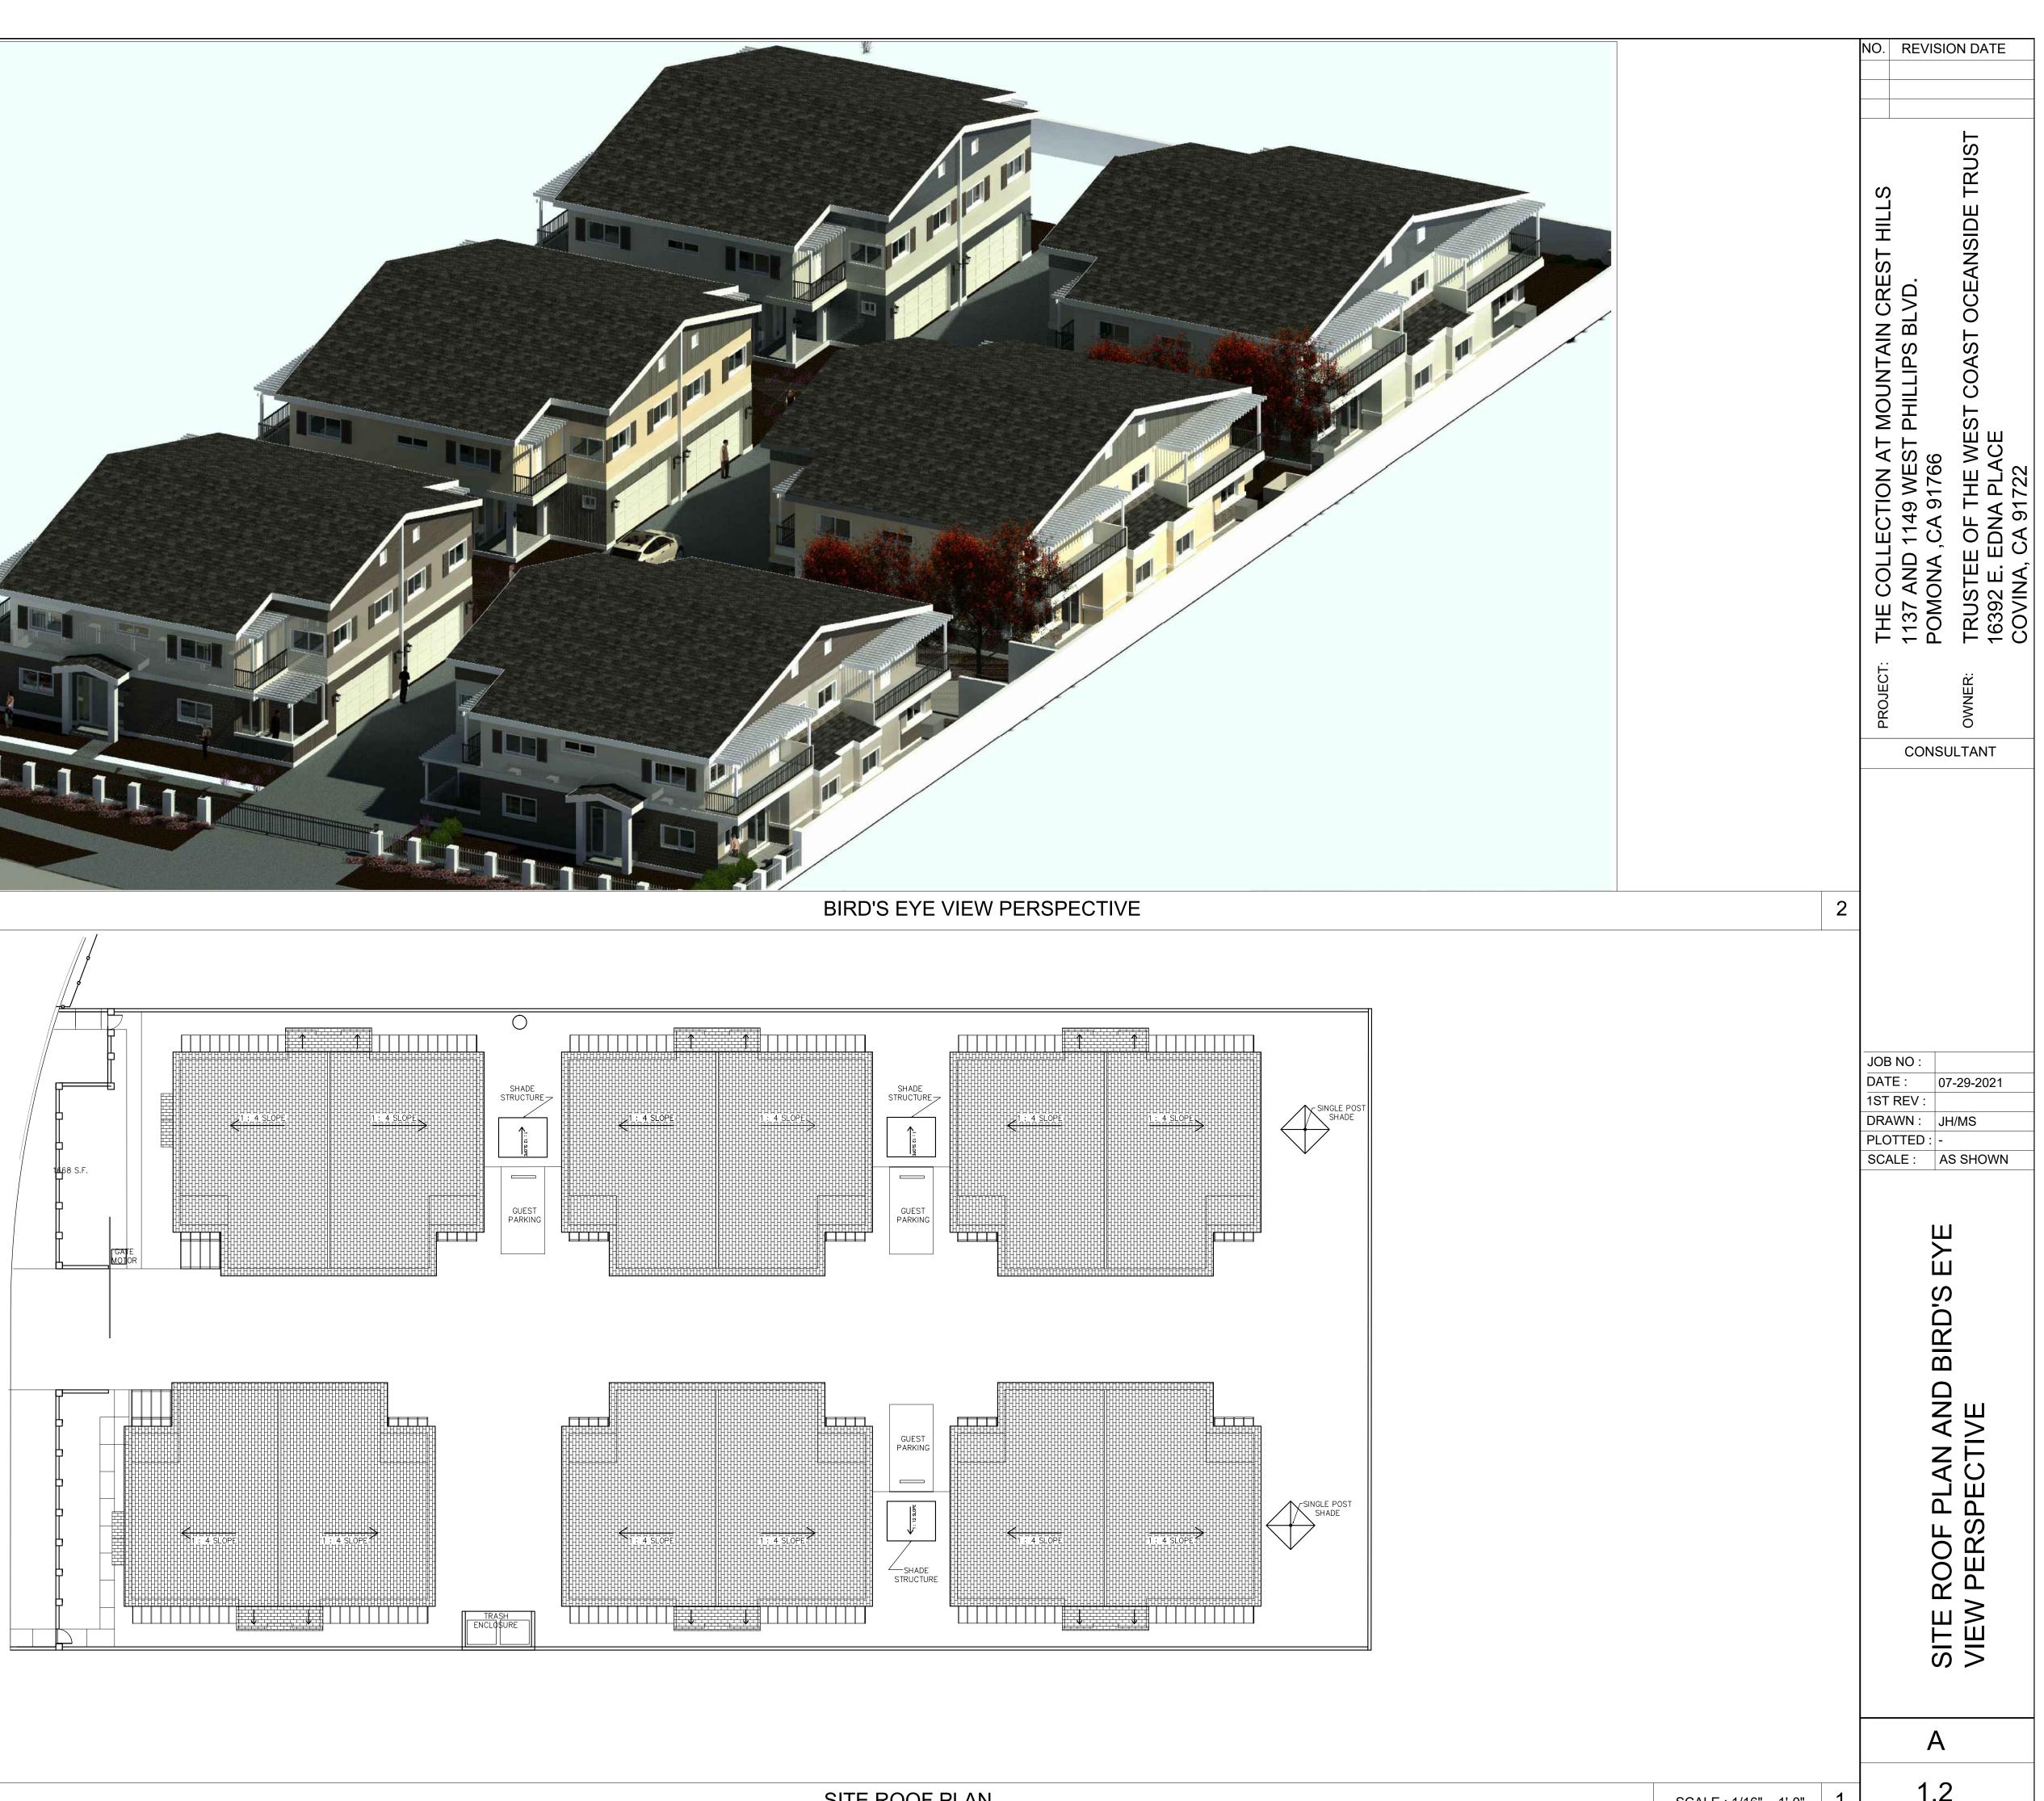




OPEN SPACE DIAGRAM

	NO. REVISION DATE
JO92 S.F. 20'-0" TIO-0" TIO-0" TIRE TURNAROUND	PROJECT: THE COLLECTION AT MOUNTAIN CREST HILLS 1137 AND 1149 WEST PHILLIPS BLVD. 1137 AND 1149 WEST PHILLIPS BLVD. POMONA ,CA 91766 OWNER: TRUSTEE OF THE WEST COAST OCEANSIDE TRUST 16392 E. EDNA PLACE COVINA, CA 91722 COVINA, CA 91722
SCALE : 1/16" = 1'-0" 2	JOB NO :
3092 S.F. 	DATE : 07-29-2021 1ST REV : DRAWN : JH/MS PLOTTED : - SCALE : AS SHOWN
	AND FIRE LANE
	OPEN SPACE A DIAGRAM
	_
	A
SCALE : 1/16" = 1'-0" 1	1.3
	L

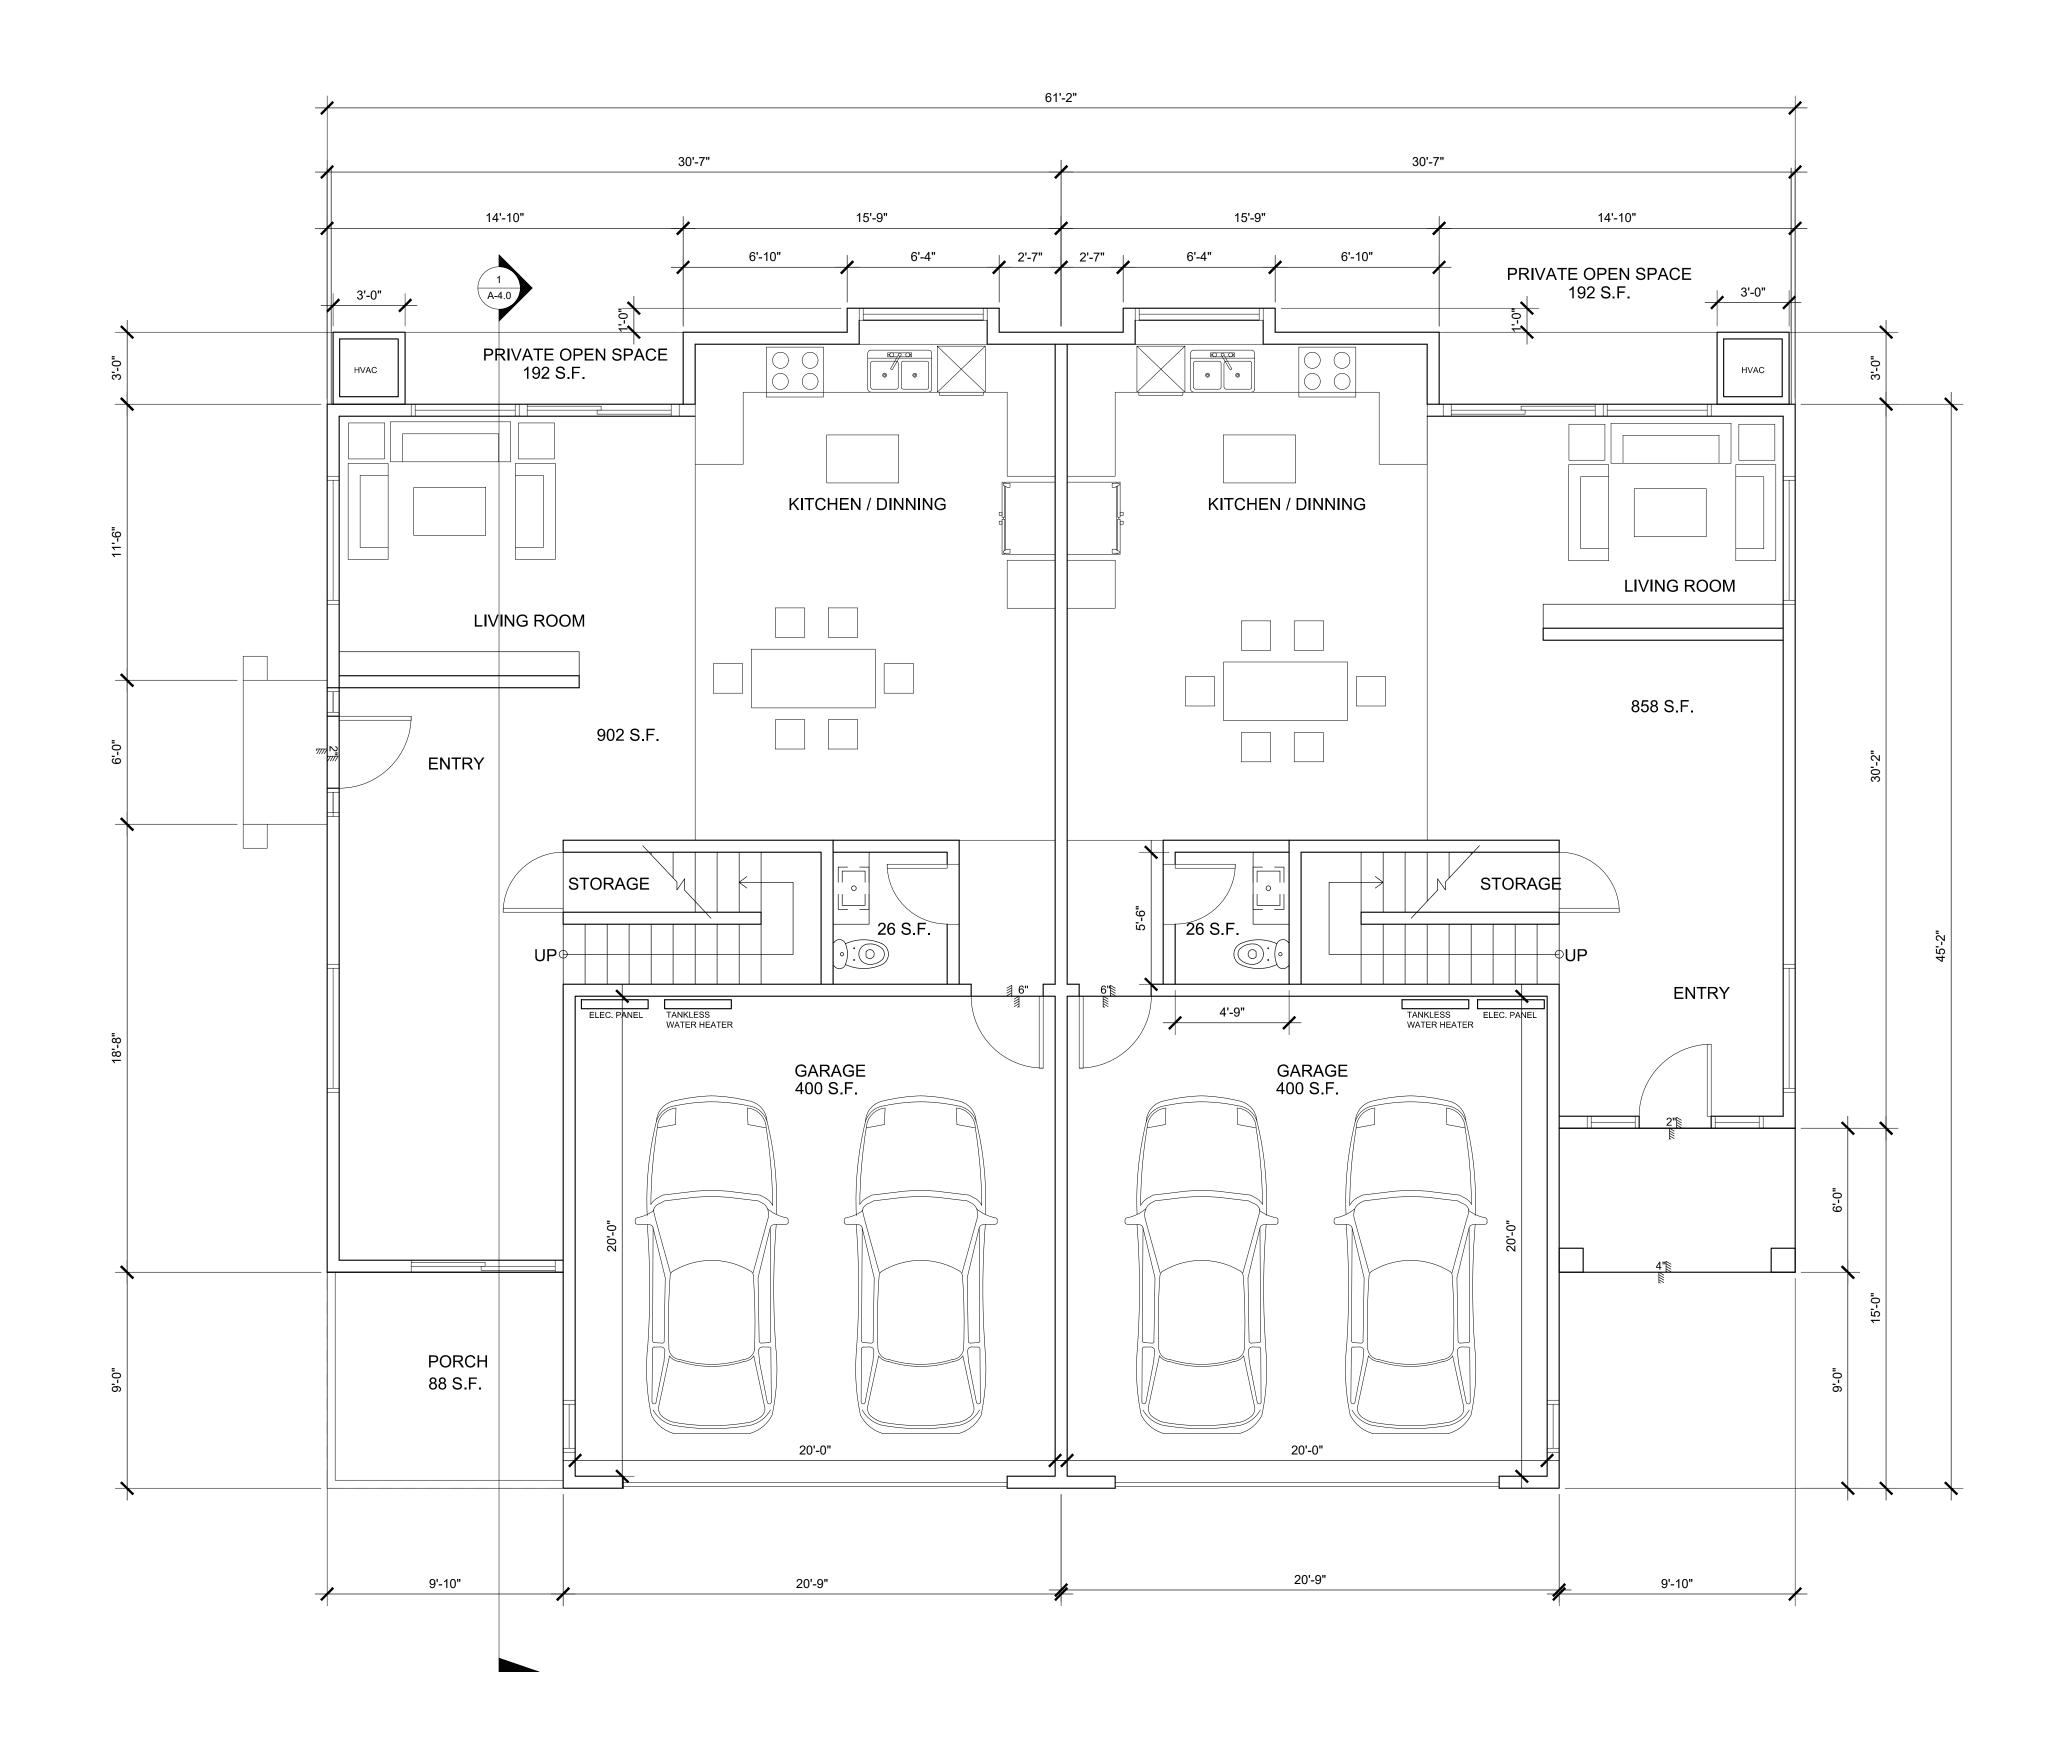


NO. REVISION DATE
PROJECT: THE COLLECTION AT MOUNTAIN CREST HILLS 1137 AND 1149 WEST PHILLIPS BLVD. 1137 AND 1149 WEST PHILLIPS BLVD. POMONA ,CA 91766 OWNER: TRUSTEE OF THE WEST COAST OCEANSIDE TRUST 16392 E. EDNA PLACE COVINA, CA 91722
JOB NO :DATE :07-29-20211ST REV :DRAWN :JH/MSPLOTTED :-SCALE :AS SHOWN
NEW FIRST FLOOR PLAN
A
2.0




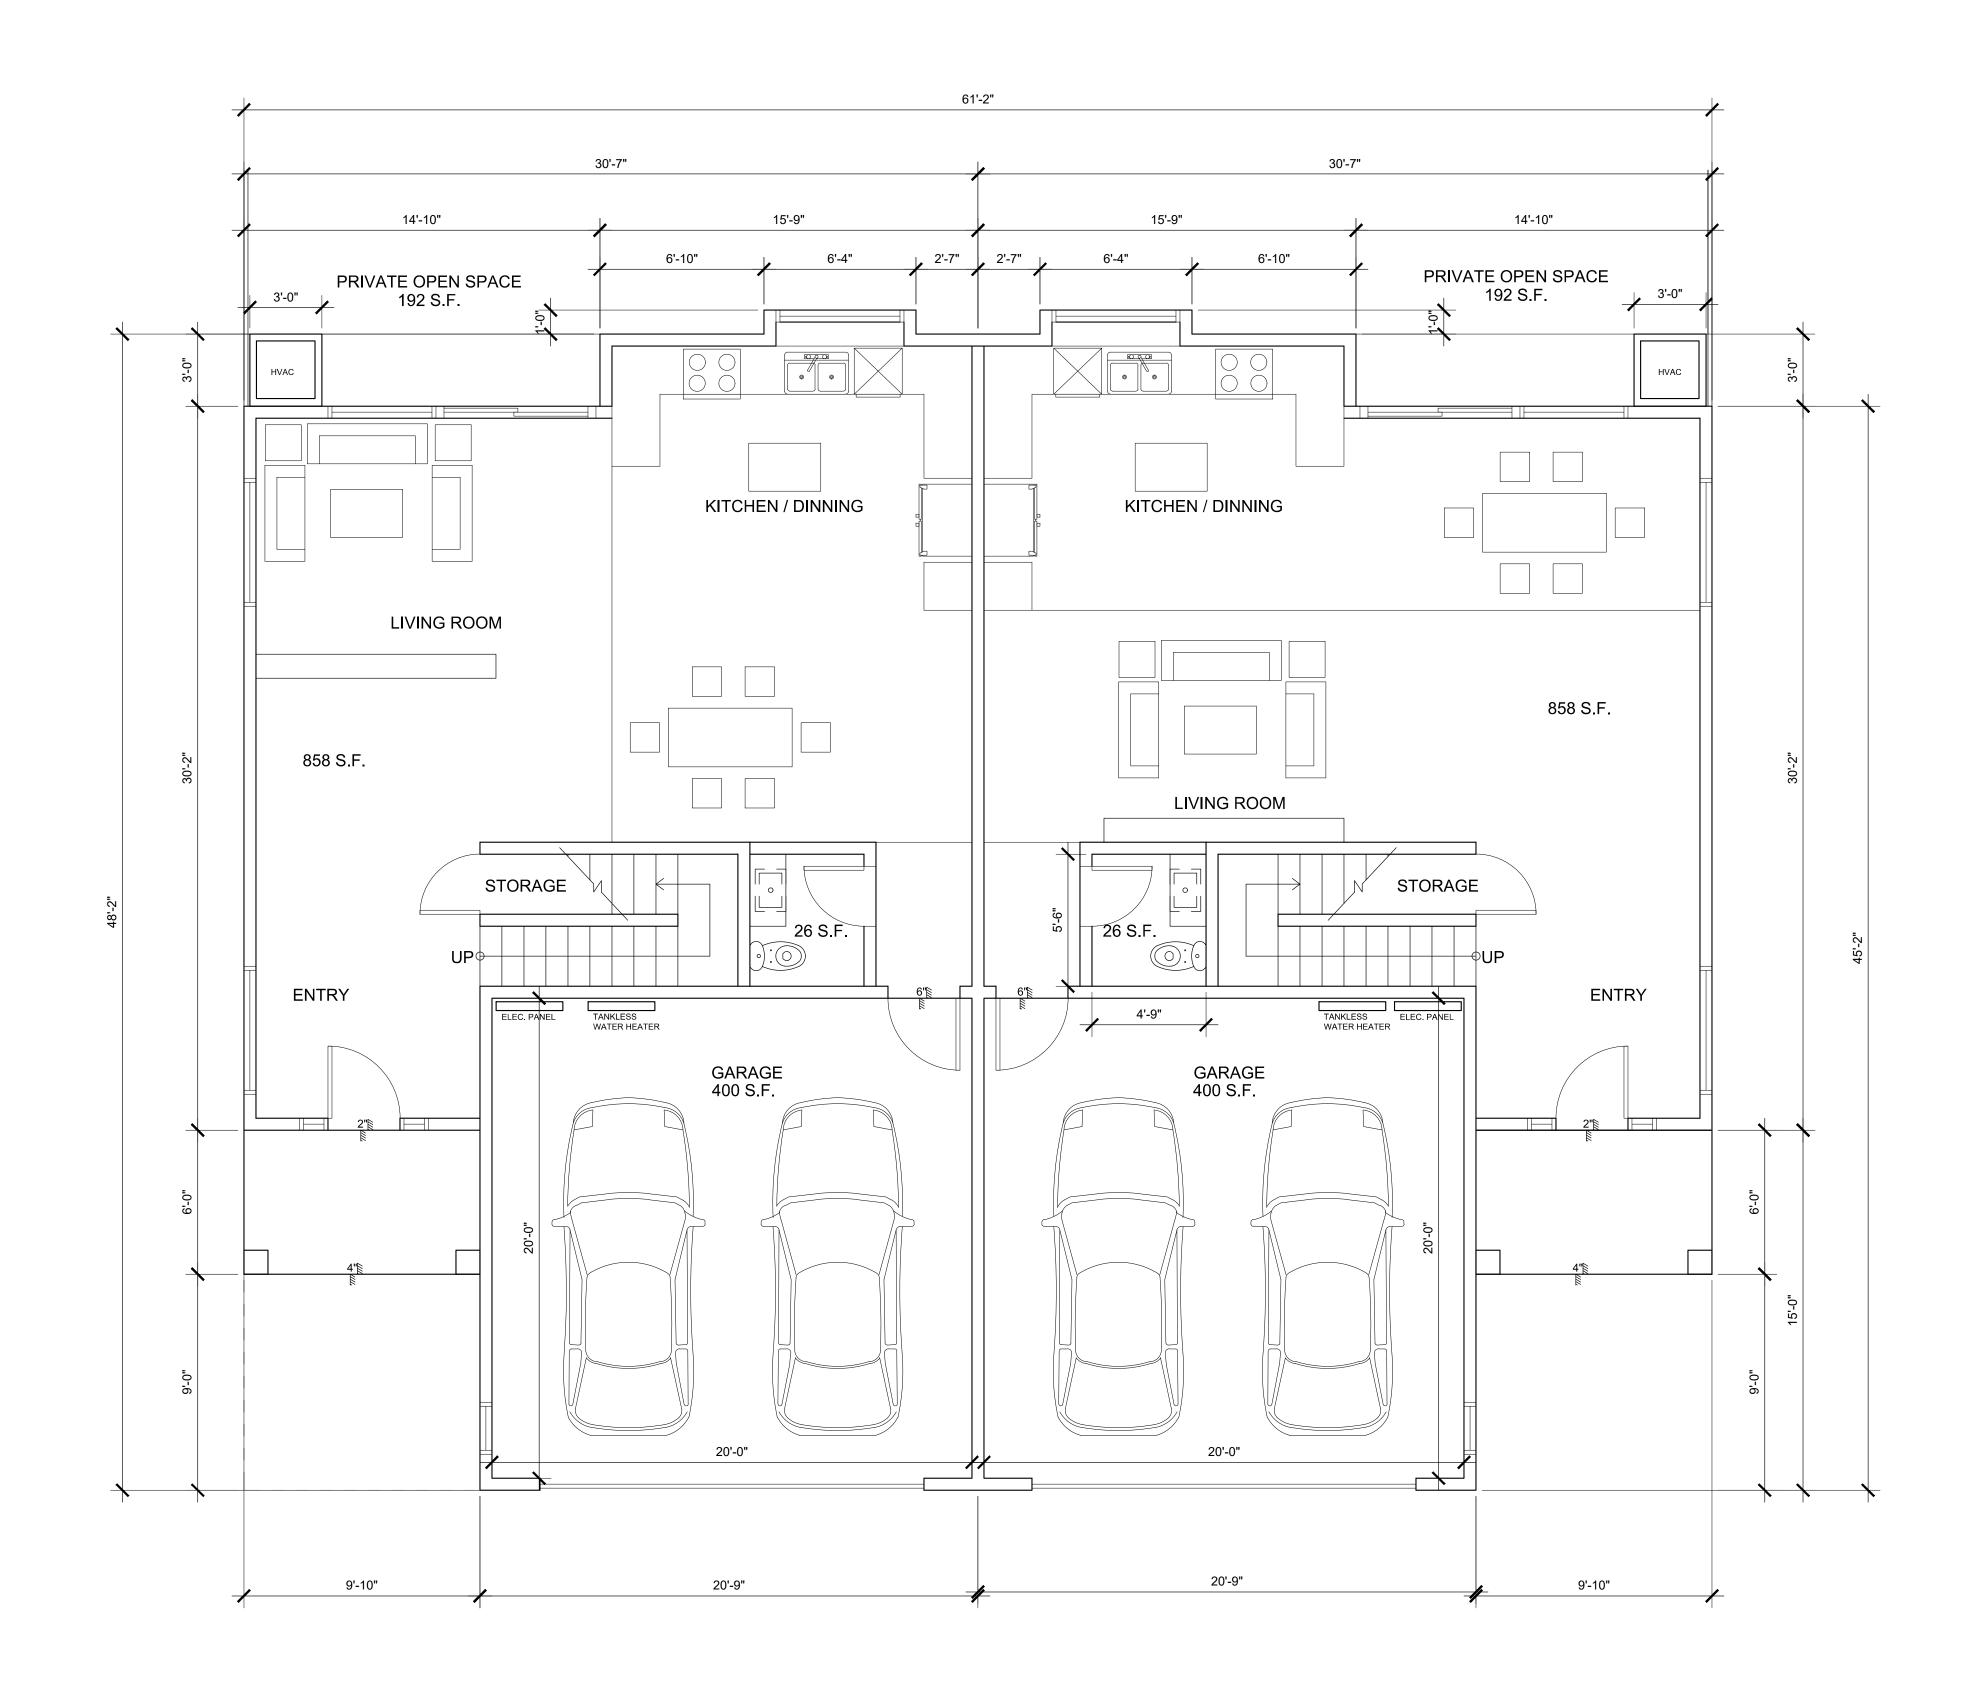


NO. R	REVISION DATE
PROJECT:	OWNER: TRUSTEE OF THE WEST FRILLIPS BLVD. POMONA, CA 91766 16392 E. EDNA PLACE COVINA, CA 91722 COVINA, CA 91722
JOB NO DATE : 1ST RE DRAWN PLOTTI SCALE	07-29-2021 EV : N : JH/MS ED : -
	NEW 3 TO 12 FIRST FLOOR PLAN
	A 2.1

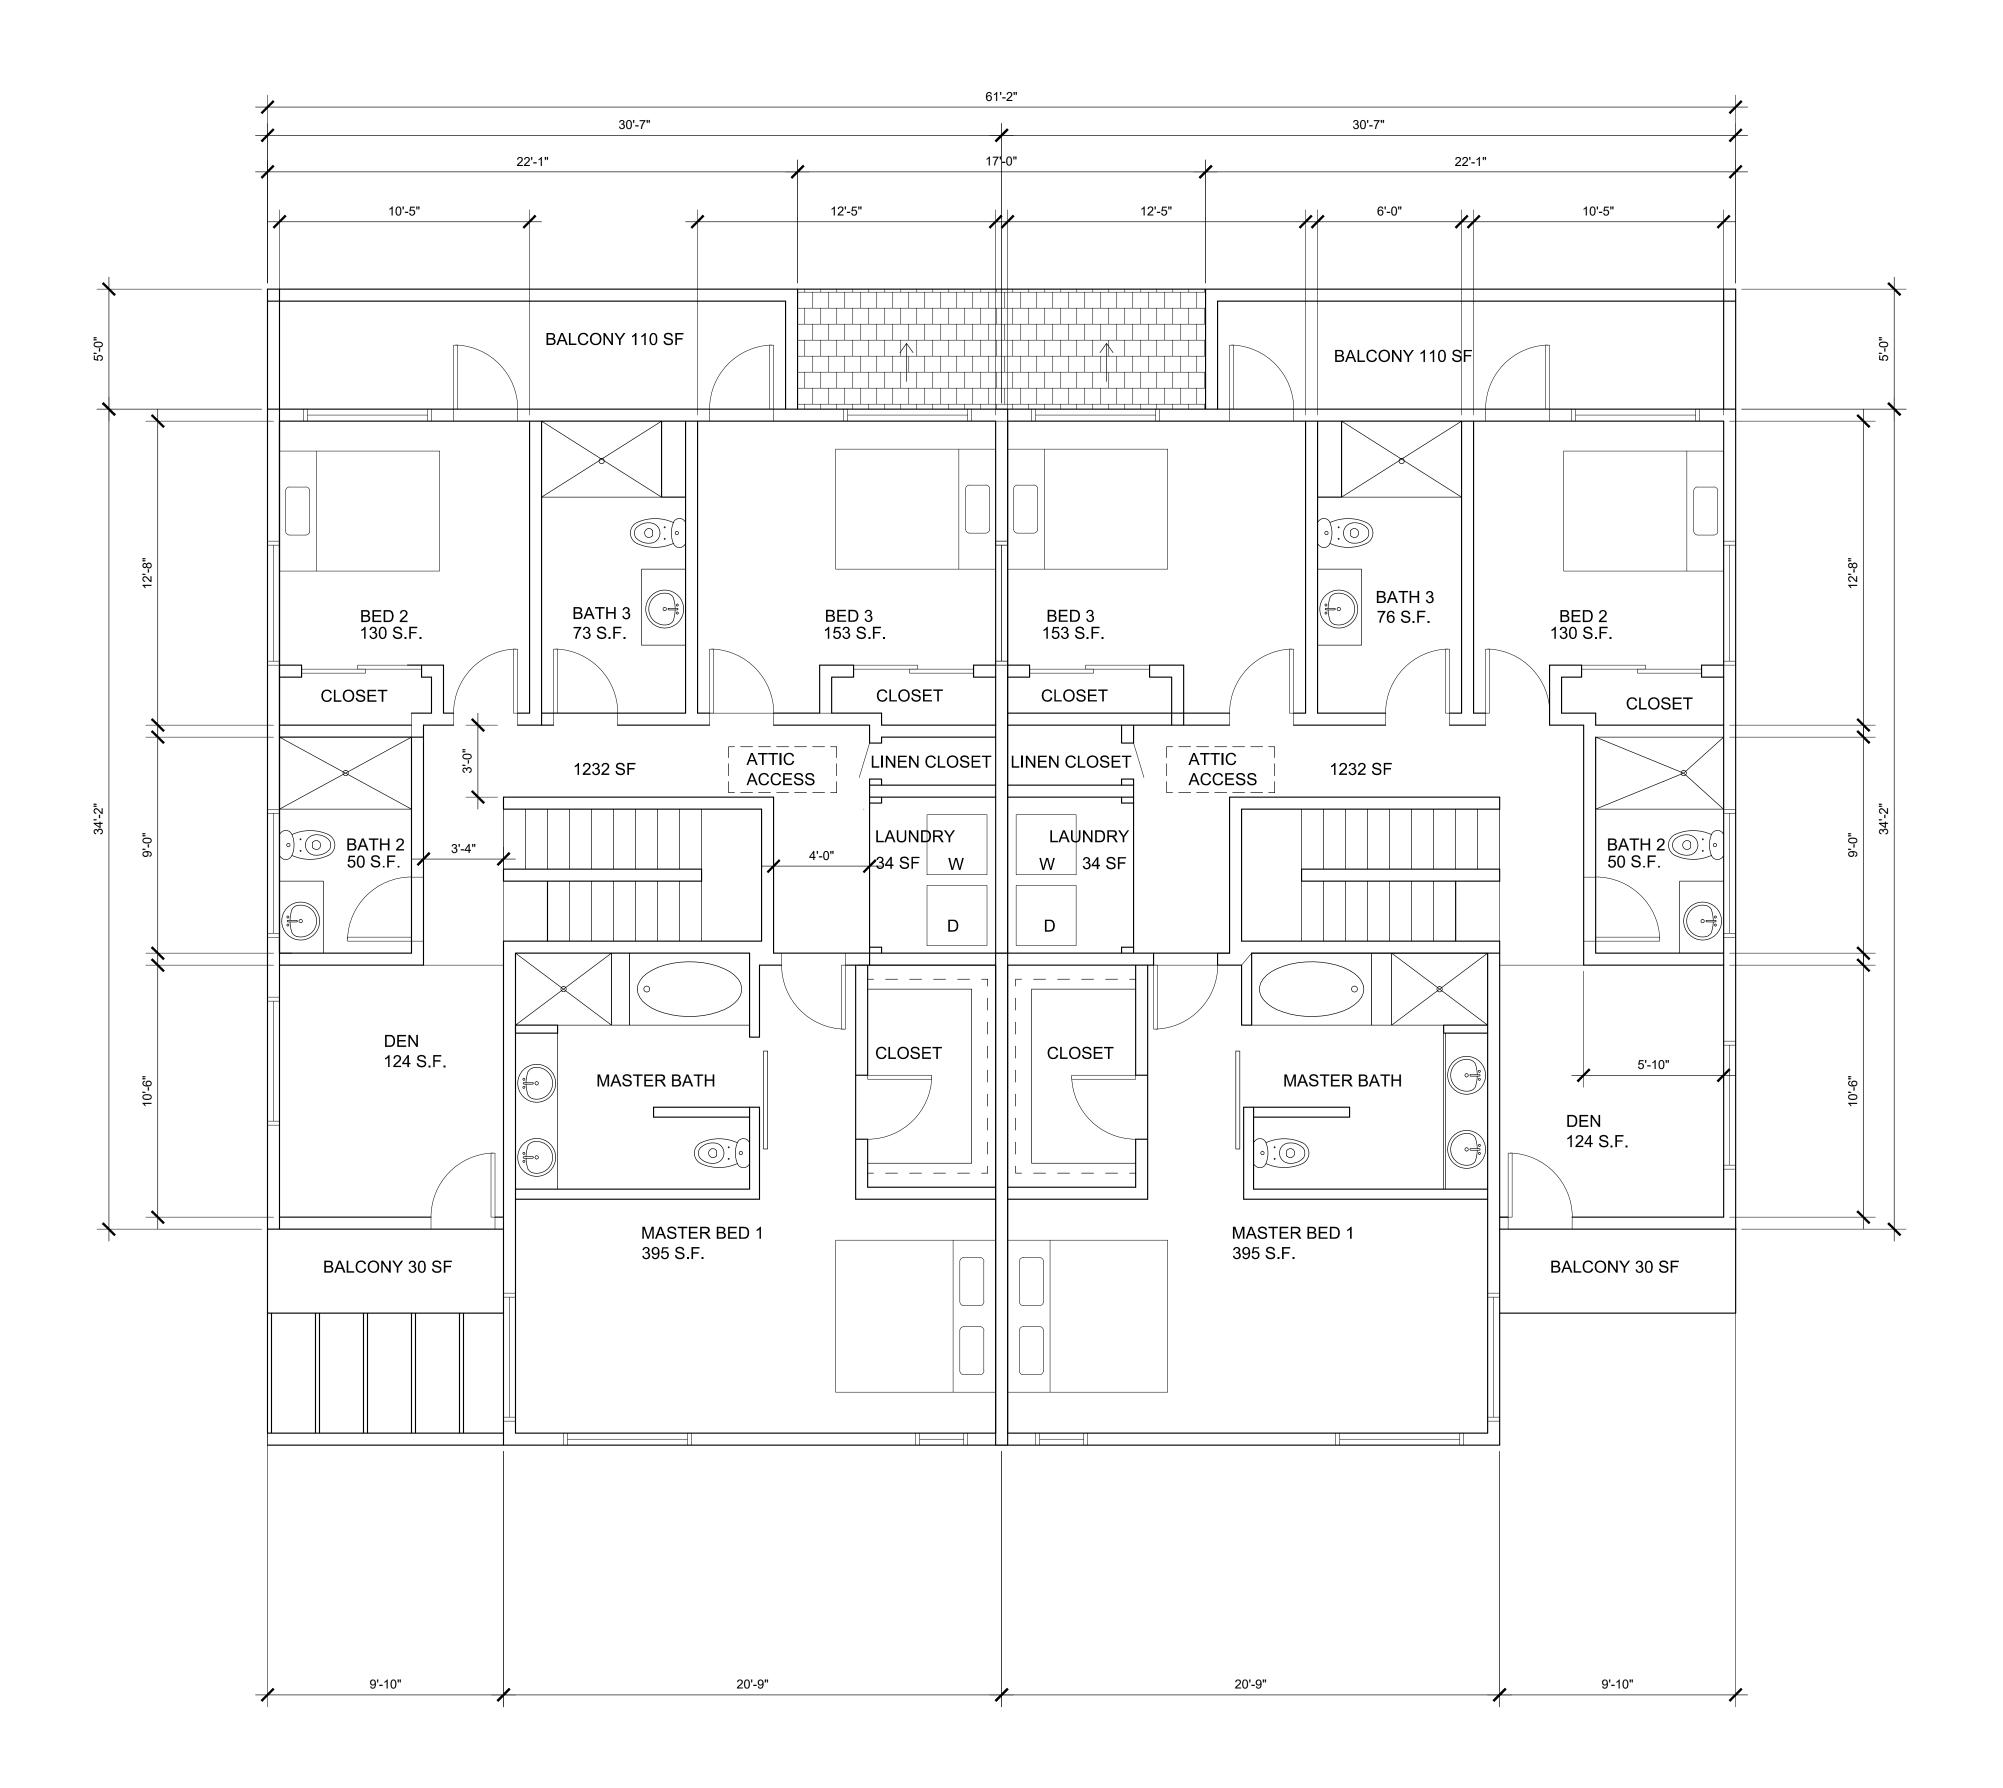


NO.	REVISION DATE
PROJECT: THE COLLECTION AT MOUNTAIN CREST HILLS	1137 AND 1149 WEST PHILLIPS BLVD. 1137 AND 1149 WEST PHILLIPS BLVD. POMONA ,CA 91766 OWNER: TRUSTEE OF THE WEST COAST OCEANSIDE TRUST 16392 E. EDNA PLACE COVINA, CA 91722
DAT IST DR/ PLC	3 NO : TE : 07-29-2021 REV : AWN : JH/MS DTTED : - ALE : AS SHOWN
	NEW UNIT 1 AND UNIT 2 SECOND FLOOR PLAN
	A
	2.2

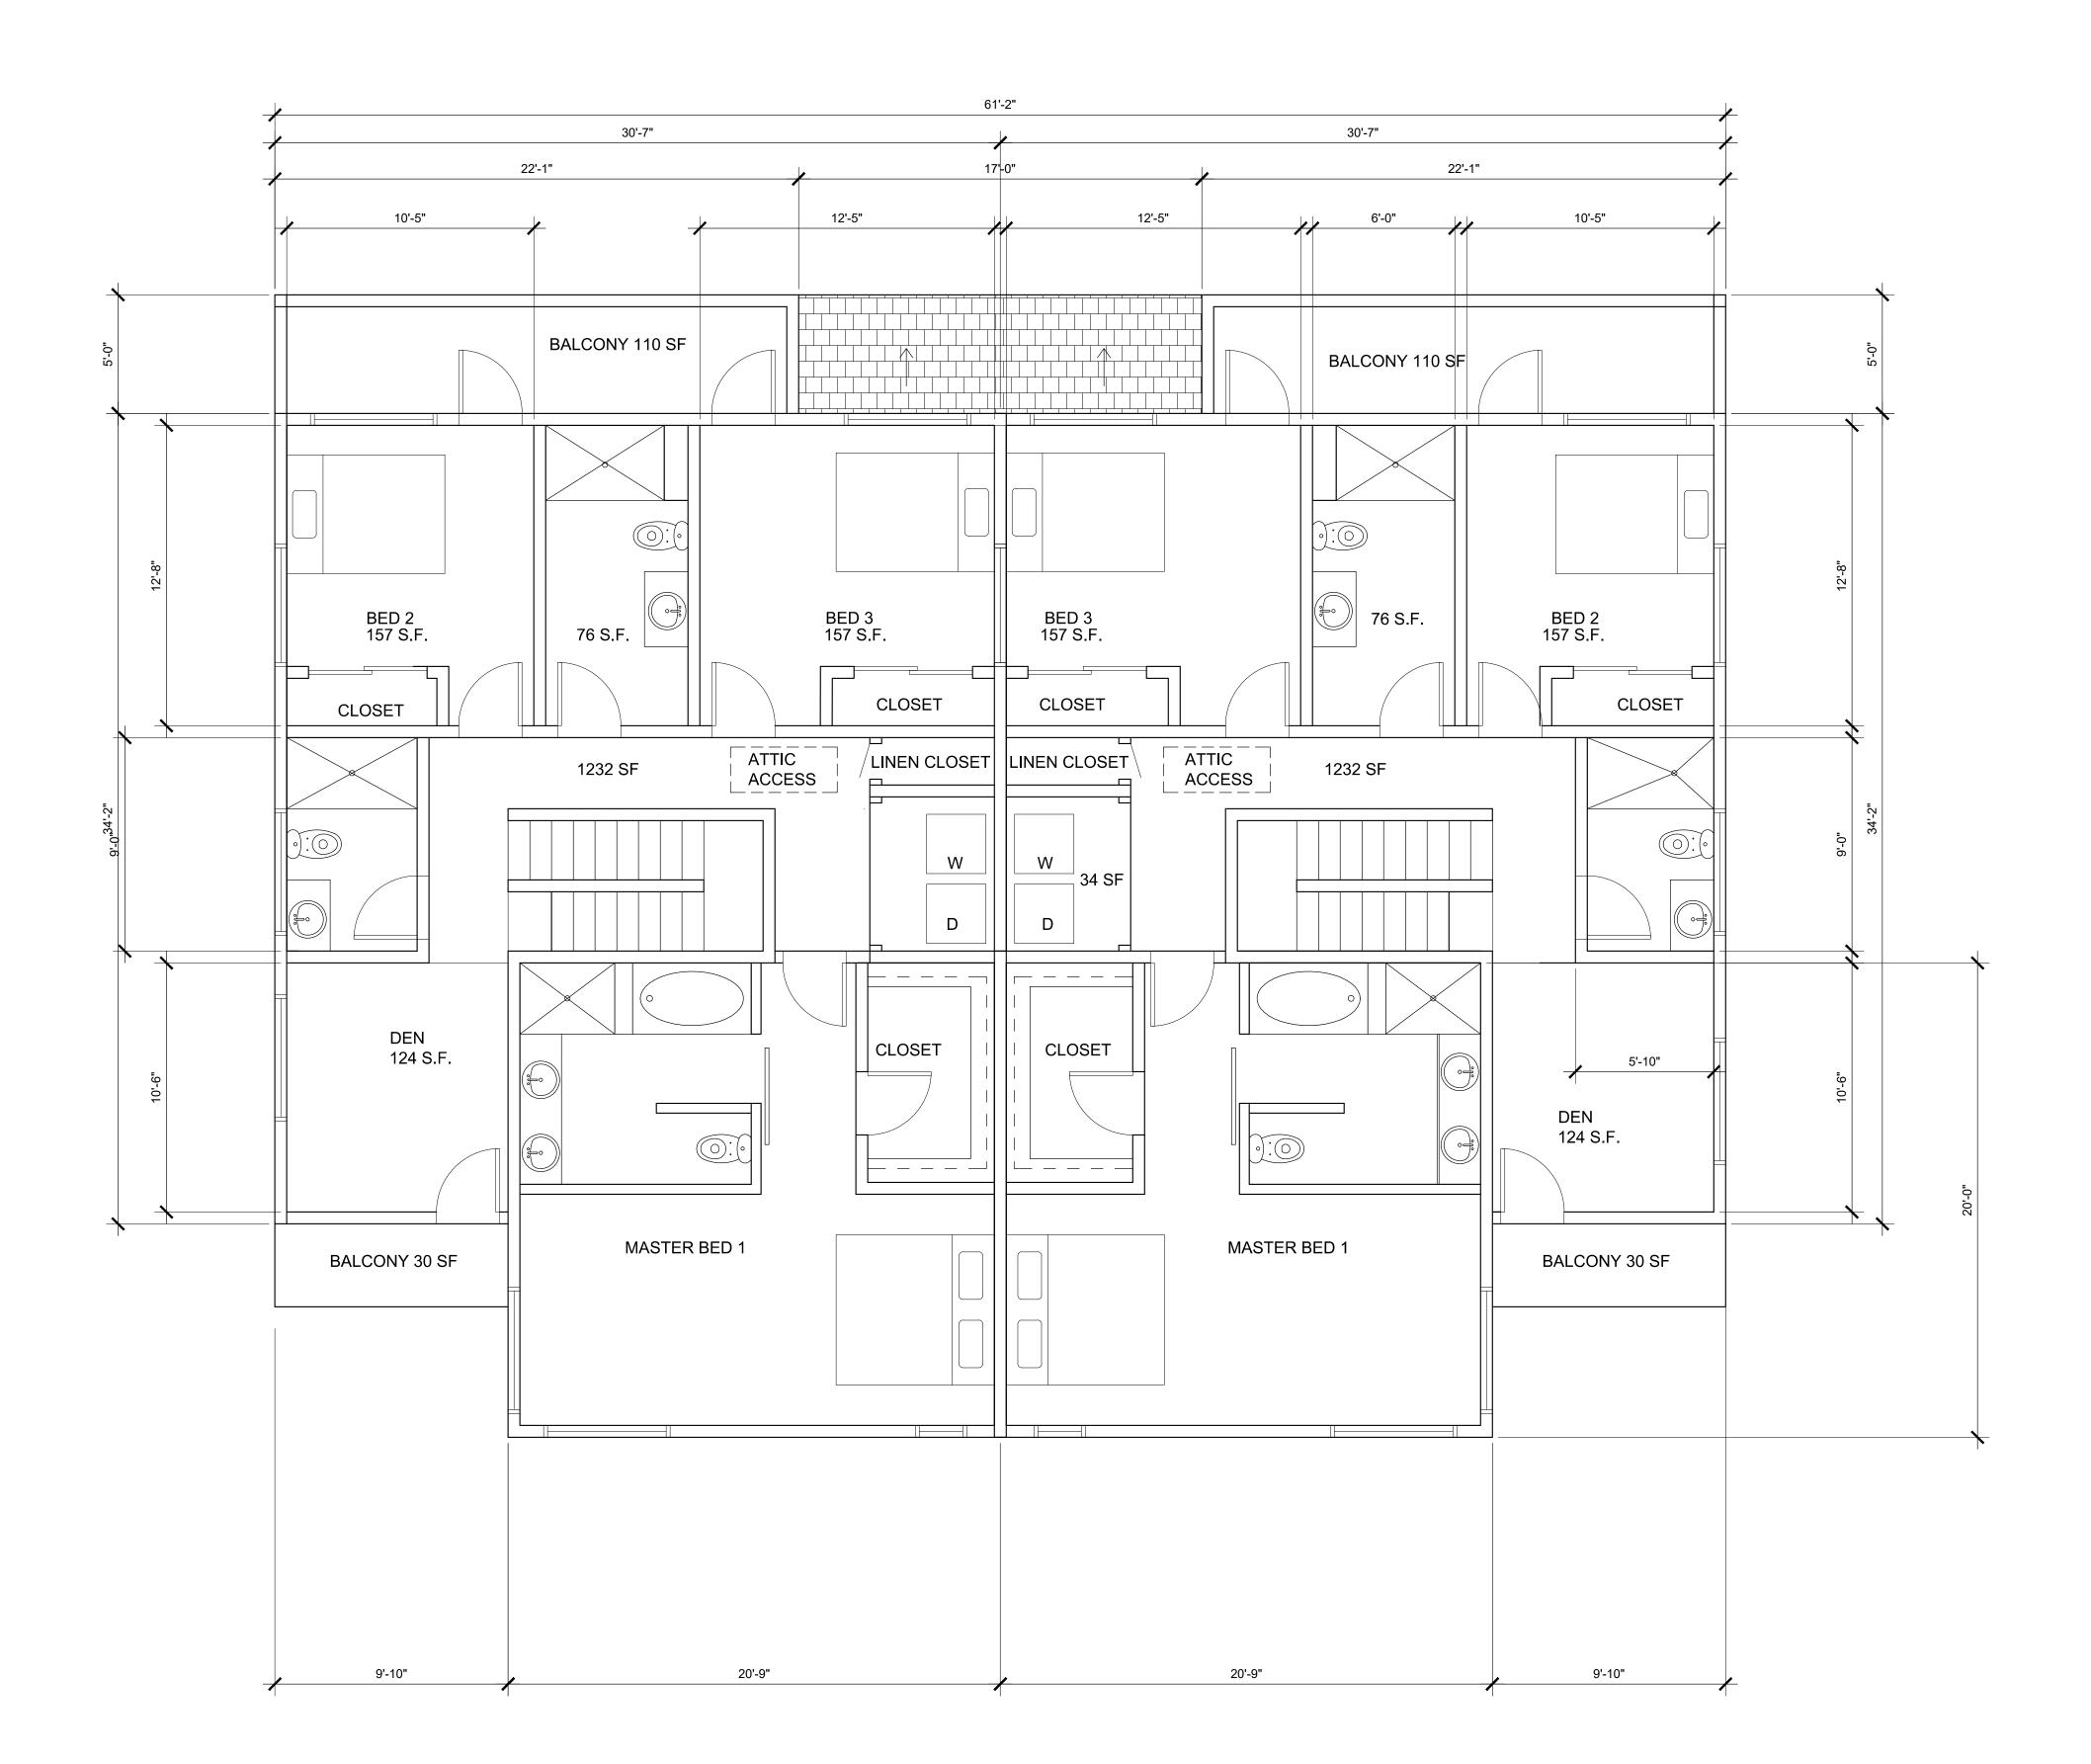


NO.	REVIS	SION DATE
PROJECT: THE COLLECTION AT MOUNTAIN CREST HILLS	DOMONA CA 91766	OWNER: TRUSTEE OF THE WEST COAST OCEANSIDE TRUST 16392 E. EDNA PLACE COVINA, CA 91722
JOB N DATE 1ST R DRAV PLOT SCAL	E : REV : WN :	07-29-2021 JH/MS - AS SHOWN
	NEW LINIT 3 TO LINIT 12 SECOND	J
	A	•
	2.	3

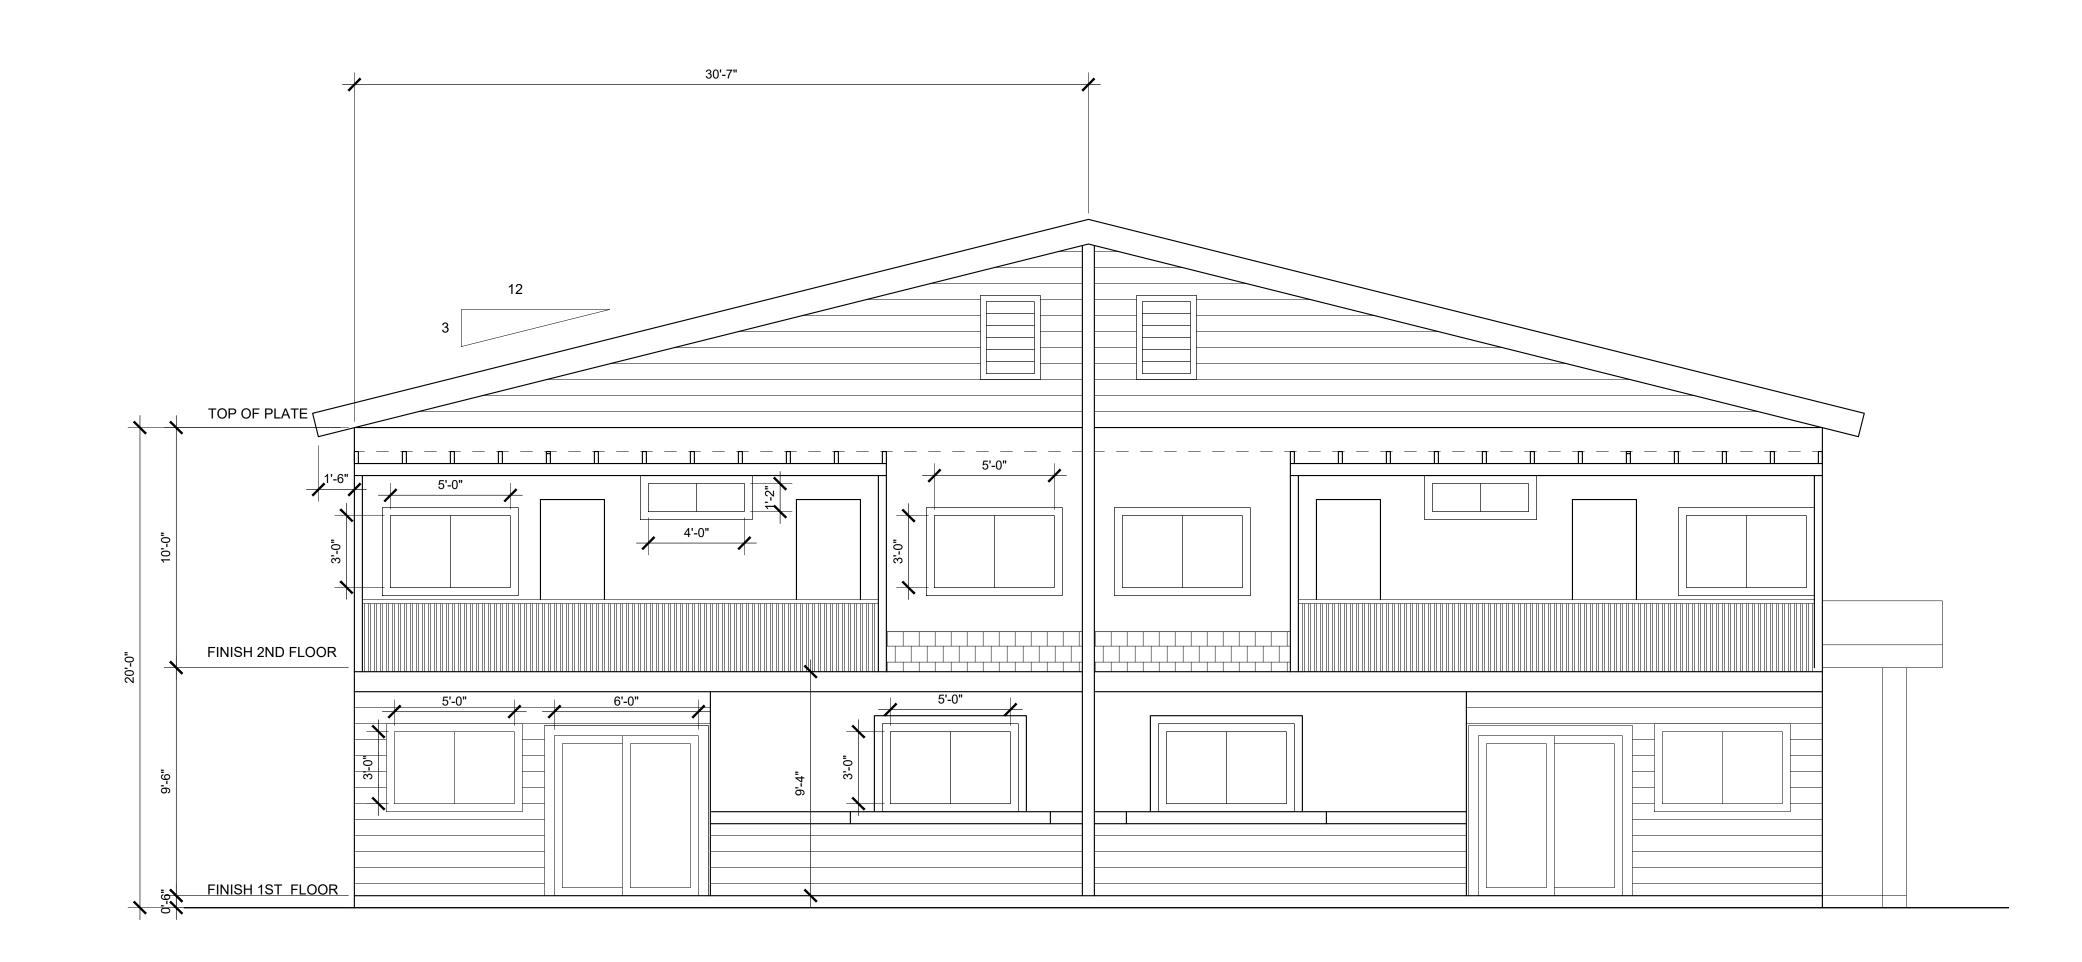

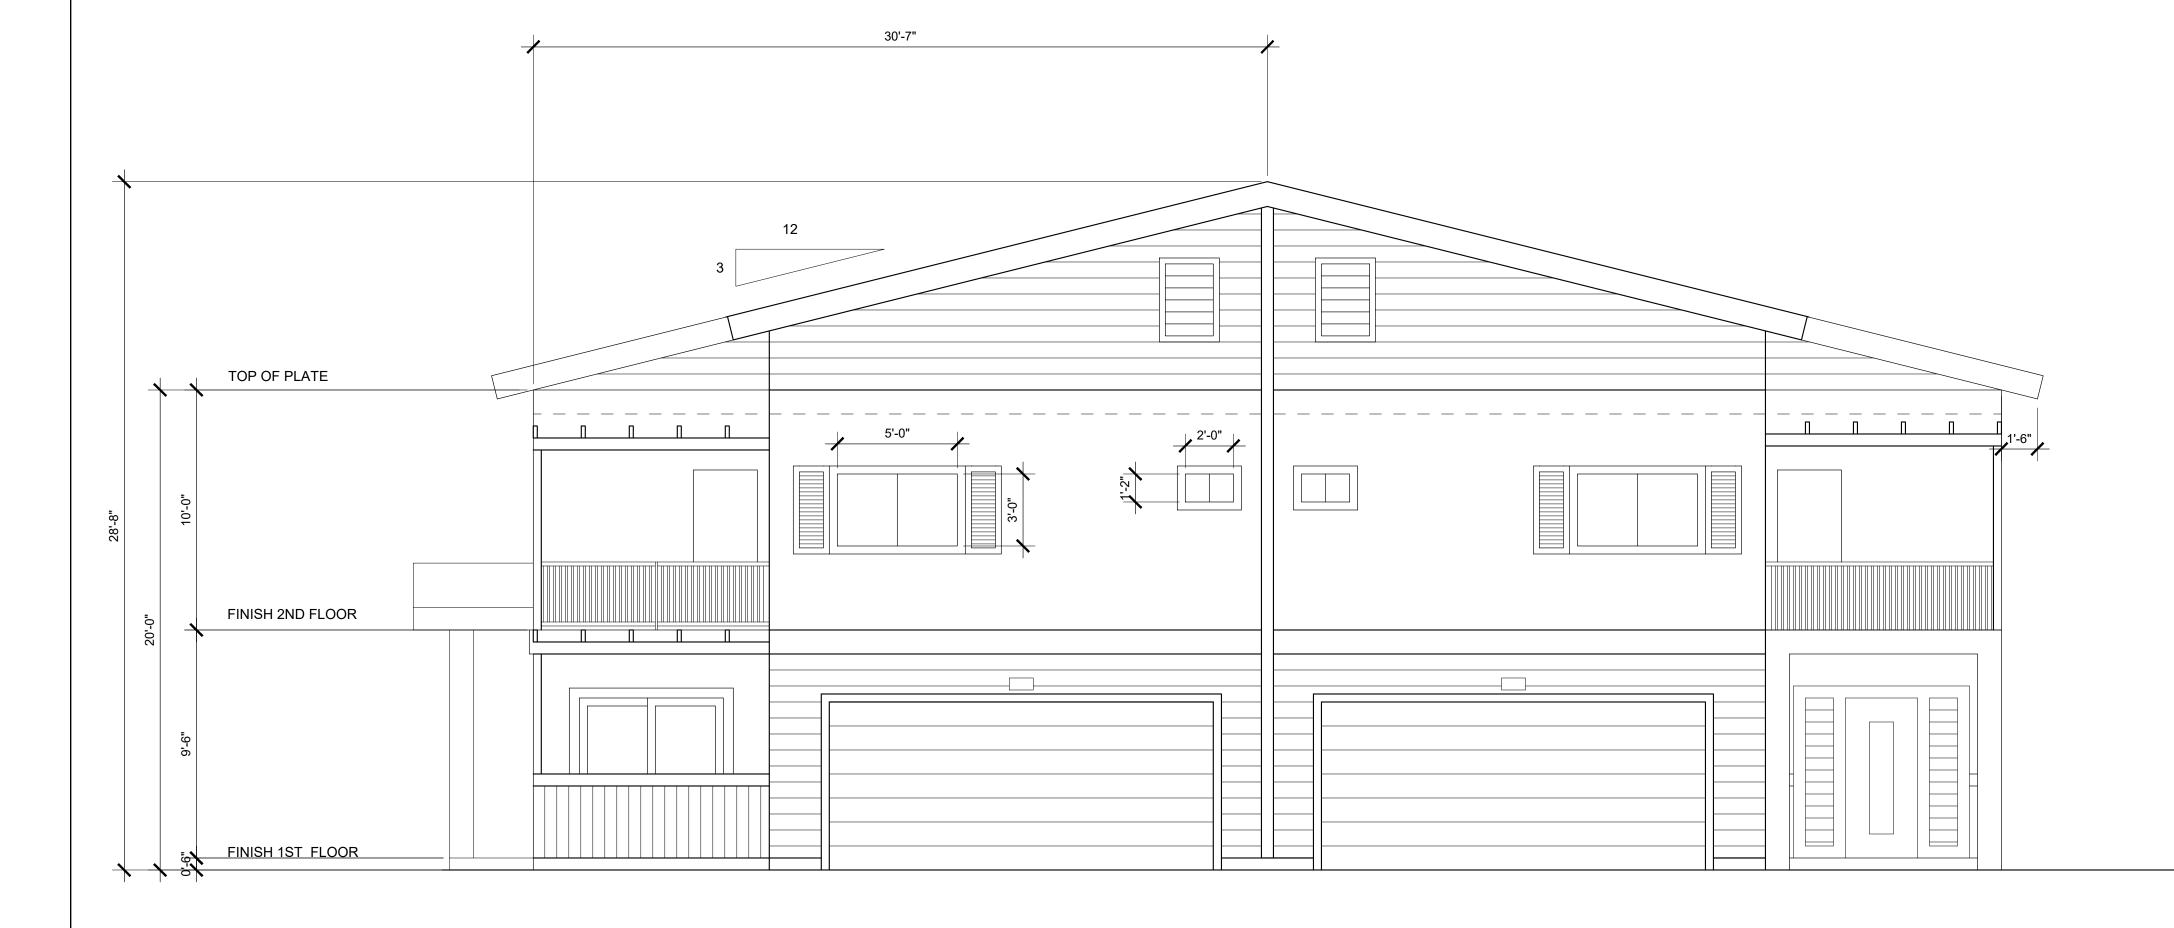

TYPICAL REAR ELEVATIONS

	NO. REVISIO	ON DATE
	PROJECT: THE COLLECTION AT MOUNTAIN CREST HILLS 1137 AND 1149 WEST PHILLIPS BLVD. POMONA ,CA 91766	TRUSTEE OF THE WEST COAST OCEANSIDE TRUST 16392 E. EDNA PLACE COVINA, CA 91722
SCALE : 1/4" = 1'-0" 2		
	1ST REV :DRAWN :JHPLOTTED :	7-29-2021 I/MS S SHOWN
	NEW EXTERIOR ELEVATIONS	
SCALE : 1/4" = 1'-0" 1	3.	4 .0

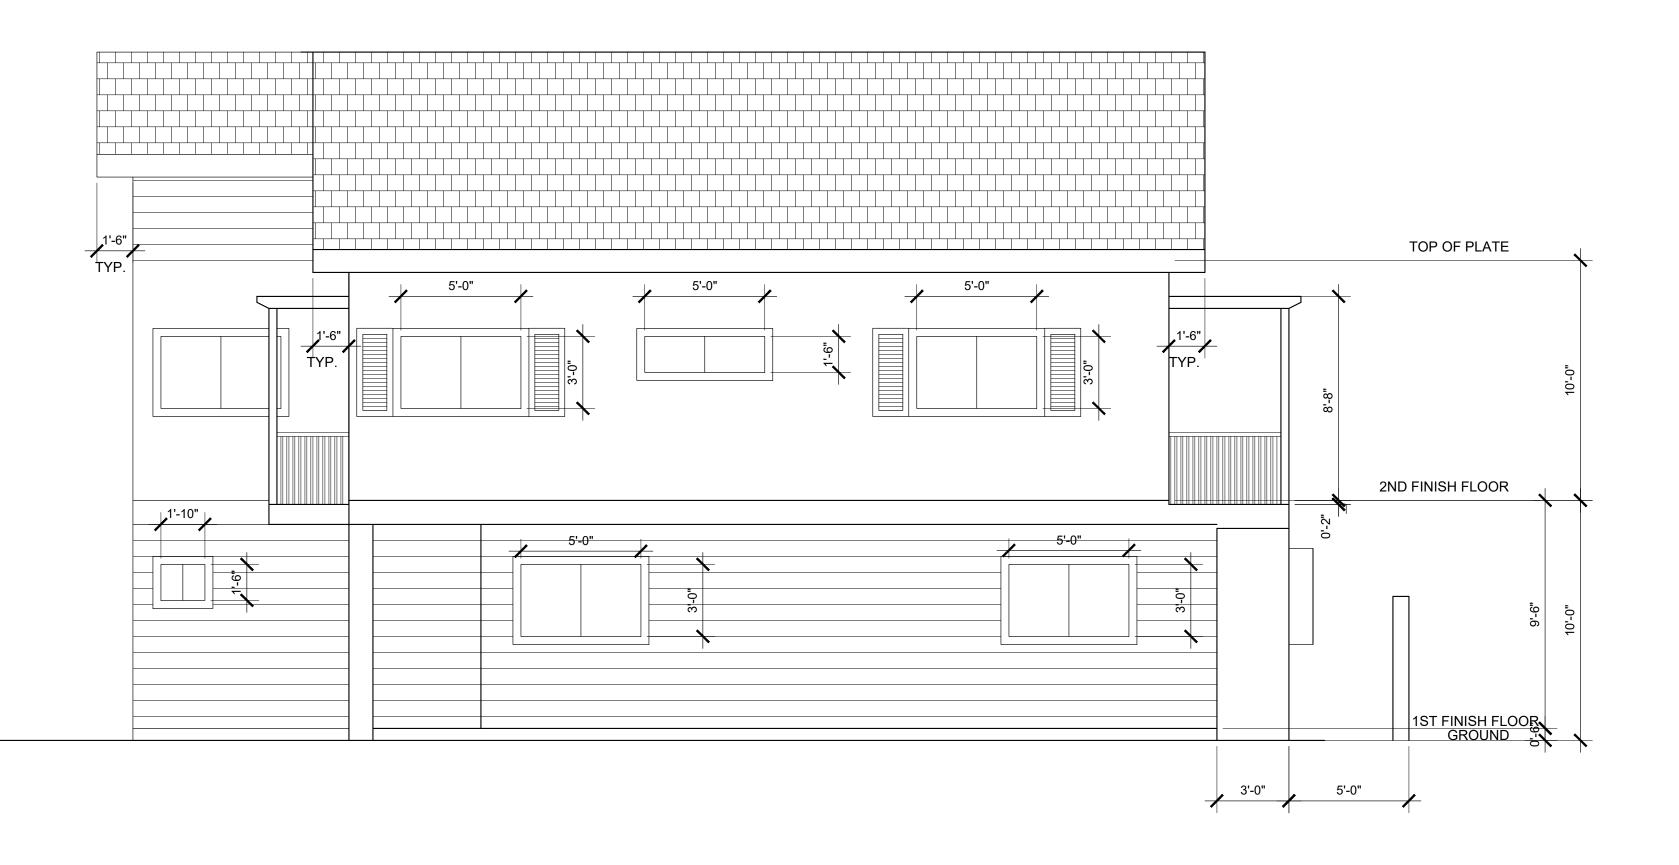



TYPICAL RIGHT ELEVATIONS

TYPICAL LEFT ELEVATIONS

SCALE

		NO.	REVISIO	ON DATE
		PROJECT: THE COLLECTION AT MOUNTAIN CREST HILLS	1137 AND 1149 WEST PHILLIPS BLVD. POMONA ,CA 91766	OWNER: TRUSTEE OF THE WEST COAST OCEANSIDE TRUST 16392 E. EDNA PLACE COVINA, CA 91722
: 1/4" = 1'-0"	2			
		DAT 1ST DRA	REV : WN : J⊦ TTED : -	2-29-2021 I/MS S SHOWN
				۹
: 1/4" = 1'-0"	1		3	





SHERWIN WILLIAMS HO	STV HOM
A: PURE WHITE:	HGSV
B: OUTERBANKS:	HGSV
C: STONE STATUE:	HGSV
D: DOYLE GOLD:	HGSV
E: MEADOW SAGE:	HGSV
F: WINDSWEPT CLIFF:	HGSV
G: JAGGED GRANITE:	HGSV





SHERWIN WILLIAMS HGT
A: PURE WHITE: B: OUTERBANKS: C: STONE STATUE: D: DOYLE GOLD: E: MEADOW SAGE: F: WINDSWEPT CLIFF: G: JAGGED GRANITE:

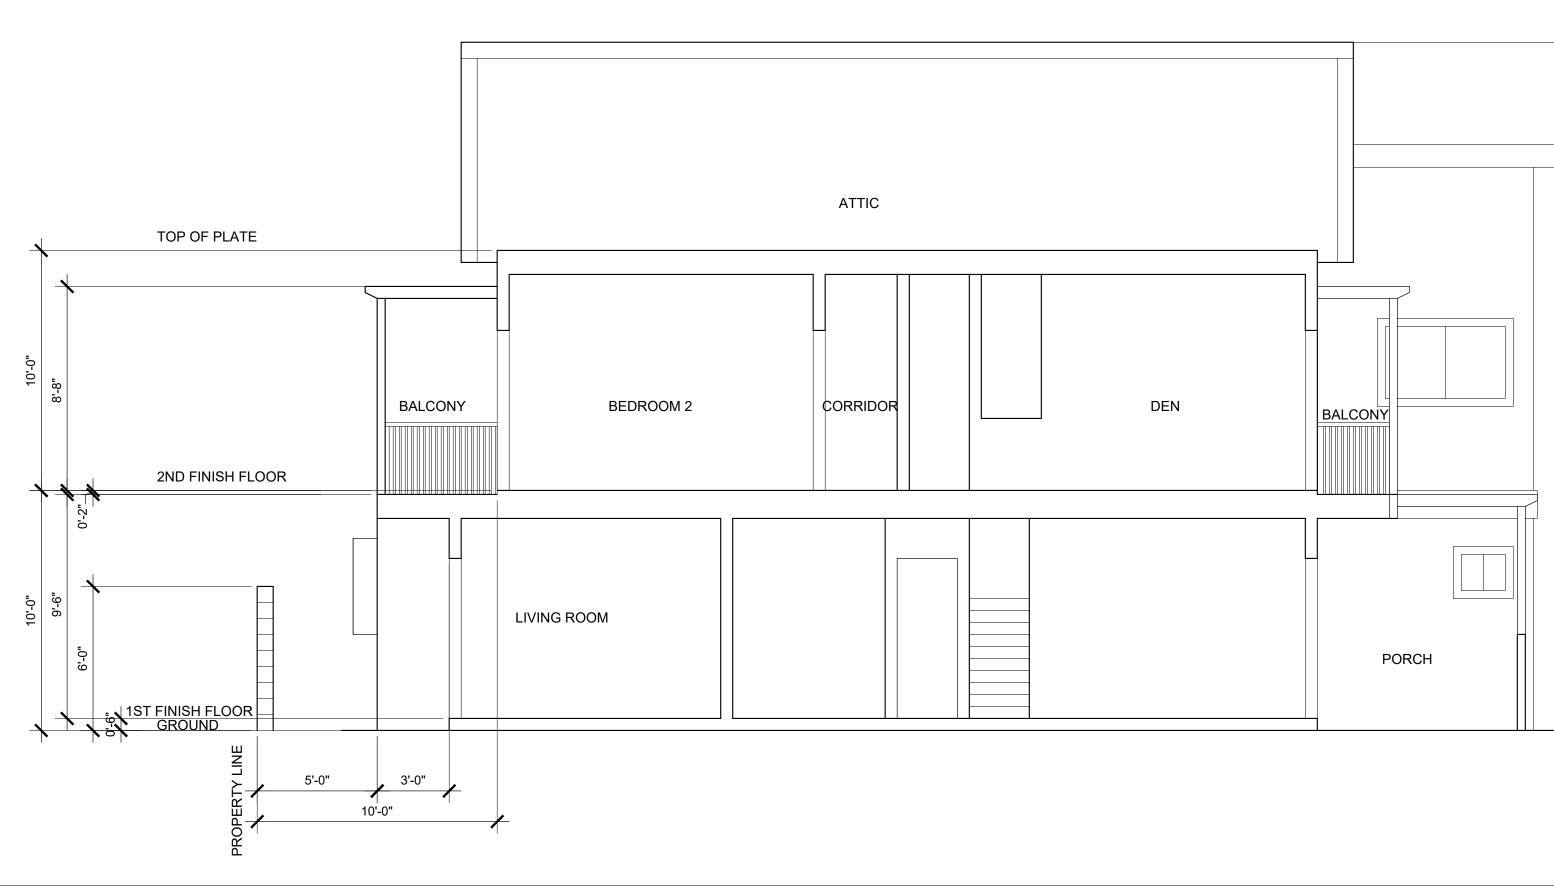


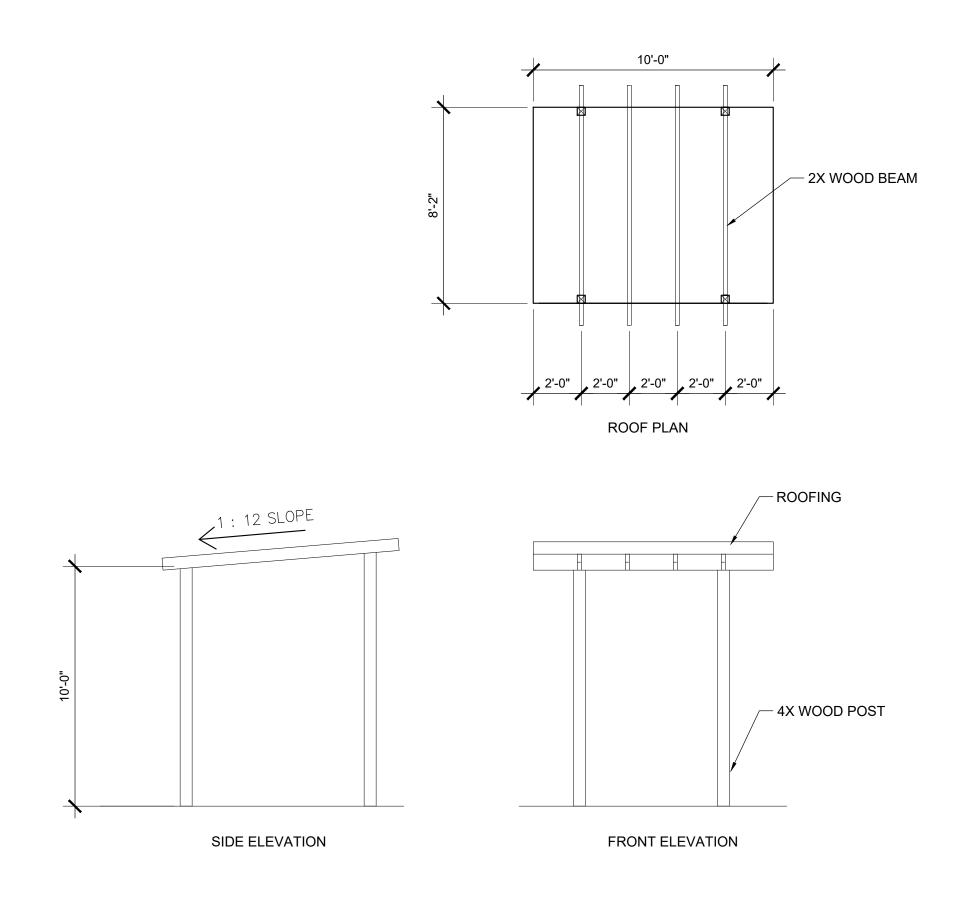



SCALE

	NO. REVISION DATE	
	PROJECT: THE COLLECTION AT MOUNTAIN CREST HILLS	1137 AND 1149 WEST PHILLIPS BLVD. POMONA ,CA 91766 OWNER: TRUSTEE OF THE WEST COAST OCEANSIDE TRUST 16392 E. EDNA PLACE COVINA, CA 91722 COVINA, CA 91722
.E : 1/4" = 1'-0" 2		
	DAT 1ST DRA PLO	BUILDING SUPPORTUCE IN TREV : 07-29-2021 REV : JH/MS TTED : - ALE : AS SHOWN ALE : AS SHOWN
.E : 1/4" = 1'-0" 1		A 4.0

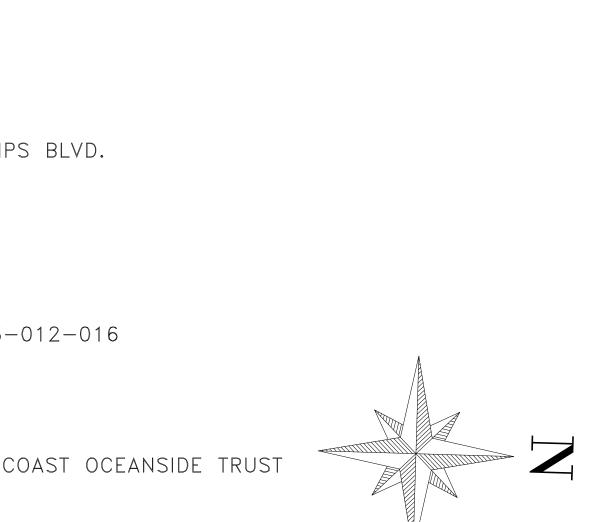

S¢ALE: 1"≠20'

50'

RD

 \triangleleft

⊇ш₩

sewer/

MANHOLE

STORM DRAIN_ CATCH BASIN

/ REMOVE DRIVE APPROACH / AND REPLACE WITH S/W

DRIVE-

APPROACH CURB-

FD 2" I.P. PER RS 68/4

REMOVE DRIVE APPROACH AND REPLACE WITH S/W

501

DIRECTION

JANUARY 26, 2021

<u>SITE ADDRESS:</u> 1137 & 1149 W. PHILLIPS BLVD. POMONA, CA 91766

TOTAL LOT AREA: 37,164 SF

APN: 8343-012-015 & 8343-012-016

OWNER & SUBDIVIDER: KHURSHID KHAN TRUSTEE OF THE WEST COAST OCEANSIDE TRUST 16329 E. EDNA PLACE COVINA, CA 91722 TEL. 310.779.5226

<u>SURVEYOR:</u>



BASIS OF BEARING:

THE CENTER LINE OF PHILLIPS BOULEVARD BEING N 88°21'37" E AS SHOWN ON POMONA HEIGHTS ADDITION TRACT, M.R. 24, PAGES 97-98

BENCHMARK:

BRASS DISC IN W CB @ N END C.B. 39.4FT N/O BCR @ NW COR WHITE AVE & PHILLIF BLVD MKD (YLF 107 1994)

M

(N 01°41'07" W)

ίω HAMILTON

™ BOULEVARD


EASEMENTS:

THERE IS NO EXISTING EASEMENTS IN THESE PROPERTIES.

General plan: Residential neighborhood R2 S Overlay Zone: Multi-family Land Use:

NOTES:

- 1. EXISTING LAND USE: RESIDENTIAL
- 2. EXISTING IMPERVIOUS SQ. FOOTAGE: 0 S.F
- 3. PROPOSED IMPERVIOUS SQ. FOOTAGE: 30690 S
- 4. NEAREST BUS STOP LOCATED AT THE INTERSECTION OF PHILLIPS BLVD & GAREY AVE.. DISTANCE TO THE NEAREST BUS STOP IS APPROX. 4,260 FT.
- 5. EXISTING BUILDINGS ARE TO BE REMOVED.
- 6. NO FILLED AREAS EXISTING WITHIN THE SUBDIVISION.
- 7. NO UNDERGROUND EXCAVATIONS EXIST WITHIN THE SUBDIVISION.
- 8. THE LAND SHOWN HEREON LIES ENTIRELY WITHIN FLOOD ZONE "X" (UNSHADED), BEING DESCRIBED AS "AREAS DETERMINED TO BE OUTSIDE THE 0.2% ANNUAL CHANCE FLOODPLAIN" PER INSURANCE RATE MAP (FIRM) - COMMUNITY PANEL NUMBER 06037C1725F, DATED SEPTEMBER 26, 2008.
- 9. THIS PROJECT WILL COMPLY WITH CITY PARK/LAND DEDICATION RESOLUTION NO. 89-200.
- 10. THE LAND SHOWN HEREON IS CATEGORIZED IN ZONING R-2S - LOW DENSITY MULTIPLE FAMILY (DENSITY RANGE: 7-15 UNITS/ACRE) AND LAND USE OF "RESIDENTIAL NEIGHBORHOOD" PER CITY OF POMONA GENERAL PLAN ANG ZONING.

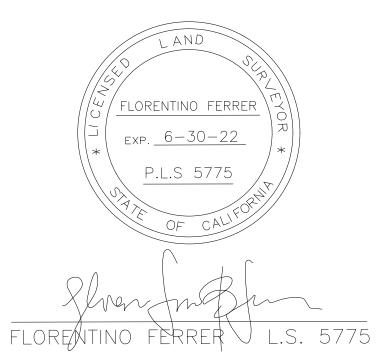

PER RS 68/4


TENTATIVE TRACT MAP 083188 IN THE CITY OF POMONA LOS ANGELES COUNTY, CALIFORNIA

BEING A SUBDIVISION OF LOT 5 IN BLOCK 7 OF POMONA HEIGHTS ADDITION, AS PER RECORDED IN BOOK 24 , PAGES 97 AND 98 OF MISCELLANEOUS RECORDS, IN THE OFFICE OF THE COUNTY RECORDER OF LOS ANGELES COUNTY

FOR CONDOMINIUM PURPOSES

FLORENTINO FERRER

JANUARY 2021

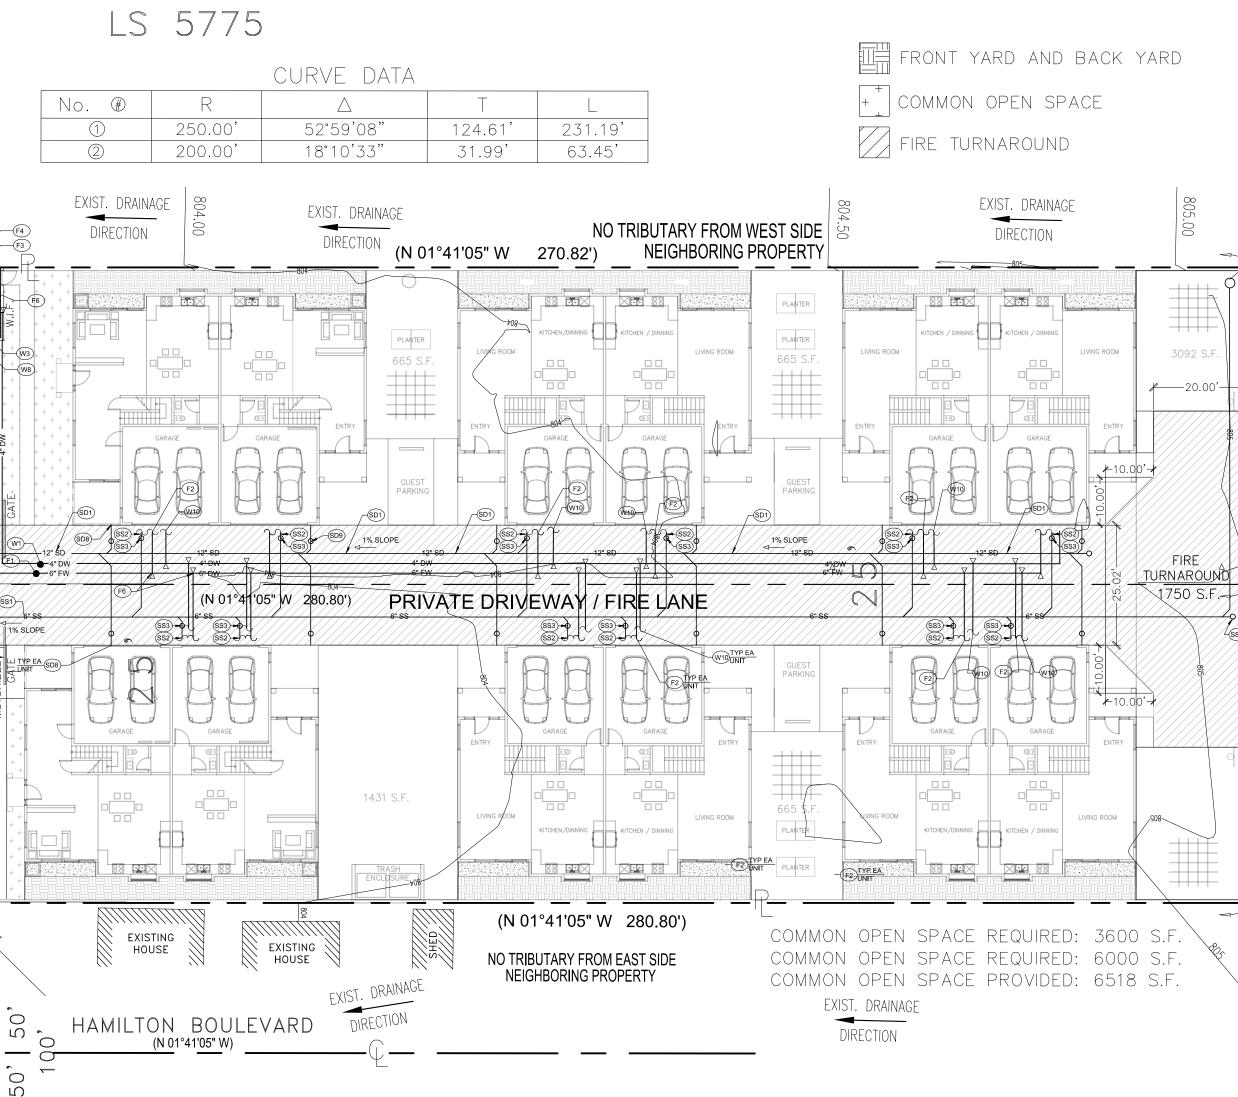

CONSTRUCTION NOTES

SANITARY SEWER

VCP OR PVC SANITARY SEWER PIPE. SIZE AND SLOPE PER (SS1 SS2 POINT OF CONNECTION 5 FEET FROM BUILDING FACE. SEE PLUMBING DRAWINGS FOR CONTINUATION (SS3) SEWER CLEANOUT PER CITY STANDARD. CONNECT TO MAIN SEWER LINE. CONTRACTOR TO SS4 COORDINATE WITH CITY OF PUBLIC WORKS FOR CONNECTION APPLICATION AND PERMIT PROCESS. (SS6) EXISTING SEWER MANHOLE. SS7 FOX DUAL VALVE FOR TRASH ENCLOSURE


DOMESTIC WATER

- (W1)4" PVC C-900 DOMESTIC WATER MAIN. SEE PLAN FOR SIZES.
- (W3)BACKFLOW PREVENTION DEVICE
- (W5) CONNECT TO EXISTING WATER MAIN.
- (W8) 4" DOMESTIC WATER METER ON 10'X15' EASEMENT AREA.
- (W10) POINT OF CONNECTION 5 FEET FROM BUILDING FACE. FIRE WATER
- (F1) PVC C-900 FIRE WATER LINE. 6" DIAMETER OR MATCH THE SIZE OF PIPE PER FIRE WATER CONSULTANT'S DESIGN, WHICHEVER IS LARGER.
- POINT OF CONNECTION 5 FEET FROM BUILDING FACE. SEE FIRE WATER CONSULTANT'S DRAWING FOR CONTINUATION.
- (F3) BACKFLOW PREVENTION DEVICE
- (F4) 6" WATER METER ON 10'X15' EASEMENT, ON 10'X15' EASEMENT AREA
- (F5) CONNECT TO EXISTING WATER MAIN.

STORM DRAIN

- (SD1) PVC, SCHEDULE 40 STORM DRAIN PIPE. SIZE AND SLOPE PER PLAN.
- (SD2) 36" WIDE x 4" PARKWAY DRAIN
- (SD8) CONNECT TO DOWNSPOUT
- (SD9) CLEAN OUT
- (SD12) BUBBLER STRUCTURE WITH SOLID GRATING

TOTAL TRIBUTARY AREA: A - TOTAL = 37,164 SF(NO ADDITIONAL TRIBUTARIES FROM ADJACENT PROPERTIES) PROPOSED IMP. AREA = 30,690 SF

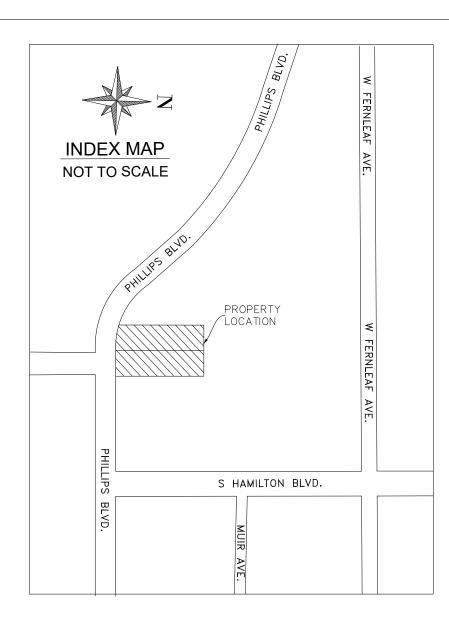

LEGAL DESCRIPTION:

LOT 1 (APN: 8343-012-015)

THE LAND REFERRED TO HEREIN BELOW IS SITUATED IN THE COUNTY OF LOS ANGELES, STATE OF CALIFORNIA AND IS DESCRIBED AS FOLLOWS:


LOT 5 IN BLOCK 7 OF POMONA HEIGHTS ADDITION, IN THE CITY OF POMONA, COUNTY OF LOS ANGELES STATE OF CALIFORNIA, AS PER MAP RECORDED IN BOOK 24, PAGES 97 AND 98 OF MISCELLANEOUS RECORDS, IN THE OFFICE OF THE COUNTY RECORDER OF SAID COUNTY.

EXCEPT THEREFROM THE WESTERLY 66 FEET THEREOF, SAID WESTERLY 66 FEET BEING MEASURED EASTERLY AT RIGHT ANGLES FROM THE WESTERLY LINE OF SAID LOT.

LOT 2 (APN: 8343-012-016)

THE LAND REFERRED TO HEREIN BELOW IS SITUATED IN THE COUNTY OF LOS ANGELES. STATE OF CALIFORNIA. AND IS DESCRIBED AS FOLLOWS:

THE WESTERLY 66 FEET OF LOT 5 IN BLOCK 7 OF POMONA HEIGHTS ADDITION IN THE CITY OF POMONA, COUNTY OF LOS ANGELES, STATE OF CALIFORNIA, AS PER MAP RECORDED IN BOOK 24, PAGES 97 AND 98, INCLUSIVE OF MISCELLANEOUS RIGHT ANGLES FROM THE WESTERLY LINE OF SAID LOT.

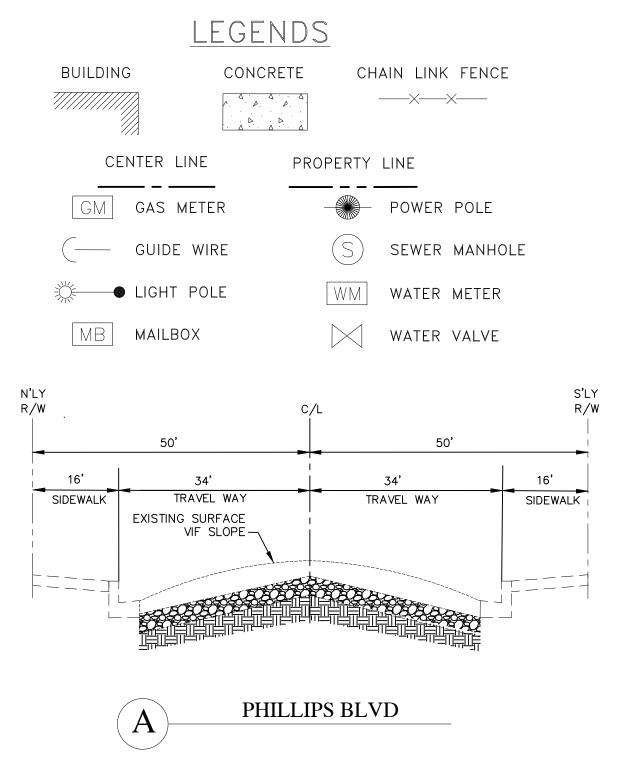

EXIST. DRAINAGE

DIRECTION TO

FFRNLEAF AVE

EXIST.

5

ONG P.L. TH SIDE


21'37" W OCK WALL AL

DRAINAGE DIRECTION TO

FERNLEAF AVE

DRAINAGE DIRECTION TO

FERNLEAF AVE

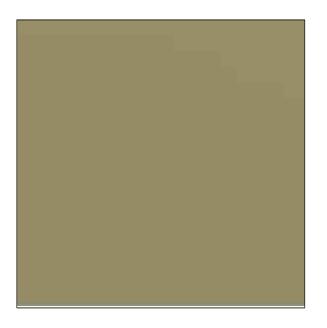

SHERWIN WILLIAMS HGTVHOME SERIES OUTERBANKS - HGSW3454



SHERWIN WILLIAMS **HGTVHOME SERIES** MEADOW SAGE - HGSW4041



MILGARD TUSCANY SERIES SINGLE HUNG WINDOW MATERIAL - VINYL COLOR - WHITE



MILGARD TUSCANY SERIES SLIDING WINDOW MATERIAL - VINYL COLOR - WHITE




OWENS CORNING ROOF SHINGLES - ESTATE GRAY




HONEYWELL WALL HUNG



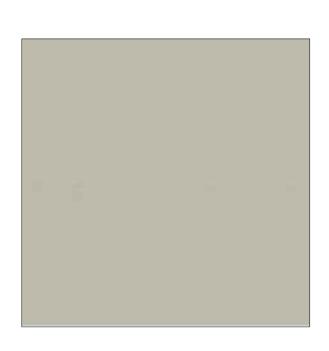


SHERWIN WILLIAMS HGTVHOME SERIES WINDSWEPT CLIFF - HGSW3226

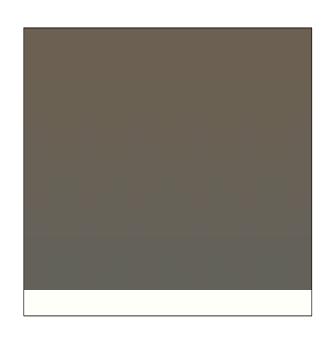

SHERWIN WILLIAMS HGTVHOME SERIES STONE STATUE- HGSW2462



MILGARD TUSCANY SERIES SLIDING DOOR MATERIAL - VINYL COLOR - WHITE

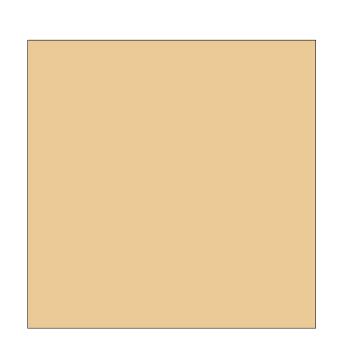


SHERWIN WILLIAMS **HGTVHOME SERIES**

MODELI# SS00AD010800



HAMPTON BAY MODEL #46240-300PS

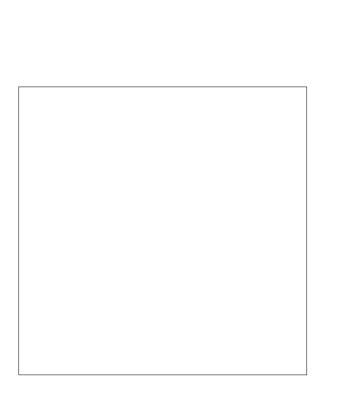

SHERWIN WILLIAMS HGTVHOME SERIES PURE WHITE - HGSW4006



DOYLE GOLD - HGSW 2146

SHERWIN WILLIAMS HGTVHOME SERIES JAGGED GRANITE - HGSW3226



MMI ENTRANCE DOOR MODEL# - Z019204R MATERIAL - FIBER GLASS COLOR - NAVAL

TRUST HILLS OCEANSIDE FION AT MOUNTAIN CREST 9 WEST PHILLIPS BLVD. COAST WEST ACE 766 RL 163 CONSULTANT JOB NO : DATE : 07-29-2021 1ST REV : DRAWN : JH/MS PLOTTED : -SCALE : AS SHOWN BOARD MATERIAL COLOR AND

NO. REVISION DATE

COLOR AND MATERIAL BOARD